HISTORIC LANDMARK COMMISSION JULY 30, 2012 NATIONAL REGISTER HISTORIC DISTRICT NRD-2012-0087 Rainey Street 73 Rainey Street

PROPOSAL

Demolish a 512 sq. ft. rear addition and construct a new 700 sq. ft. addition on a c. 1914 house.

PROJECT SPECIFICATIONS

The existing c. 1914 house is an approximately 1,220 sq. ft., one-story, Greek Revival cottage with a pyramidal roof form and partial width, inset front porch. The house has minimal Greek Revival details, such as the slender, un-fluted columns and simple frieze trim under the eaves. There are two entry doors from the front porch and two double-hung, wood windows on the façade. The porch has a low railing with turned spindles and the house is sided with narrow, drop siding, and has a composition shingle roof.

The applicant proposes to demolish a rear addition that appears to not be original to the house and construct a 700 sq. ft. side addition. The applicant further proposes to restore original features of the house, including the drop siding, and porch railings. The side addition as presented is a flat roofed structure with a parapet to shield proposed rooftop equipment. The proposed exterior finishes for the addition are antique brick veneer on the facade and rear walls, and hardi-plank siding on the side wall. The façade of the addition as shown features a large, multi-paned window. The proposal also includes a deck on the rear of the house with a canopy and an accessibility ramp on the side of the house.

STANDARDS FOR REVIEW

The existing property is listed as contributing to the Rainey Street National Register Historic District. The Rainey Street National Register Historic District has no specific design guidelines for rehabilitation and additions. Applicable general design review guidelines state:

- The distinguishing original qualities or character of a property and its environment shall not be destroyed. Removal or alteration of any historic material or distinctive architectural features should be avoided.
- All properties shall be recognized as products of their own time. Alterations which have no historical basis and which seek to create an earlier appearance shall be discouraged.
- Changes which have taken place in the course of time may have acquired significance in their own right, and shall be recognized and respected.
- Distinctive stylistic features or examples of skilled craftsmanship which characterize a property shall be treated with sensitivity.
- Deteriorated architectural features shall be repaired rather than replaced whenever possible. In the event replacement is necessary, the new material should match the material being replaced in composition, design, color, texture, and other visual

qualities. Repair or replacement of missing architectural features should be based on accurate duplications of features, substantiated by historical, physical, or pictorial evidence.

- Contemporary design for alterations and additions to existing properties are appropriate when such alterations and additions do not destroy significant historic, architectural, or cultural material and are compatible with the size, scale, color, material, and character of the property, neighborhood, or environment.
- Whenever, possible, new additions or alterations to structures shall be done in such a manner that if such additions or alterations were to be removed in the future, the essential form and integrity of the structure would not be impaired.
- The installation of protective or code-required mechanical systems shall be concealed
 whenever possible so as not to intrude upon or detract from the property's aesthetic
 and historical qualities except where concealment would result in the alteration or
 destruction of historically significant materials or spaces.

The rehabilitation of the original architectural materials and features of the house meets the general design guidelines, however the design and materials proposed for the addition are commercial in nature and are not compatible with the historic character of the house, nor the Rainey Street Historic District. Use of siding materials and building forms that reference the residential historic character would be more appropriate.

STAFF RECOMMENDATION

Release the building permit with the recommendation that the applicant work with staff to redesign the addition to have a more compatible appearance.

PHOTOS

See next page.



Picture 1 – Front facing Rainey Street




Picture 2 – North Face of Existing



Picture 3 – Rear of Building Facing Alley




Picture 4 – South Face of Building

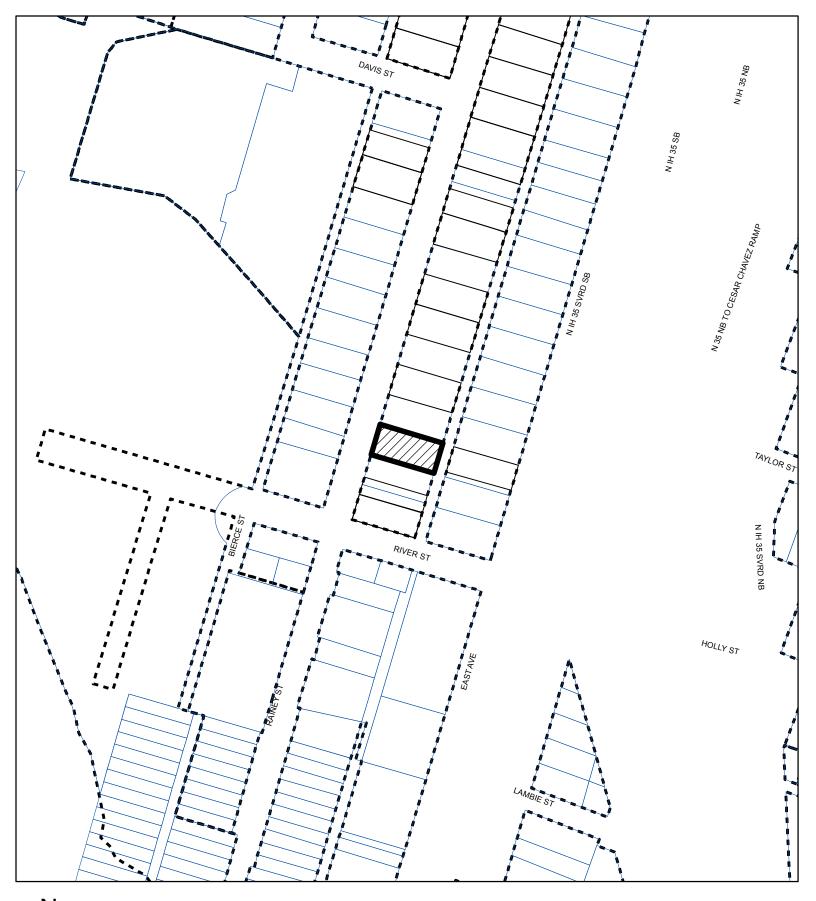



CASE#: NRD-2012-0087 LOCATION: 73 Rainey Street



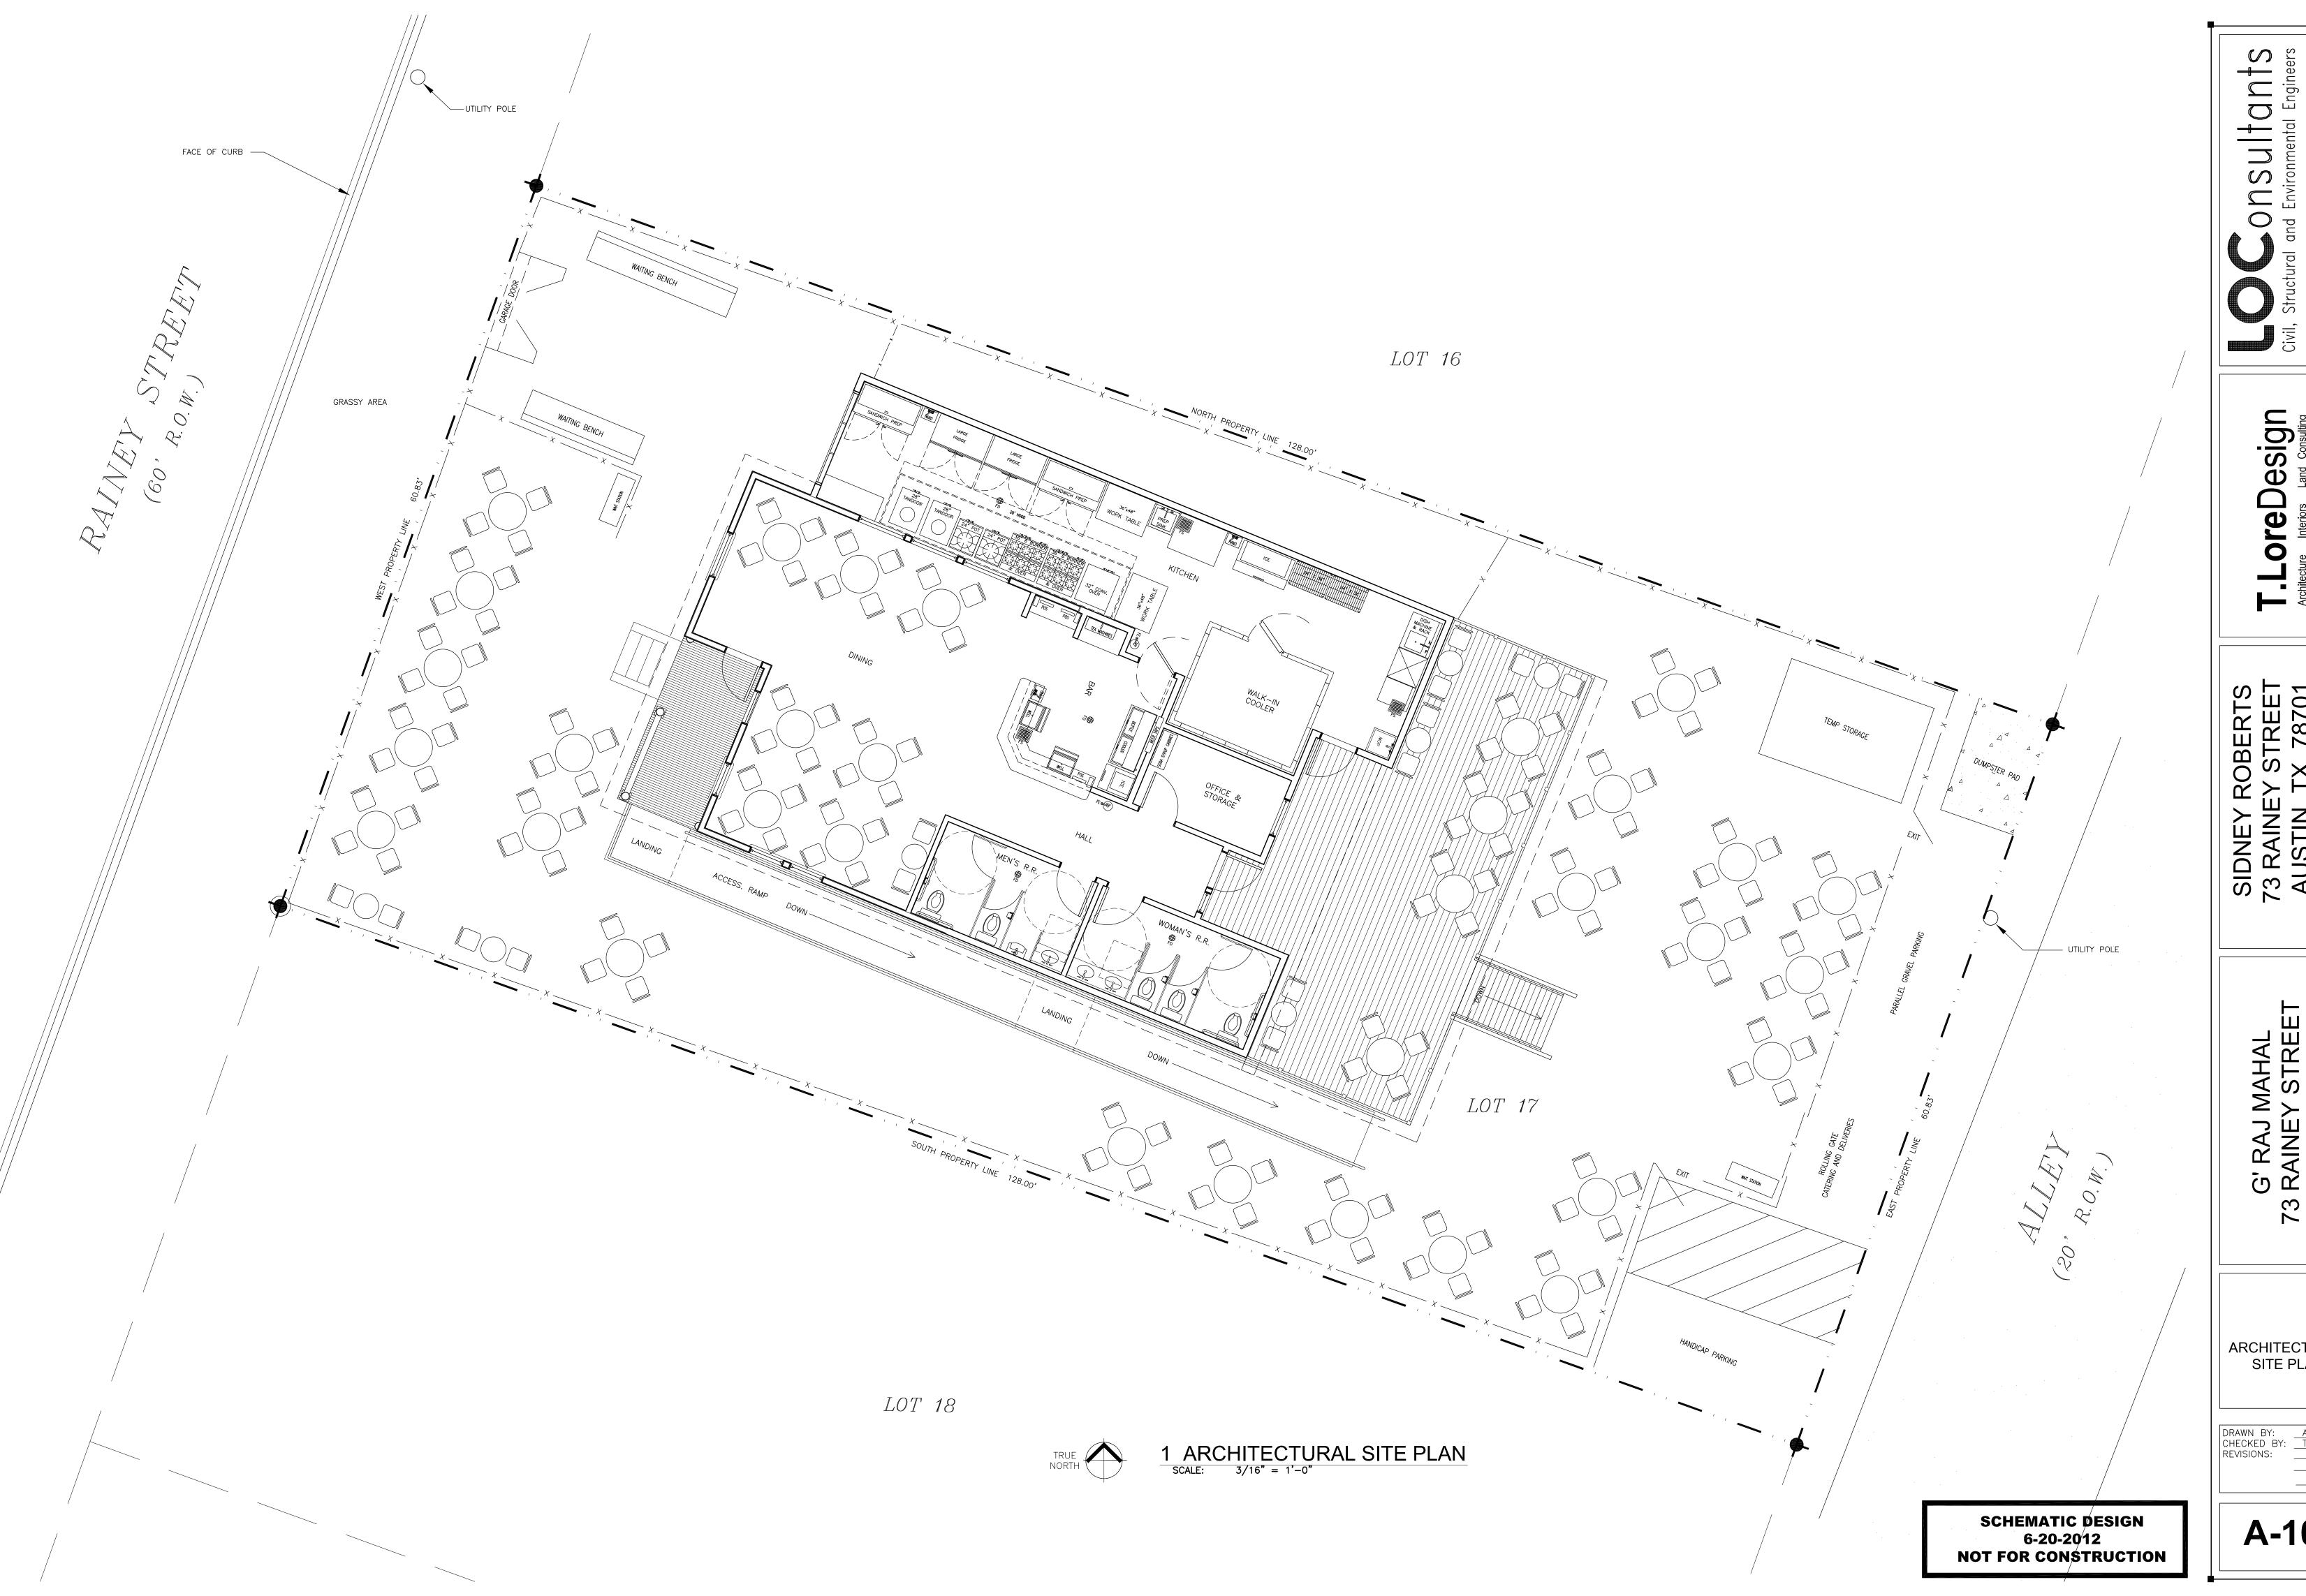


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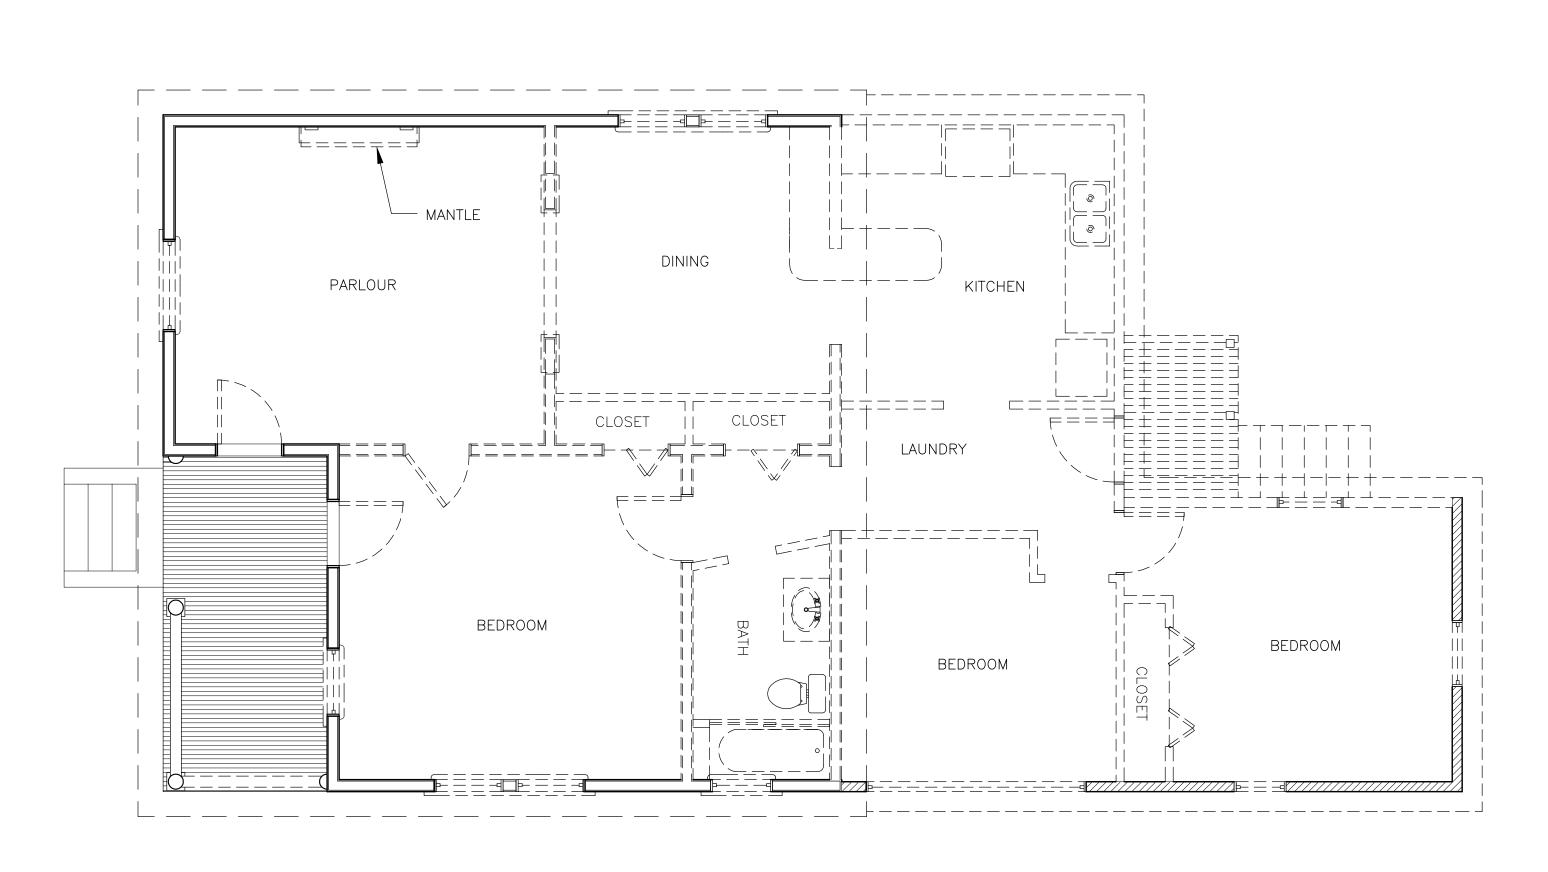
ARCHITECTURAL SITE PLAN

A-101



2 EXISTING FLOOR PLAN
SCALE: 1/4" = 1'-0"

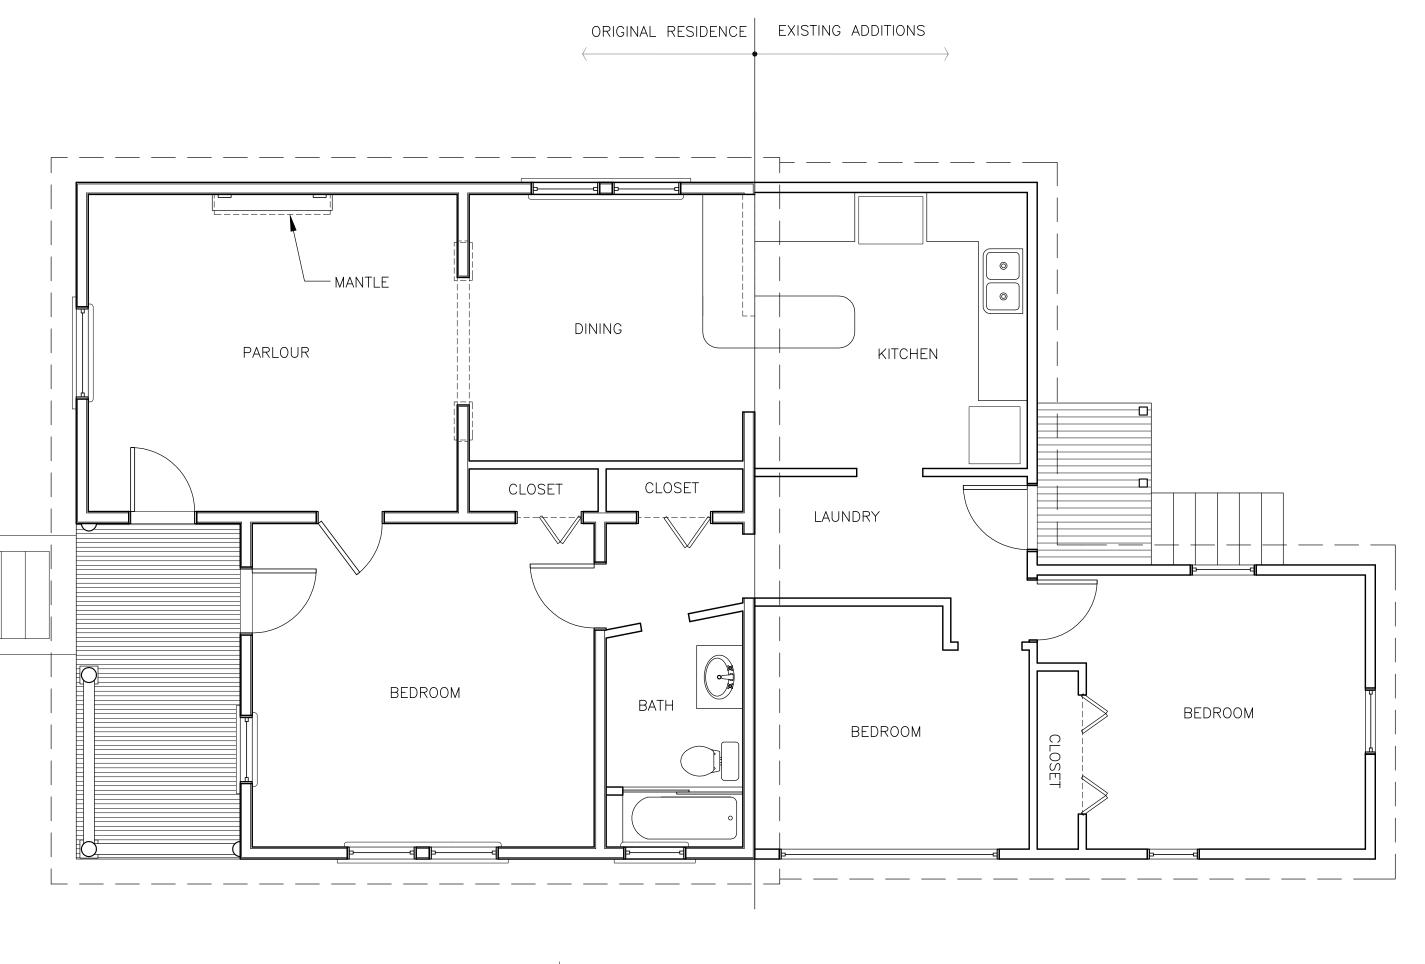LEGEND ORIGINAL WALLS TO REMAIN WALL FRAMING TO REMAIN ======== ITEMS TO BE DEMOLISHED



1 DEMOLITION PLAN
SCALE: 1/4" = 1'-0"

SCHEMATIC DESIGN 6-20-2012

NOT FOR CONSTRUCTION

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SIDNEY RC 73 RAINEY (AUSTIN, T) (218) 260

DEMOLITION PLAN

DRAWN BY: CHECKED BY: REVISIONS:

AD001

1 FLOOR PLAN
SCALE: 1/4" = 1'-0"

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FLOOR PLAN

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A-102

SCHEMATIC DESIGN 6-20-2012 NOT FOR CONSTRUCTION

1 ROOF PLAN
SCALE: 1/4" = 1'-0"

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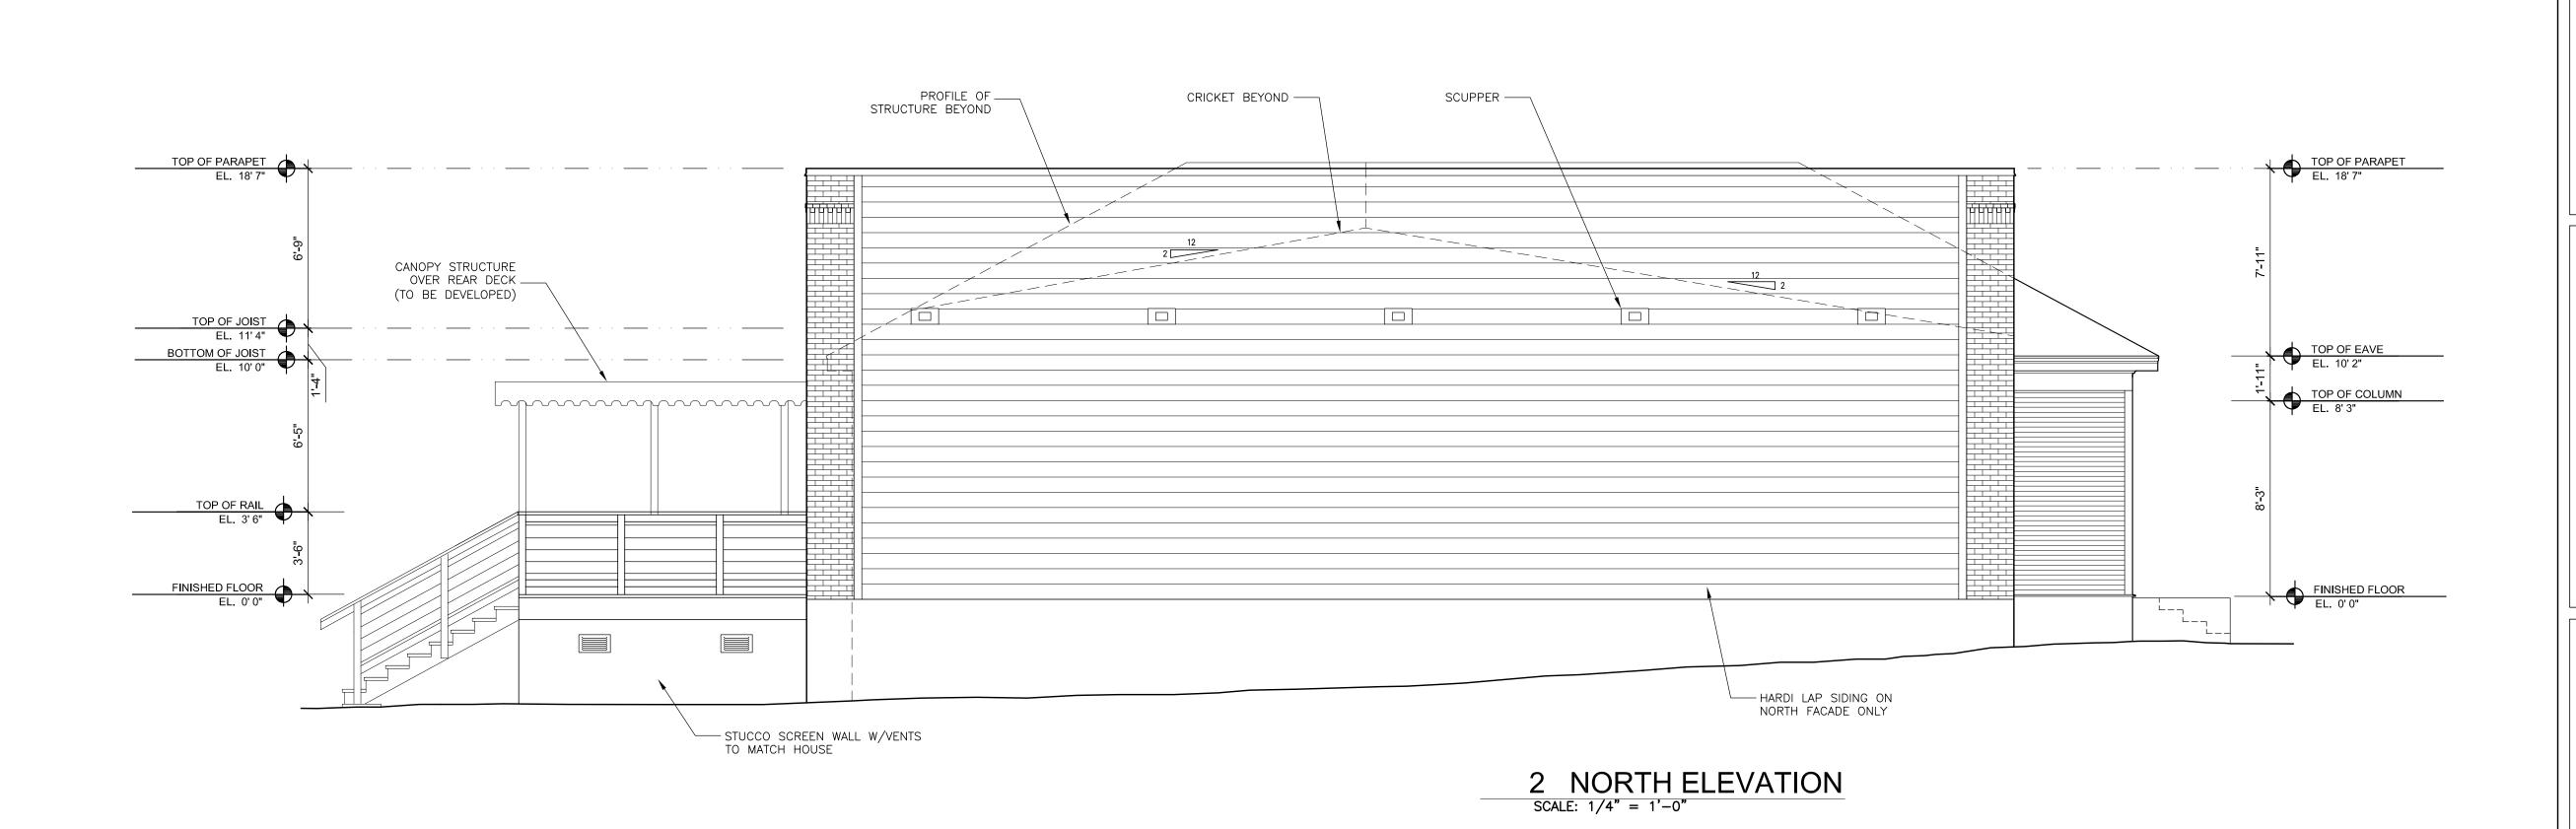
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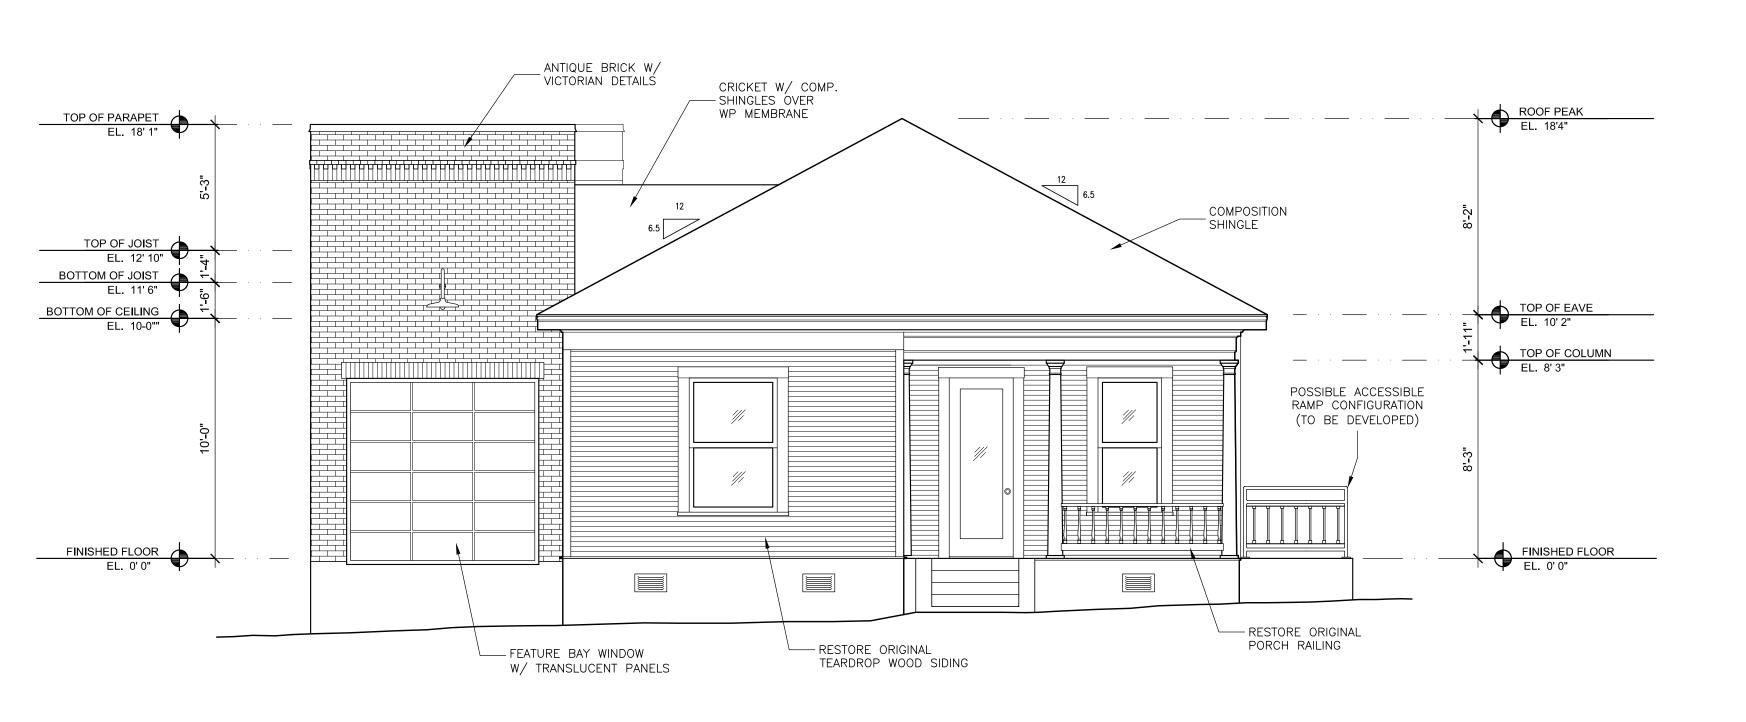
ROOF PLAN

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SCHEMATIC DESIGN 6-20-2012 NOT FOR CONSTRUCTION





1 WEST ELEVATION

SCALE: 1/4" = 1'-0"

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G' RAJ MAHAL 73 RAINEY STREET AUSTIN, TX. 78701


EXTERIOR ELEVATIONS

DRAWN BY: APL CHECKED BY: TO REVISIONS:

A-201

1. SOUTH ELEVATION

SCALE: 1/4" = 1'-0"

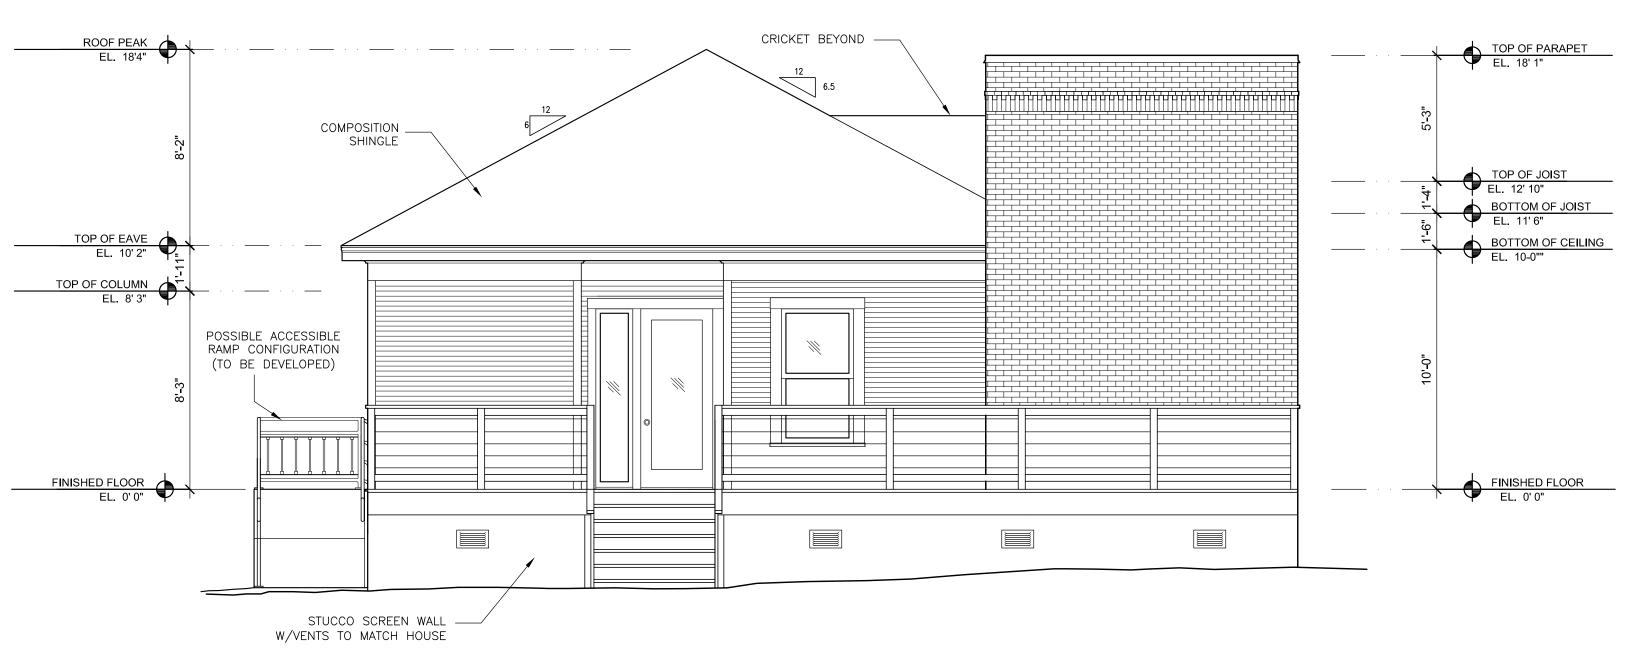

1. EAST ELEVATION

SCALE: 1/4" = 1'-0"

SCHEMATIC DESIGN 6-20-2012 NOT FOR CONSTRUCTION Civil, Structural and Environmental Engineer 1000 E. CESAR CHAVEZ ST. STE. 100 PH. (512) 499-090 AUSTIN, TEXAS 78702-4208

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EXTERIOR ELEVATIONS

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