HISTORIC LANDMARK COMMISSION OCTOBER 22, 2012 NATIONAL REGISTER HISTORIC DISTRICT NRD-2012-0114 Old West Austin 1704 W. 29th Street

PROPOSAL

Construct a new house on a vacant lot.

PROJECT SPECIFICATIONS

The applicant proposes to construct a new 2,629 sq. ft., two-story house and an 829 sq. ft., two-story, detached garage on a vacant lot. The house will be a contemporary design incorporating Craftsman style architectural features such as squared porch columns supported by battered piers, a faux knee brace in a gable peak, exposed rafter ends in the eaves of two dormers, and multiple siding materials including horizontal, board and batten and shingle siding. The windows on the front façade will have multiple panes and rustic-style shutters. Windows on the side and rear facades will be a combination of single and multi-paned. The house will have multiple hip and gable roof lines.

The detached garage will be located at the rear of the property and will be accessed from the street by a side loaded driveway. The garage will have architectural features and materials that are compatible with the main house and a carriage-style vehicle door. There will be second story conditioned space.

STANDARDS FOR REVIEW

The existing property is listed as contributing to the Old West Austin National Register Historic District. The Old West Austin National Register Historic District has no specific design guidelines for new construction. Applicable general design review guidelines state:

- The distinguishing original qualities or character of a property and its environment shall not be destroyed. Removal or alteration of any historic material or distinctive architectural features should be avoided.
- All properties shall be recognized as products of their own time. Alterations which
 have no historical basis and which seek to create an earlier appearance shall be
 discouraged.
- Changes which have taken place in the course of time may have acquired significance in their own right, and shall be recognized and respected.
- Distinctive stylistic features or examples of skilled craftsmanship which characterize a property shall be treated with sensitivity.
- Contemporary designs for alterations and additions to existing properties are appropriate when such alterations and additions do not destroy significant historic, architectural, or cultural material and are compatible with the size, scale, color, material, and character of the property, neighborhood, or environment.
- Whenever, possible, new additions or alterations to structures shall be done in such a manner that if such additions or alterations were to be removed in the future, the

essential form and integrity of the structure would not be impaired.

The installation of protective or code-required mechanical systems shall be concealed
whenever possible so as not to intrude upon or detract from the property's aesthetic
and historical qualities except where concealment would result in the alteration or
destruction of historically significant materials or spaces.

Demolition of an existing non-contributing building on this lot was approved administratively by staff July 25, 2012.

Although the new construction is replacing a non-contributing building and has a detached garage, its style and size is not compatible with other contributing properties on the block, most of which are one-story Minimal Traditional style homes. A one story or one and a half story design with simpler roof lines and architectural features would be more compatible with the historic architectural character of the neighborhood.

STAFF RECOMMENDATION

Release the building permit with the recommendation that the applicant revise the design to be more compatible with the neighborhood.

PHOTOS



New construction across from 1704 W. 29th Street



Contributing house on same block as 1704 W. 29th Street




Contributing houses on same block as 1704 W. 29th Street



Contributing house on same block as 1704 W. 29th Street



Non-contributing house on same block as 1704 W. 29th Street

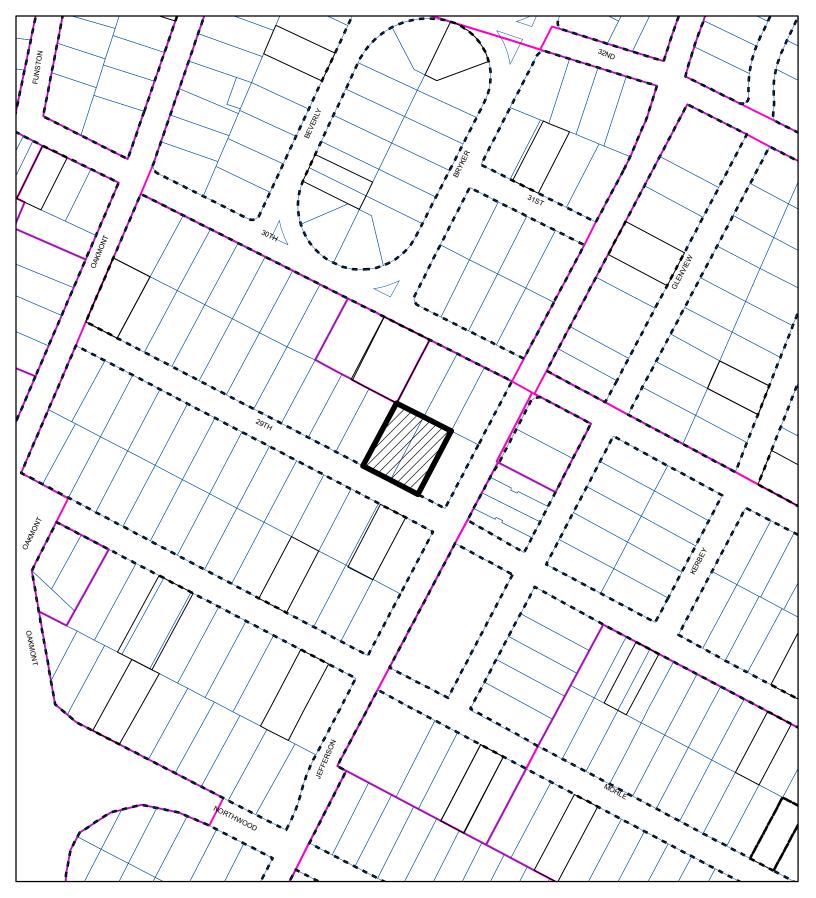




CASE#: NRD-2012-0114 LOCATION: 1704 W 29th Street



This product is for informational purposes and may not have been prepared for or be suitable for legal, engineering, or surveying purposes. It does not represent an on-the-ground survey and represents only the approximate relative location of property boundaries.

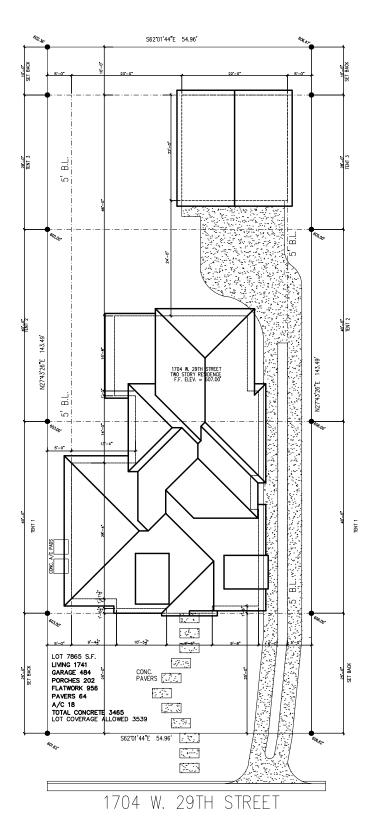

SITE PLAN


SCALE: 1" = 20"





DRAWN BY: DRWN

	SCALE: 1"=20'	DATE: 9,	/15/12	REVISED:	
	SUBDIVISION: BRYKER_WOODS				
I DO HEREBY CERTIFY THAT THIS DRAWING OR PLAN AND RELATED SPECIFICATIONS MEET ALL LOCAL	LOT: 24	BLOCK: 1	SECTION: C	JOB NO.	LOVE_RES.
CODE REQUIREMENTS AND ARE IN SUBSTANTIAL CONFORMITY WITH V.A. MINIMUM PROPERTY REQUIREMENTS.	ADDRESS: 1704_W29TH_STREET				
Bjorn O. Sefeldt V.A. ID No.VA1072HRO	COUNTY: TRAVIS			PLAN:	

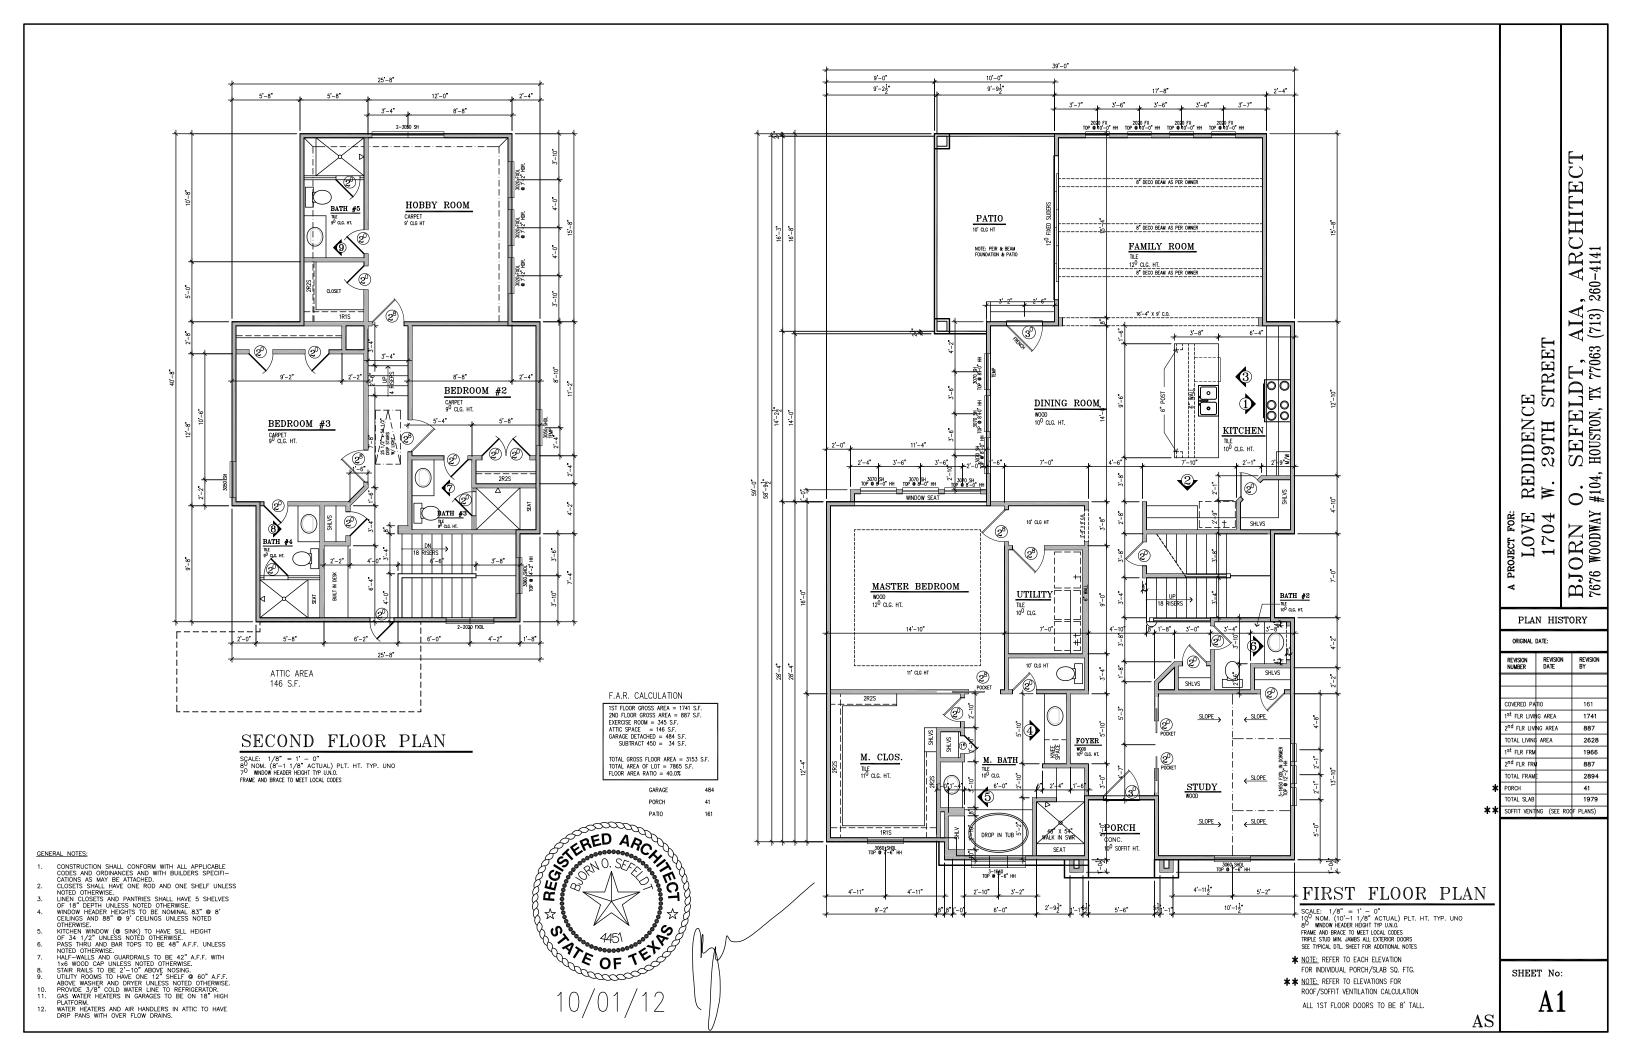

ELECTRICAL LEGEND

\$ _\$3 3-POLE SWITCH \$4 4-POLE SWITCH 0 LIGHT FIXTURE RE: FIXTURE SCHEDULE

(HD) HEAT DETECTOR/ALARM • SMOKE DETECTOR

CHIMES PUSH BUTTON

PHONE JACK TELEVISION JACK

• EXHAUST FAN HOSE BIBB

CEILING FAN

SWITCH TOP POLE ONLY 120v RECEPTACLE

ф 220v RECEPTACLE фGFI GROUND FAULT INTERRUPTOR WEATHER PROOF W/ GROUND FAULT INTERRUPTOR ∯ WPGFI

GARAGE DOOR SENSOR ⊢□S (CM)

HOME OFFICE WIRING

CATV

SD/CM


SMOKE AND CARBON MONOXIDE DETECTOR/ALARM

CARBON MONOXIDE DETECTOR/ALARM

LIGHTING FIXTURE SCHEDULE					
SYMBOL	FIXTURE	QUAN	MT. HT.	REMARKS	
A	SURFACE MOUNTED DISH				
В	PORCELAIN SOCKET EXPOSED BULB				
С	CEILING MOUNTED ENCLOSED FIXTURE				
D	HANGING FIXTURE				
E	2'x4' FLUOR. FIXTURE			4-40 W BULBS	
F	EXTERIOR WALL MOUNTED BRACKET		7'-0"		
G	EXTERIOR CEILING MOUNTED FIXTURE				
н	BATHROOM FOUR BULB STRIP FIXTURE		7'-0"	4-60 W BULBS	
J	BATHROOM THREE BULB STRIP FIXTURE		7'-0"	3-40 W BULBS	
К	RECESSED CAN			75W R40 LAMP	
L	FLOOD LIGHTS				
М	EXH FAN/LIGHT COMBO				
N	WALL WASHER FIXTURE				
Р	PORCELAIN SOCKET EXPOSED BULB, WALL MTD.				
Q	WATERPROOF RECESSED CAN				
R	1'x4' FLUOR FIXTURE			2-40 W BULBS	
S	EXTERIOR RECESSED CAN				
T	INTERIOR WALL MOUNTED BRACKET				
U	CHANDELIER			TO BE CHOSEN	
٧	EXHAUST FAN				
w	BATHROOM TWO BULB STRIP FIXTURE			2-40 W BULBS	
х	BATHROOM FIVE BULB STRIP FIXTURE			5-40 W BULBS	

9

GARAGE EXERCISE ROOM ELECTRICAL

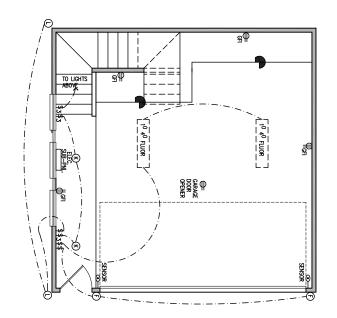

GARAGE ELECTRICAL

ELECTRICAL NOTES:

- ALL INSTALLATIONS TO BE IN ACCORDANCE WITH LOCAL CODES AND THE NATIONAL ELECTRICAL CODE

- 1. ALL INSTALLATIONS TO BE IN ACCORDANCE WITH LOCAL CODES AND THE NATIONAL ELECTRICAL CODE NFPA—70.

 2. THE ELECTRICAL CONTRACTOR IS RESPONSIBLE FOR OBTAINING ALL REQUIRED ELECTRICAL PERMITS AND INSPECTIONS.

 3. CONVENIENCE OUTLETS TO BE MOUNTED © 12" A.F.F. UNLESS NOTED OTHERWISE.

 4. OUTLETS MOUNTED ABOVE CABINETS OT BE 8" ABOVE THE NOMINAL WORKING SURFACE, SPECIALTY OUTLETS AS NOTED OR ACCORDING TO STANDARD PRACTICE.

 5. REFRIGEROR AND APPLIANCES OUTLETS TO BE PARACTICE.

 6. BATROON OUTLETS SHALL BE GFI AND MOUNTED PARACTICE.

 7. ALL OUTLETS WITHIN 6" OF WET AREA TO BE GFI.

 8. MICROWAVE OUTLETS SHALL BE G7I AND MOUNTED PARACTICE.

 8. MICROWAVE OUTLETS SHALL BE Z0 AMP. SEPARATE RECEPTIACLE © 78" A.F.F.

 9. SWITCH BOXES TO BE MOUNTED © 54" A.F.F. TO CENTER LINE OF BOX OR CLUSTER OF BOXES.

 10. ATTIC LIGHT SWITCH BOX MOUNTED © MAY A.F.F.

 11. ATTIC LIGHT SWITCH BOX MOUNTED © 4" A.F.F.

 12. WASHER TO HAVE SEPARATE 20 AMP. DUPLEX OUTLET CONVENIENT TO ACCESS.

 12. WASHER TO HAVE SEPARATE 220V 30 AMP. SINGLE OWNERNER OF AMP. SEPARATE ON THE TOP TO ACCESS.

 13. DRIVET TO HAVE SEPARATE 220V 30 AMP. SINGLE OWNERNER OF AMP. SEPARATE PARAMETER OF BOXES.

 14. ALL EXTERIOR OUTLETS TO BE GFI AND WEATHER PROTECTION.

 15. ALL EXTERIOR OUTLETS TO BE GFI AND WEATHER PROTECTION.

 16. TELEPHONE OUTLETS: PROVIDE BOX (MOUNT TYP. OF THE PROTECTION.

 17. ALL EXTERIOR OUTLETS: PROVIDE BOX (MOUNT TYP. OF THE PROTECTION.

 18. ALL EXTERIOR OUTLETS: PROVIDE BOX (MOUNT TYP. OF THE PROTECTION.

 19. ALL EXTERIOR OUTLETS: PROVIDE BOX (MOUNT TYP. OF THE PROTECTION.

 19. ALL EXTERIOR OUTLETS: PROVIDE BOX (MOUNT TYP. OF THE PROTECTION.

 20. ATTICE OF ROW OF THE PROVIDE BOX (MOUNT TYP. OF THE PROTECTION.


 21. ALL EXTERIOR OUTLETS: PROVIDE BOX (MOUNT TYP. OF THE PROTECTION.

 22. ALL EXTERIOR OUTLETS: PROVIDE BOX (MOUNT TYP. OF THE PROTECTION.

4'-0" 11'-0" 3'-0" 4'-0" SLOPE EXERCISE ROOM @ SLOPE SLOPE SLOPE 3⁰5⁰ SHDL @ 7⁰ HDR.

SECOND FLOOR PLAN

SCALE: 1/8" = 1' - 0" 80 NOM. (8'-1 1/8" ACTUAL) PLT. HT. TYP. UNO 70 WINDOW HEADER HIGHT TYP U.N.O. FRAME AND BRACE TO MEET LOCAL CODES

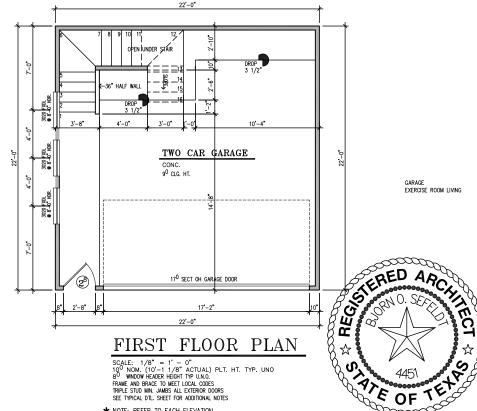

SCALE: 1/8" = 1' - 0" 10^0 NOM. (10'-1 1/8" ACTUAL) PLT. HT. TYP. UNO 8^0 WINDOW HEADER HEIGHT TYP U.N.O. FRAME AND BRACE TO MEET LOCAL CODES IRRIPE STUD MIN, JAMBS ALL EXTERIOR DOORS SEE TYPICAL DIL. SHEET FOR ADDITIONAL NOTES

- * NOTE: REFER TO EACH ELEVATION FOR INDIVIDUAL PORCH/SLAB SQ. FTG.
- ** NOTE: REFER TO ELEVATIONS FOR ROOF/SOFFIT VENTILATION CALCULATION

SEFELDT, / REDIDENCE W. 29TH ST BJORN 7676 WOODWAY PROJECT FOR: LOVE 1704

STREET

A, ARCHITEC) 260-4141

AIA (713)

O. #104,

PLAN HISTORY

ORIGINAL DATE:

REVISION REVISION NUMBER DATE

GARAGE EXERCISE ROOM LIVING

SHEET No:

A2

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GENERAL NOTES:


- CONSTRUCTION SHALL CONFORM WITH ALL APPLICABLE CODES AND ORDINANCES AND WITH BUILDERS SPECIFICATIONS AS MAY BE ATTACHED.
 CLOSETS SHALL HAVE ONE ROD AND ONE SHELF UNLESS NOTED OTHERWISE.
 LINEN CLOSETS AND PANTRIES SHALL HAVE 5 SHELVES OF 18" DEPTH UNLESS NOTED OTHERWISE.
 WINDOW HEADER HEIGHTS TO BE NOMBAL. 83" @ 8' CEILINGS AND 88" @ 9' CEILINGS UNLESS NOTED OTHERWISE.


- CELINGS AND 88° © 9° CEILINGS UNLESS NOTED OTHERWISE.
 KITCHEN WINDOW (@ SINK) TO HAVE SILL HEIGHT OF 34 1/2" UNLESS NOTED OTHERWISE.
 PASS THRU AND BAR TOPS TO BE 48" A.F.F. UNLESS NOTED OTHERWISE.
 HALF-WALLS AND GUARDRAILS TO BE 42" A.F.F. WITH 1%6 WOOD CAP UNLESS NOTED OTHERWISE.
 STAIR RAILS TO BE 2'-10" ABOVE NOSING.
 UTILITY ROOMS TO HAVE ONE 12" SHELF @ 60" A.F.F. ABOVE WASHER AND DRYER UNLESS NOTED OTHERWISE.
 PROVIDE 3/8" COLD WATER LINE TO REFRIGERATION.
 OF ATTORIM.

 PLATFORM.


 PLATFORM.

 WATER HEATERS IN GARAGES TO BE ON 18" HIGH WATER HEATERS IN GRADES TO MATE.
- PLAIFORM.
 WATER HEATERS AND AIR HANDLERS IN ATTIC TO HAVE DRIP PANS WITH OVER FLOW DRAINS.

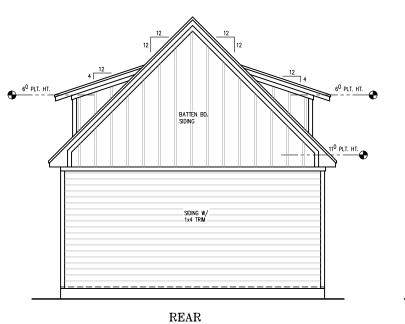


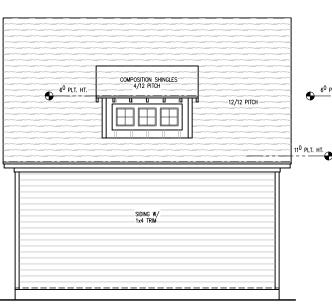


RIGHT

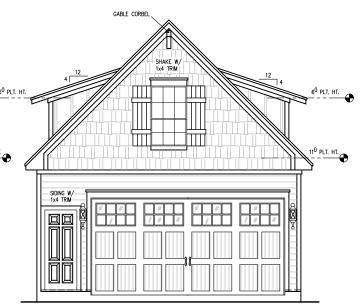

FRONT

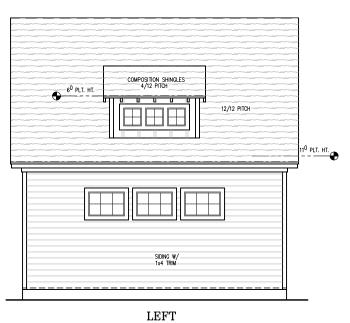

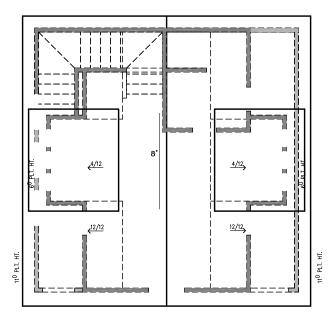

ATTIC VENTILATION (AUS/S.A.) SOX BY SOFFIT VENTS
50X BY ROOF VENTILATION
RIDGE VENTS ARE STANDARD LAYOUT W/ AIRHANKS
(SOLD) AS SUPPLEMENTAL VENTING, (IF REQUIRED).
DASHED AIRHANKS ARE OPTIONAL LAYOUT IN LEU
OF RIDGE VENTS. SOLD AIRHANKS TO BE COUNTED
FOR BOTH LAYOUTS. LEGEND: 12' \oplus V144 AIRHAWK () V144 AIRHAWK FOR OPTION V50 AIRHAWK \mathbb{K} V50 AIRHAWK FOR OPTION

ROOF/SOFFIT VENTILATION CALC: ATTIC ROOF AREA = 579 SQ.FT. REQUIRED TOTAL ATTIC VENTING = 579 SQ.FT. x 1/300= 278s.i. MAIN ROOF VENTING = 579 SQ.FT. x 1/600= 139s.i. SOFFIT VENTING = 579 SQ.FT. x 1/600= 139s.i.

PROVIDE 8 L.F. OF RIDGE VENT @ 18 s.i./f.t. = 144 0 [50 s.i.] AIR HAWKS =0 0 [144 s.i.] AIR HAWKS =0 -- OR --0 [50 s.i.] AIR HAWKS =0 1 [144 s.i.] AIR HAWKS =14

RAFTER LAYOUT

SCALE: 1/8" = 1'-0"


SCALE: //8 = 1-U
MOTES:

*ALL RAFTERS TO BE 2x6's @ 24"o.c. no.3 s.y.p.
UNLESS OTHERWISE NOTEO

*RIDGE, HIP, & VALLEY MEMBERS TO BE ONE SIZE
LARGER THAN RAFTERS


*FRAME & BRACE TO MEET LOCAL CODES

- * USE FURR STRIPS ON ALL SLOPE CEILINGS W/ 2x6 RAFTERS
- * ALL 2', 3', 4', 5', 6', 7', & 8' MEMBERS TO BE CUT FROM 16' LUMBER
- INDICATES SPLICE LOCATION

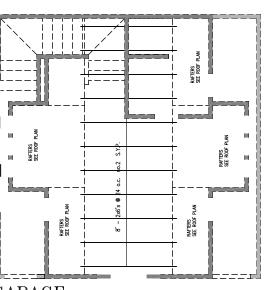

GARAGE SECOND FLOOR - JOIST LAYOUT

SCALE 1/8" = 1'-0"
2x6's @ 24"o.c. no. 2 SYP TYP U.N.O.
FRAME AND BRACE TO MEET LOCAL CODES
ALL BEAMS TO BE no.2 SYP TYP U.N.O.
S.B.=STRONGBACK 1-2X4,1-2X6 2X6 CUT FROM 16'ERS 3SYP
CUT 2'.3'.4',5'ERS FROM 16'ERS
CUT 6'ERS FROM 12'ERS,7'ERS FROM 14'ERS

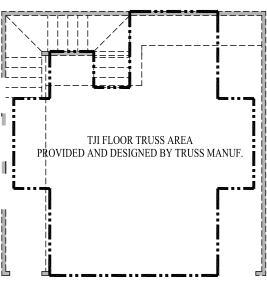

GARAGE FIRST FLOOR - JOIST LAYOUT

SCALE: 1/8" = 1'-0"

SCALE: 1/8" = 1'-0"

SCALE: 1/8" = 24"-0c. no. 2 SYP TYP U.N.O.

FRAME AND BRACE TO MEET LOCAL CO

ALL BEAMS TO BE no2 SYP TYP U.N.O. PE OF TET

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, ARCHITECT 260-4141


AIA, (713)

SEFELDT, / HOUSTON, TX 77063 (

STREET

SHEET No:

A3

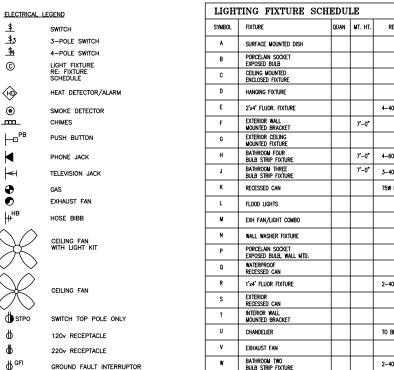

WEATHER PROOF W/ GROUND FAULT INTERRUPTOR

CARBON MONOXIDE DETECTOR/ALARM

GARAGE DOOR SENSOR

HOME OFFICE WIRING

∯ WPC

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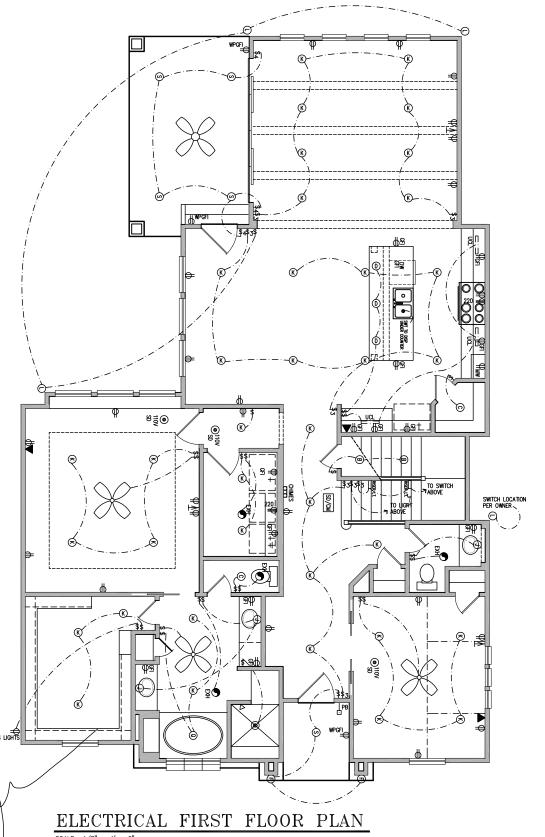
CATV

SD/CM

DL	FIXTURE	QUAN	MT. HT.	REMARKS
	SURFACE MOUNTED DISH			
	PORCELAIN SOCKET EXPOSED BULB			
	CEILING MOUNTED ENCLOSED FIXTURE			
	HANGING FIXTURE			
	2'x4' FLUOR. FIXTURE			4-40 W BULBS
	EXTERIOR WALL MOUNTED BRACKET		7'-0"	
	EXTERIOR CEILING MOUNTED FIXTURE			
	BATHROOM FOUR BULB STRIP FIXTURE		7'-0"	4-60 W BULBS
	BATHROOM THREE BULB STRIP FIXTURE		7'-0"	3-40 W BULBS
	RECESSED CAN			75W R40 LAMP
	FLOOD LIGHTS			
	EXH FAN/LIGHT COMBO			
	WALL WASHER FIXTURE			
	PORCELAIN SOCKET EXPOSED BULB, WALL MTD.			
	WATERPROOF RECESSED CAN			
	1'x4' FLUOR FIXTURE			2-40 W BULBS
	EXTERIOR RECESSED CAN			
	INTERIOR WALL MOUNTED BRACKET			
	CHANDELIER			TO BE CHOSEN
	EXHAUST FAN			
	BATHROOM TWO BULB STRIP FIXTURE			2-40 W BULBS
	BATHROOM FIVE BULB STRIP FIXTURE			5-40 W BULBS

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ALL INSTALLATIONS TO BE IN ACCORDANCE WITH LOCAL CODES AND THE NATIONAL ELECTRICAL CODE IN THE LECTRICAL CODE AND THE NATIONAL ELECTRICAL CODE IN THE COLOR OF THE NATIONAL COLOR OF THE NATIONAL COLOR OF THE NATIONAL COLOR OF THE NATIONAL WORKING TO BE MOUNTED © 12" A.F.F. UNILESS NOTED OF THE NATIONAL WORKING SURFACE, SPECIALTY OUTLETS AS NOTED OR ACCORDING TO STANDARD PRACTICE.

REFRIGERATOR AND APPLIANCES OUTLETS TO BE 04" A.F.F. COR 8" ABOVE COUNTER (IF HIGHER THAN STD. 2"-8").

ALL OUTLETS WITHIN 6" OF WET AREA TO BE GFI. MICROWAFE OUTLETS SHALL BE 20 AMP. SEPARATE WHICH COLOR STOP BOX MOUNTED 0 84" A.F.F. TO CENTER LINE OF BOX OR CLUSTER OF BOXES. ATTIC LIGHT SWITCH BOX MOUNTED 0 84" A.F.F. TO CENTER LINE OF BOX SWITCH SWITCH BOX MOUNTED 0 84" A.F.F. ATTIC LIGHT SWITCH BOX MOUNTED 0 84" A.F.F. ATTIC LIGHT SWITCH BOX MOUNTED 0 84" A.F.F. TO CENTER LINE OF BOX SWITCH SWITCH BOX MOUNTED 0 84" A.F.F. ATTIC LIGHT SWITCH BOX MOUNTED 0 84" A.F.F. ATTIC LIGHT SWITCH BOX MOUNTED 0 84" A.F.F. TO CENTER TO HAVE SEPARATE 20 AMP. SUPLEX OUTLET 0 44" A.F.F. DACESS. WASHER TO HAVE SEPARATE 220 V30 AMP. SINGLE OUTLET 10 GARGE TO BE GFI UNLESS NOTED FOR APPLIANCE.

ALL EXTERIOR OUTLETS TO BE GFI AND WEATHER PROTECTED.

ALL EXTERIOR COLLETS: PROVIDE BOX (MOUNT TYP.

PROTECTED:
TELEPHONE OUTLETS: PROVIDE BOX (MOUNT TYP.

12" A.F.F. OR 8" ABOVE COUNTER UNLESS
NOTED OTHERWISE), COVER PLATE, 6/C WIRE,
TERMINATE NEAR PANEL.

ELECTRICAL NOTES:

12.

SERED ARCX TE OF TE ELECTRICAL SECOND FLOOR PLAN

SHEET No:

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A4

, ARCHITECT 260-4141

AIA (713)

SEFELDT, 4, HOUSTON, TX 77063 (

O. #104,

BJORN (7676 WOODWAY

STREET


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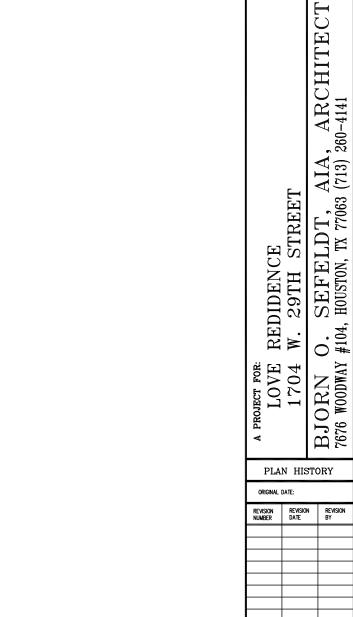
PROJECT FOR: LOVE 1704

ORIGINAL DATE:

REVISION REVISION NUMBER DATE

PLAN HISTORY




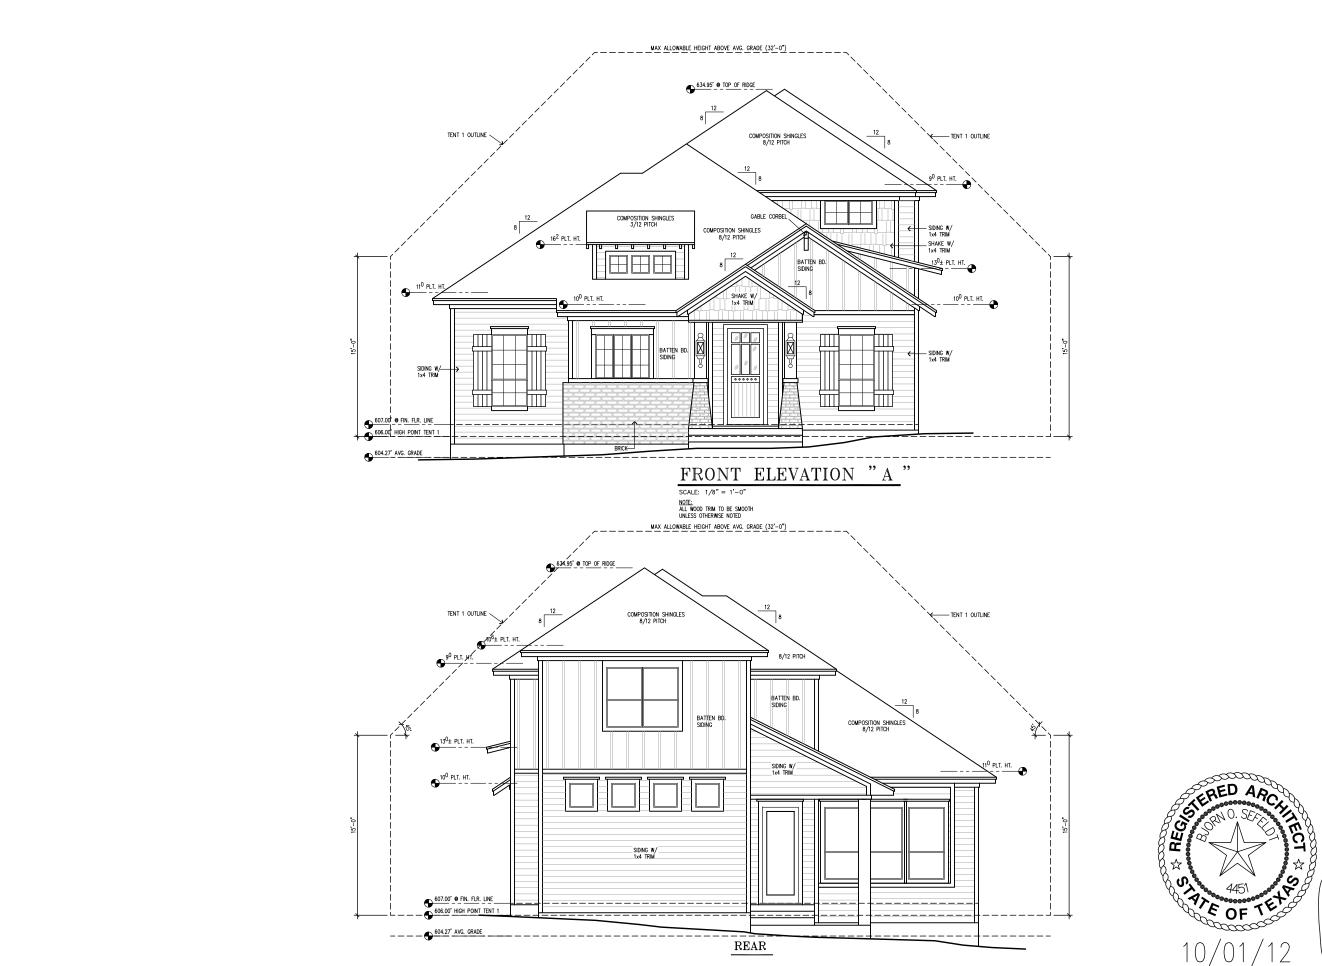


SHEET No:

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ATTIC VENTILATION (AUS/S.A.) 50% BY SOFFIT VENTS
50% BY SOFFIT VENTS
50% BY ROOF VENTILATION
RIDGE VENTS ARE STANDARD LAYOUT W/ AIRHAMMS
(SOLID) AS SUPPLEMENTAL VENTING, (IF REQUIRED),
DASHED AIRHAMMS ARE OPTIONAL LAYOUT IN LIEU
OF RIDGE VENTS. SOLID AIRHAMMS TO BE COUNTED
FOR BOTH LAYOUTS. LEGEND: 12' RIDGEVENT, NUMBER INDICATES LENGTH CALCULATED \oplus V144 AIRHAWK FOR OPTION V50 AIRHAWK V50 AIRHAWK FOR OPTION

ROOF/SOFFIT VENTILATION CALC:

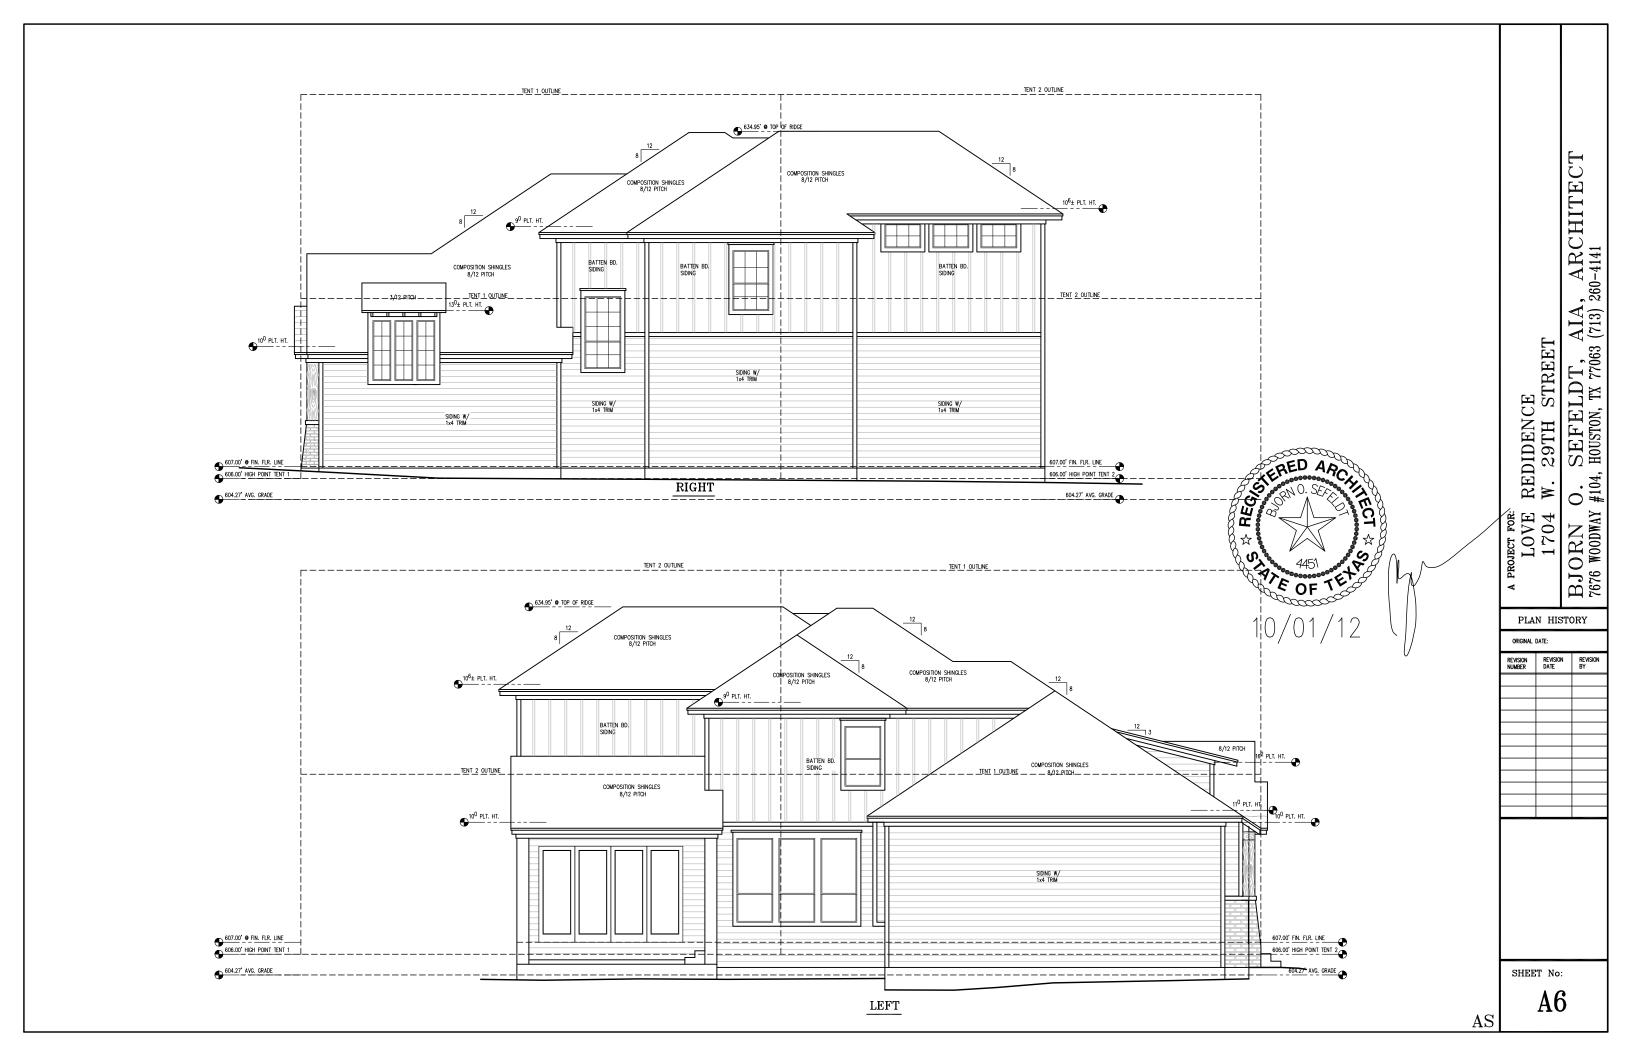ATTIC ROOF AREA = 2114 SQ.FT.

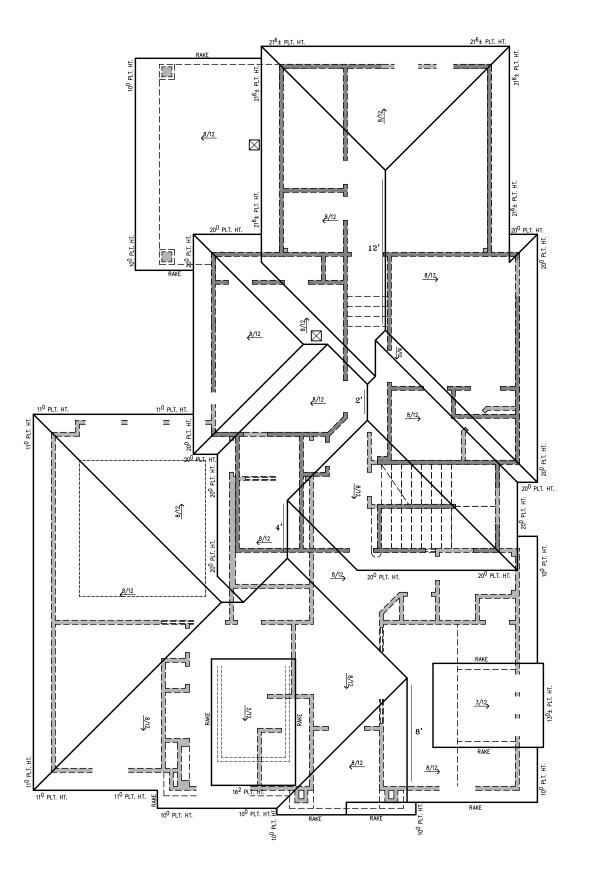REQUIRED

TOTAL ATTIC VENTING = 2114 SQ.FT. x 1/300= 1015s.i.

MAIN ROOF VENTING = 2114 SQ.FT. x 1/600= 507s.i.

SOFFIT VENTING = 2114 SQ.FT. x 1/600= 507s.i.

PROVIDE

28 LF. OF RIDGE VENT @ 18 s.i./f.t. = 504 1 [50 s.i.] AIR HAWKS =50 0 [144 s.i.] AIR HAWKS =0

-- OR --0 [50 s.i.] AIR HAWKS =0 4 [144 s.i.] AIR HAWKS =576

ATIIC ROOF AREA = 203 SQ.FT.
SECONDARY ATIIC VENTING @ PATIO= 203 SQ.FT. x 1/300= 97s.i.
ROOF VENTING = 203 SQ.FT. x 1/600= 49s.i.
SQ.FFIT VENTING = 203 SQ.FT. x 1/600= 49s.i.

PROVIDE


0 LF. OF RIDGE VENT @ 18 s.i./f.t. = 0 1 [50 s.i.] AIR HAWKS =50 0 [144 s.i.] AIR HAWKS =0

RAFTER LAYOUT

SCALE: 1/8" = 1'-0"

- SCALE: 1/8" = 1'-0"
 NOTES:

 *ALL RAFTERS TO BE 2x6'S 24"o.c. no.3 s.yp.
 UNLESS OTHERWISE NOTED
 RIDGE, HIP, & VALLEY MEMBERS TO BE ONE SIZE
 LARGER THAN RAFTERS
- * FRAME & BRACE TO MEET LOCAL CODES
- * USE FURR STRIPS ON ALL SLOPE CEILINGS W/ 2x6 RAFTERS
- * ALL 2', 3', 4', 5', 6', 7', & 8' MEMBERS TO BE CUT FROM 16' LUMBER
- INDICATES SPLICE LOCATION

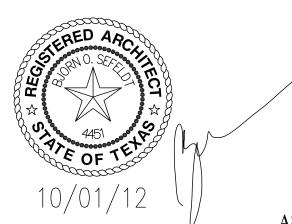

, ARCHITECT 260-4141 AIA, (713) SEFELDT, A REDIDENCE W. 29TH STREET O. #104, BJORN (7676 WOODWAY PROJECT FOR: LOVE 1704


PLAN HISTORY

ORIGINAL DATE:

REVISION NUMBER	REVISION Date	REVISION By

SHEET No:


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SECOND FLOOR - JOIST LAYOUT

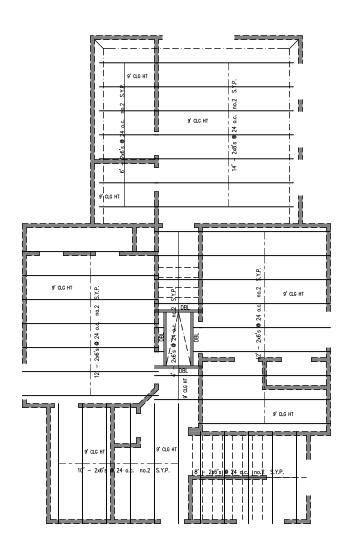SCALE: 1/8" = 1'-0"

SCALE: 1/



O. SEFELDT, AIA, ARCHITECT #104, HOUSTON, TX 77063 (713) 260-4141 REDIDENCE W. 29TH STREET BJORN (7676 WOODWAY 3 PROJECT FOR: LOVE 1704 PLAN HISTORY

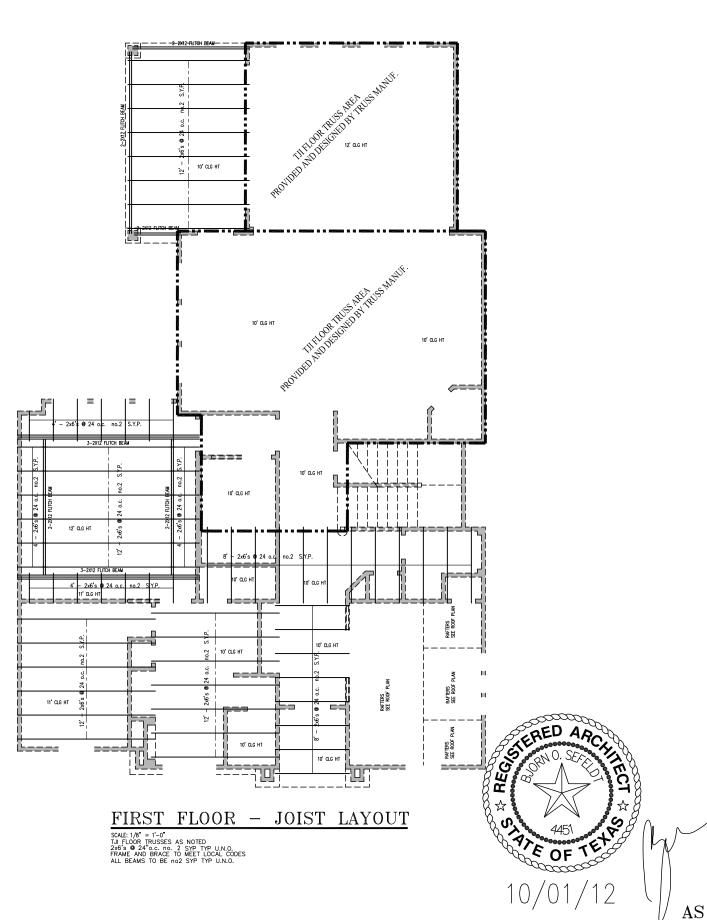REVISION REVISION NUMBER DATE

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