# HISTORIC LANDMARK COMMISSION DECEMBER 17, 2012 NATIONAL REGISTER HISTORIC DISTRICT NRD-2012-0137 Old West Austin 1619 Watchhill Road

#### PROPOSAL

Add dormers and a second story rear addition to a contributing house.

#### PROJECT SPECIFICATIONS

The existing house was constructed c. 1935. It is a one story, painted brick house with a side gable roof on the front section, and hipped and gable roofed additions on the rear. The rear gable roof addition was likely constructed in 1980.

The front elevation has a symmetrical design with a centered, projecting cross gable over the front door, which is flanked by two narrow, double hung windows. There is a decorative metal framed awning over the front door. To either side of the projecting entry are two double-hung windows. There is a tiled front patio with low painted brick columns with a decorative wrought-iron railing between.

The applicant proposes to add two dormers on the front roof elevation and construct a small rear one story and second story addition. The roof of the second floor addition will be minimally visible over the ridge of the existing front section roof, and the materials and architectural details of the additions will be compatible with the existing house.

#### STANDARDS FOR REVIEW

The house is listed as contributing to the Old West Austin National Register Historic District. Applicable general design review guidelines state:

- The distinguishing original qualities or character of a property and its environment shall not be destroyed. Removal or alteration of any historic material or distinctive architectural features should be avoided.
- All properties shall be recognized as products of their own time. Alterations which
  have no historical basis and which seek to create an earlier appearance shall be
  discouraged.
- Changes which have taken place in the course of time may have acquired significance in their own right, and shall be recognized and respected.
- Distinctive stylistic features or examples of skilled craftsmanship which characterize a property shall be treated with sensitivity.
- Contemporary design for alterations and additions to existing properties are appropriate when such alterations and additions do not destroy significant historic, architectural, or cultural material and are compatible with the size, scale, color, material, and character of the property, neighborhood, or environment.
- Whenever, possible, new additions or alterations to structures shall be done in such a manner that if such additions or alterations were to be removed in the future, the


essential form and integrity of the structure would not be impaired.


The location of the first and second story additions, at the back of the house and behind the front roof ridge line, make them minimally visible from the public right of way. The addition of the two dormers on the front roof slope, although an alteration to the front façade, is designed to be compatible with the architecture of the house, and is a minor change to the front elevation. The design as proposed maintains the property's contributing status.

#### STAFF RECOMMENDATION

Release the permit per the proposed design.

### Рното

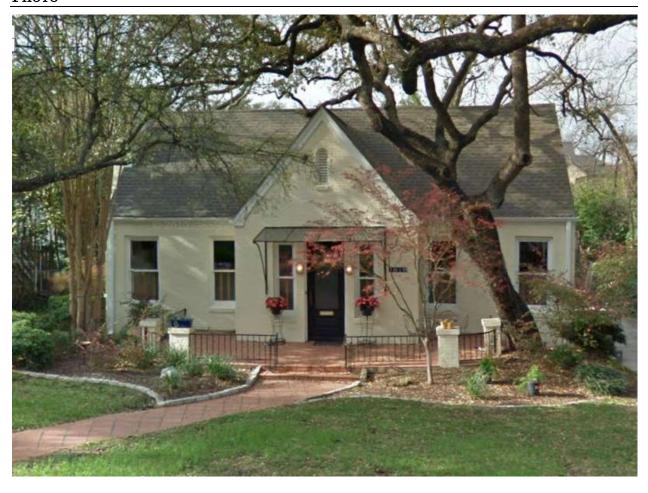

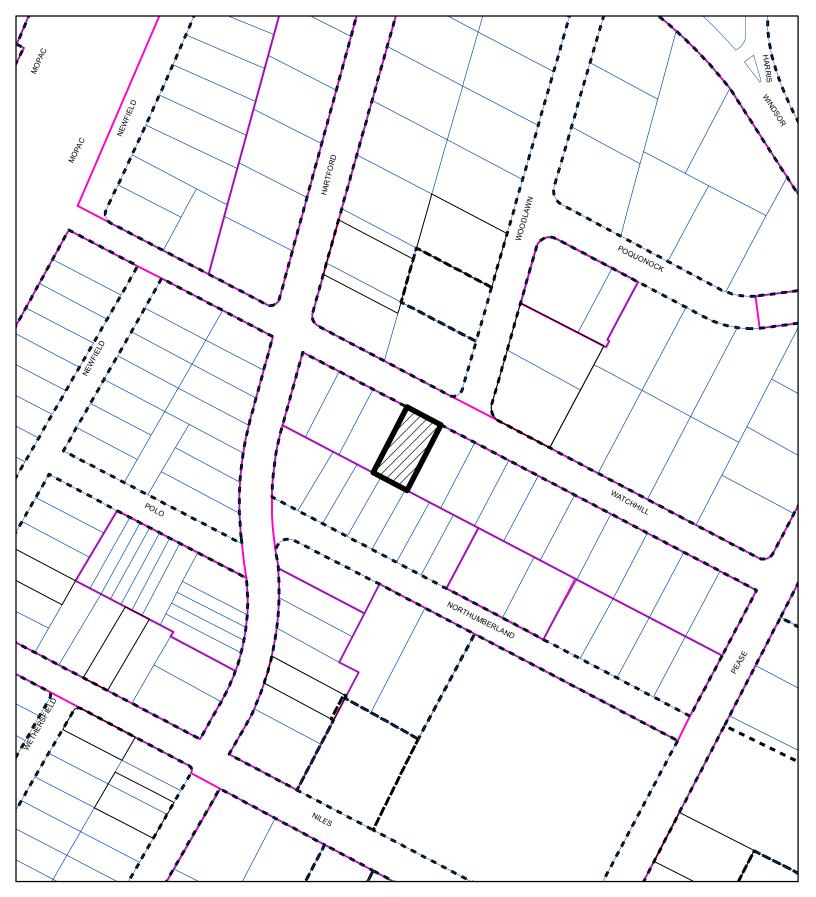



CASE#: NRD-2012-0137 LOCATION: 1619 Watchhill Road




This product is for informational purposes and may not have been prepared for or be suitable for legal, engineering, or surveying purposes. It does not represent an on-the-ground survey and represents only the approximate relative location of property boundaries.

## 8 1/2x11@ 1/20

LIST OF	DRAWINGS	GENERAL CONDITIONS  A. SUMMARY OF WORK			
A-0	RENDERING	ALL CONSTRUCTION TO BE PERFORMED IN A GOOD WORKMANSHIP LIKE			
A-1	SITE PLAN	MANNER ACCORDING TO THE A.I.A. GENERAL CONDITIONS, ALL APPLICABLE			
A-2	FIRST FLOOR PLAN	CODES AND GENERALLY ACCEPTED BUILDING PRACTICES,			
A-3	SECOND FLOOR PLAN	AS REQUIRED TO CONSTRUCT A COMPLETE PROJECT.			
A-4	ELEVATIONS	2. CONTRACTOR TO VERIFY ALL DIMENSIONS ON THE JOB BEFORE ORDERING			
A-5	ELEVATIONS	ANY MATERIALS OR COMMENCING WITH ANY WORK.			
A-6	ROOF PLAN	3. CONTRACTOR TO NOTIFY THE ARCHITECT AND OWNER OF ANY			
A-7	FOUDATION PLAN	DISCREPANCIES IN THE PLANS, SPECIFICATIONS, OR ACTUAL CONDITIONS			
A-8	SECOND FLOOR FRAMING PLAN	THAT AFFECT THE CONSTRUCTION COST OR EXECUTION.			
A-9	BUILDING SECTON	4. CONTRACTORS ARE TO OBTAIN AND PAY FOR ANY BUILDING PERMITS.			
A-10	BUILDING SECTON	5. CONTRACTORS TO EXECUTE THE CONSTRUCTION AS REQUIRED TO GET ALL			
A-11	WALL SECTION	GREEN TAGS AND CERTIFICATE OF OCCUPANCY.			
A-12	INTERIOR ELEVATIONS	6. SUBSTITUTIONS FOR PRODUCTS OF EQUAL QUALITY TO BE APPROVED BY			
AE-1	FIRST FLOOR ELECTRICAL	THE OWNER AND ARCHITECT PRIOR TO INSTALLATION IN WRITING.			
AE-2	SECOND FL. ELECTRICAL	7. PROVIDE SAMPLES OR MOCK-UPS OF ALL MATERIALS TO BE SELECTED.  8. CONTRACTORS TO REMOVE ALL THEIR DEPRIS FROM THE SITE LEAVING			
		8. CONTRACTORS TO REMOVE ALL THEIR DEBRIS FROM THE SITE, LEAVING			
		THE PROJECT CLEAN AND ALL INSTALLATIONS IN OPERATING CONDITION.			
		9. CONTRACTOR TO PROVIDE TEMPORARY SANITARY FACILITIES.  10. OWNER TO PROVIDE AND PAY FOR TEMPORARY UTILITIES.			
		B. ALTERNATES AND CHANGE ORDERS			
		1. TO BE APPROVED BY OWNER AND ARCHITECT PRIOR TO INSTALLATION.      2. ALL CHANGE ORDERS TO BE IN WRITING.			
		3. DESCRIBE ALL CHANGES AS TO CHANGE IN CONSTRUCTION, MATERIAL,			
		COST, AND CONSTRUCTION TIME EXTENSION OR REDUCTION.			
		C. INSURANCE			
		1. PROVIDE BUILDERS RISK.			
		2. PROVIDE GENERAL LIABILITY.			
		3. PROVIDE WORKERS COMP.			
		D. MAINTENANCE AND WARRANTIES			
		PROVIDE GENERAL CONST. WARRANTY FOR ONE YEAR FROM COMPLETION.  2. PROVIDE RELEASE OF LIENS FOR LABOR AND MATERIALS FROM ALL			
		SUPPLIERS AND ALL SUB CONTRACTORS.			
		3. PROVIDE ALL EQUIPMENT WARRANTIES.			
UTILITIES		SITE WORK			
A. SERVICE		A. SUBSURFACE INVESTIGATION AND SURVEY BY OWNER, SEE CIVIL.			
	OVERHEAD TO REMAIN.	1. OWNER TO PROVIDE SURVEY DESCRIBING MEETS AND BOUNDS.			
	ON REQUIRED	EASEMENTS, SET BACKS, BUILDINGS, AND EXISTING TREES.			
2. WATER: EXISTING		2. CONTRACTOR TO PROVIDE SLAB SURVEY CERTIFYING THAT ALL BUILDINGS			
	EXISTING TO REMAIN.	DO NOT ENCROACH INTO SET BACKS OR EASEMENTS.			
3. WASTE WATER: E		B. SITE PREP AND GRADING.			
3. GAS: EXISTING TO	D REMAIN.	1. ROUGH GRADE AND FILL ALL EXCAVATED AREAS AS REQUIRED TO ALLOW			
		SURFACE WATER TO DRAIN AWAY FROM BUILDINGS AT ALL TIMES DURING CONS			
		2. EXCAVATE SWALE AS REQUIRED TO DIVERT SURFACE WATER AROUND			
		FROM FRONT/EAST TO SIDE/NORTH, SEE SITE PLAN.			
		DIVERT SURFACE WATER AWAY FROM BUILDING AS REQUIRED.			
		3. FINISH GRADE AT ALL LANDSCAPED AREAS WITH A MINIMUM OF 4" OF			
		SANDY LOAN TOP SOIL AS REQUIRED TO RECEIVE PLANTINGS.			
		C. UTILITIES: SEE SITE PLAN			
		C. UTILITIES: SEE SITE PLAN D. LANDSCAPE			
		C. UTILITIES: SEE SITE PLAN  D. LANDSCAPE  1. TREES, EXISTING TO REMAIN AND PROTECTED AT ALL TIMES. SEE SITE PLA			
		C. UTILITIES: SEE SITE PLAN  D. LANDSCAPE  1. TREES, EXISTING TO REMAIN AND PROTECTED AT ALL TIMES. SEE SITE PLA  MINIMUM 6' FENCE AT ALL DRIP LINES TO PROTECT DURING CONSTRUCTION			
		C. UTILITIES: SEE SITE PLAN  D. LANDSCAPE  1. TREES, EXISTING TO REMAIN AND PROTECTED AT ALL TIMES. SEE SITE PLA  MINIMUM 6' FENCE AT ALL DRIP LINES TO PROTECT DURING CONSTRUCTION  FOR LOCATION AND DETAILS.			
		C. UTILITIES: SEE SITE PLAN  D. LANDSCAPE  1. TREES, EXISTING TO REMAIN AND PROTECTED AT ALL TIMES. SEE SITE PLA  MINIMUM 6' FENCE AT ALL DRIP LINES TO PROTECT DURING CONSTRUCTIO  FOR LOCATION AND DETAILS.  2. TREE PROTECTION TO CONFORM TO ALL CITY ORDINANCES AS REQUIRED.			
		C. UTILITIES: SEE SITE PLAN  D. LANDSCAPE  1. TREES, EXISTING TO REMAIN AND PROTECTED AT ALL TIMES. SEE SITE PLA  MINIMUM 6' FENCE AT ALL DRIP LINES TO PROTECT DURING CONSTRUCTIO  FOR LOCATION AND DETAILS.  2. TREE PROTECTION TO CONFORM TO ALL CITY ORDINANCES AS REQUIRED.  E. PAVING AND SURFACING:			
		C. UTILITIES: SEE SITE PLAN  D. LANDSCAPE  1. TREES, EXISTING TO REMAIN AND PROTECTED AT ALL TIMES. SEE SITE PLA  MINIMUM 6' FENCE AT ALL DRIP LINES TO PROTECT DURING CONSTRUCTION  FOR LOCATION AND DETAILS.  2. TREE PROTECTION TO CONFORM TO ALL CITY ORDINANCES AS REQUIRED.			

## 8 1/2x11@ 1/20

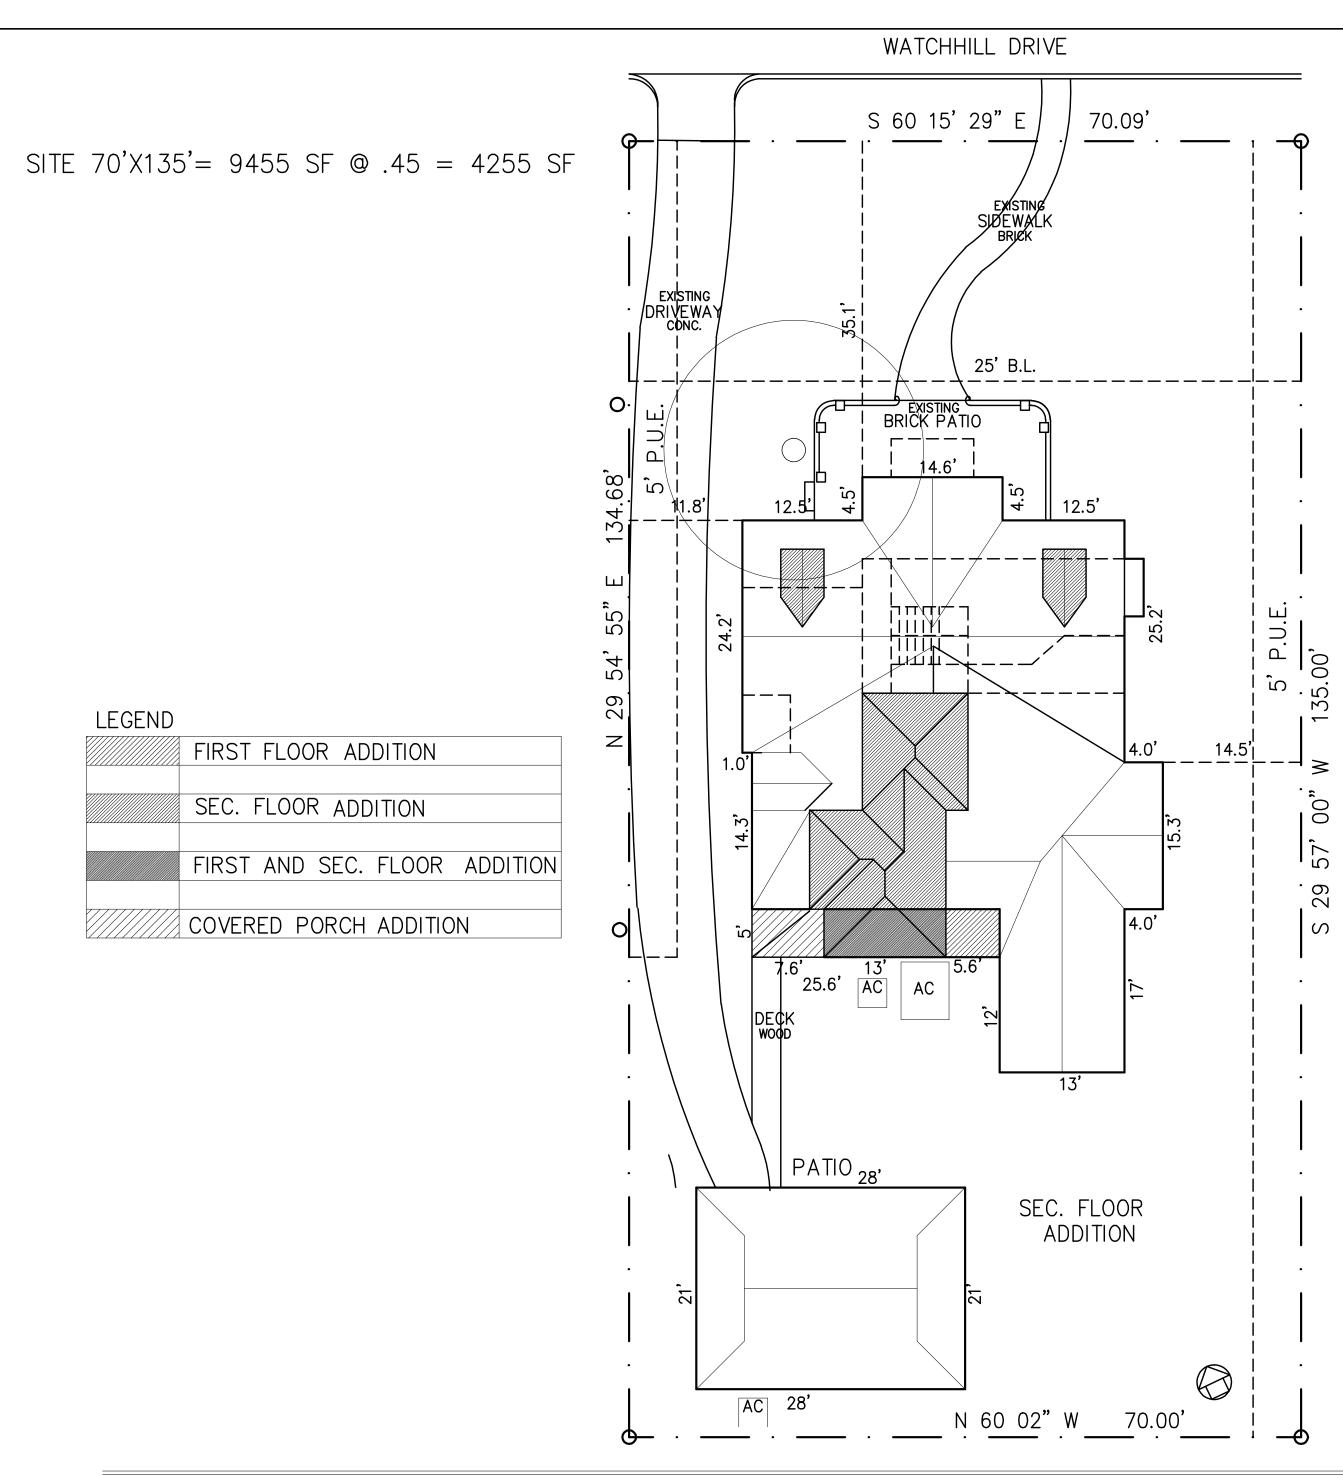


TOT. BLDG. COVER	=32.5% +220=	=   /	(475 SF)	<3,548 SF≠	37.5% OF	9455 SF
DRIVEWAY		915 SF		915 SF		
SIDEWALKS		114 SF		114 SF		
UNCOVERED PATIO		222 SF		222 SF		
UNCOVERED DECK	@ 50% ALLOWED		67 SF	67 SF		
AC PADS		50 SF		50 SF		
TOT. IMPERVIOUS	(@ 45%=4,255 SF)	3,909 SF	198 SF	4,107 SF =	=37.5% 94	55 SITE

LEGAL: LOT 10 PEASE ESTATES SUBDIVISION, TRAVIS, COUNTY





HOLLAND
ARCHITECTURAL
1413 PRESTON AVE
AUSTIN, TEXAS 78703
512-478-6554


CHRISTIAN RESIDENCE
1619 WATCHHILL ROAD
AUSTIN, TEXAS 78703
SCALE 1" = 20'-0"

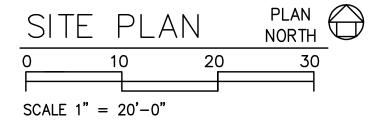



SHEET NO. <u>A1</u> DEC. 4, 2012

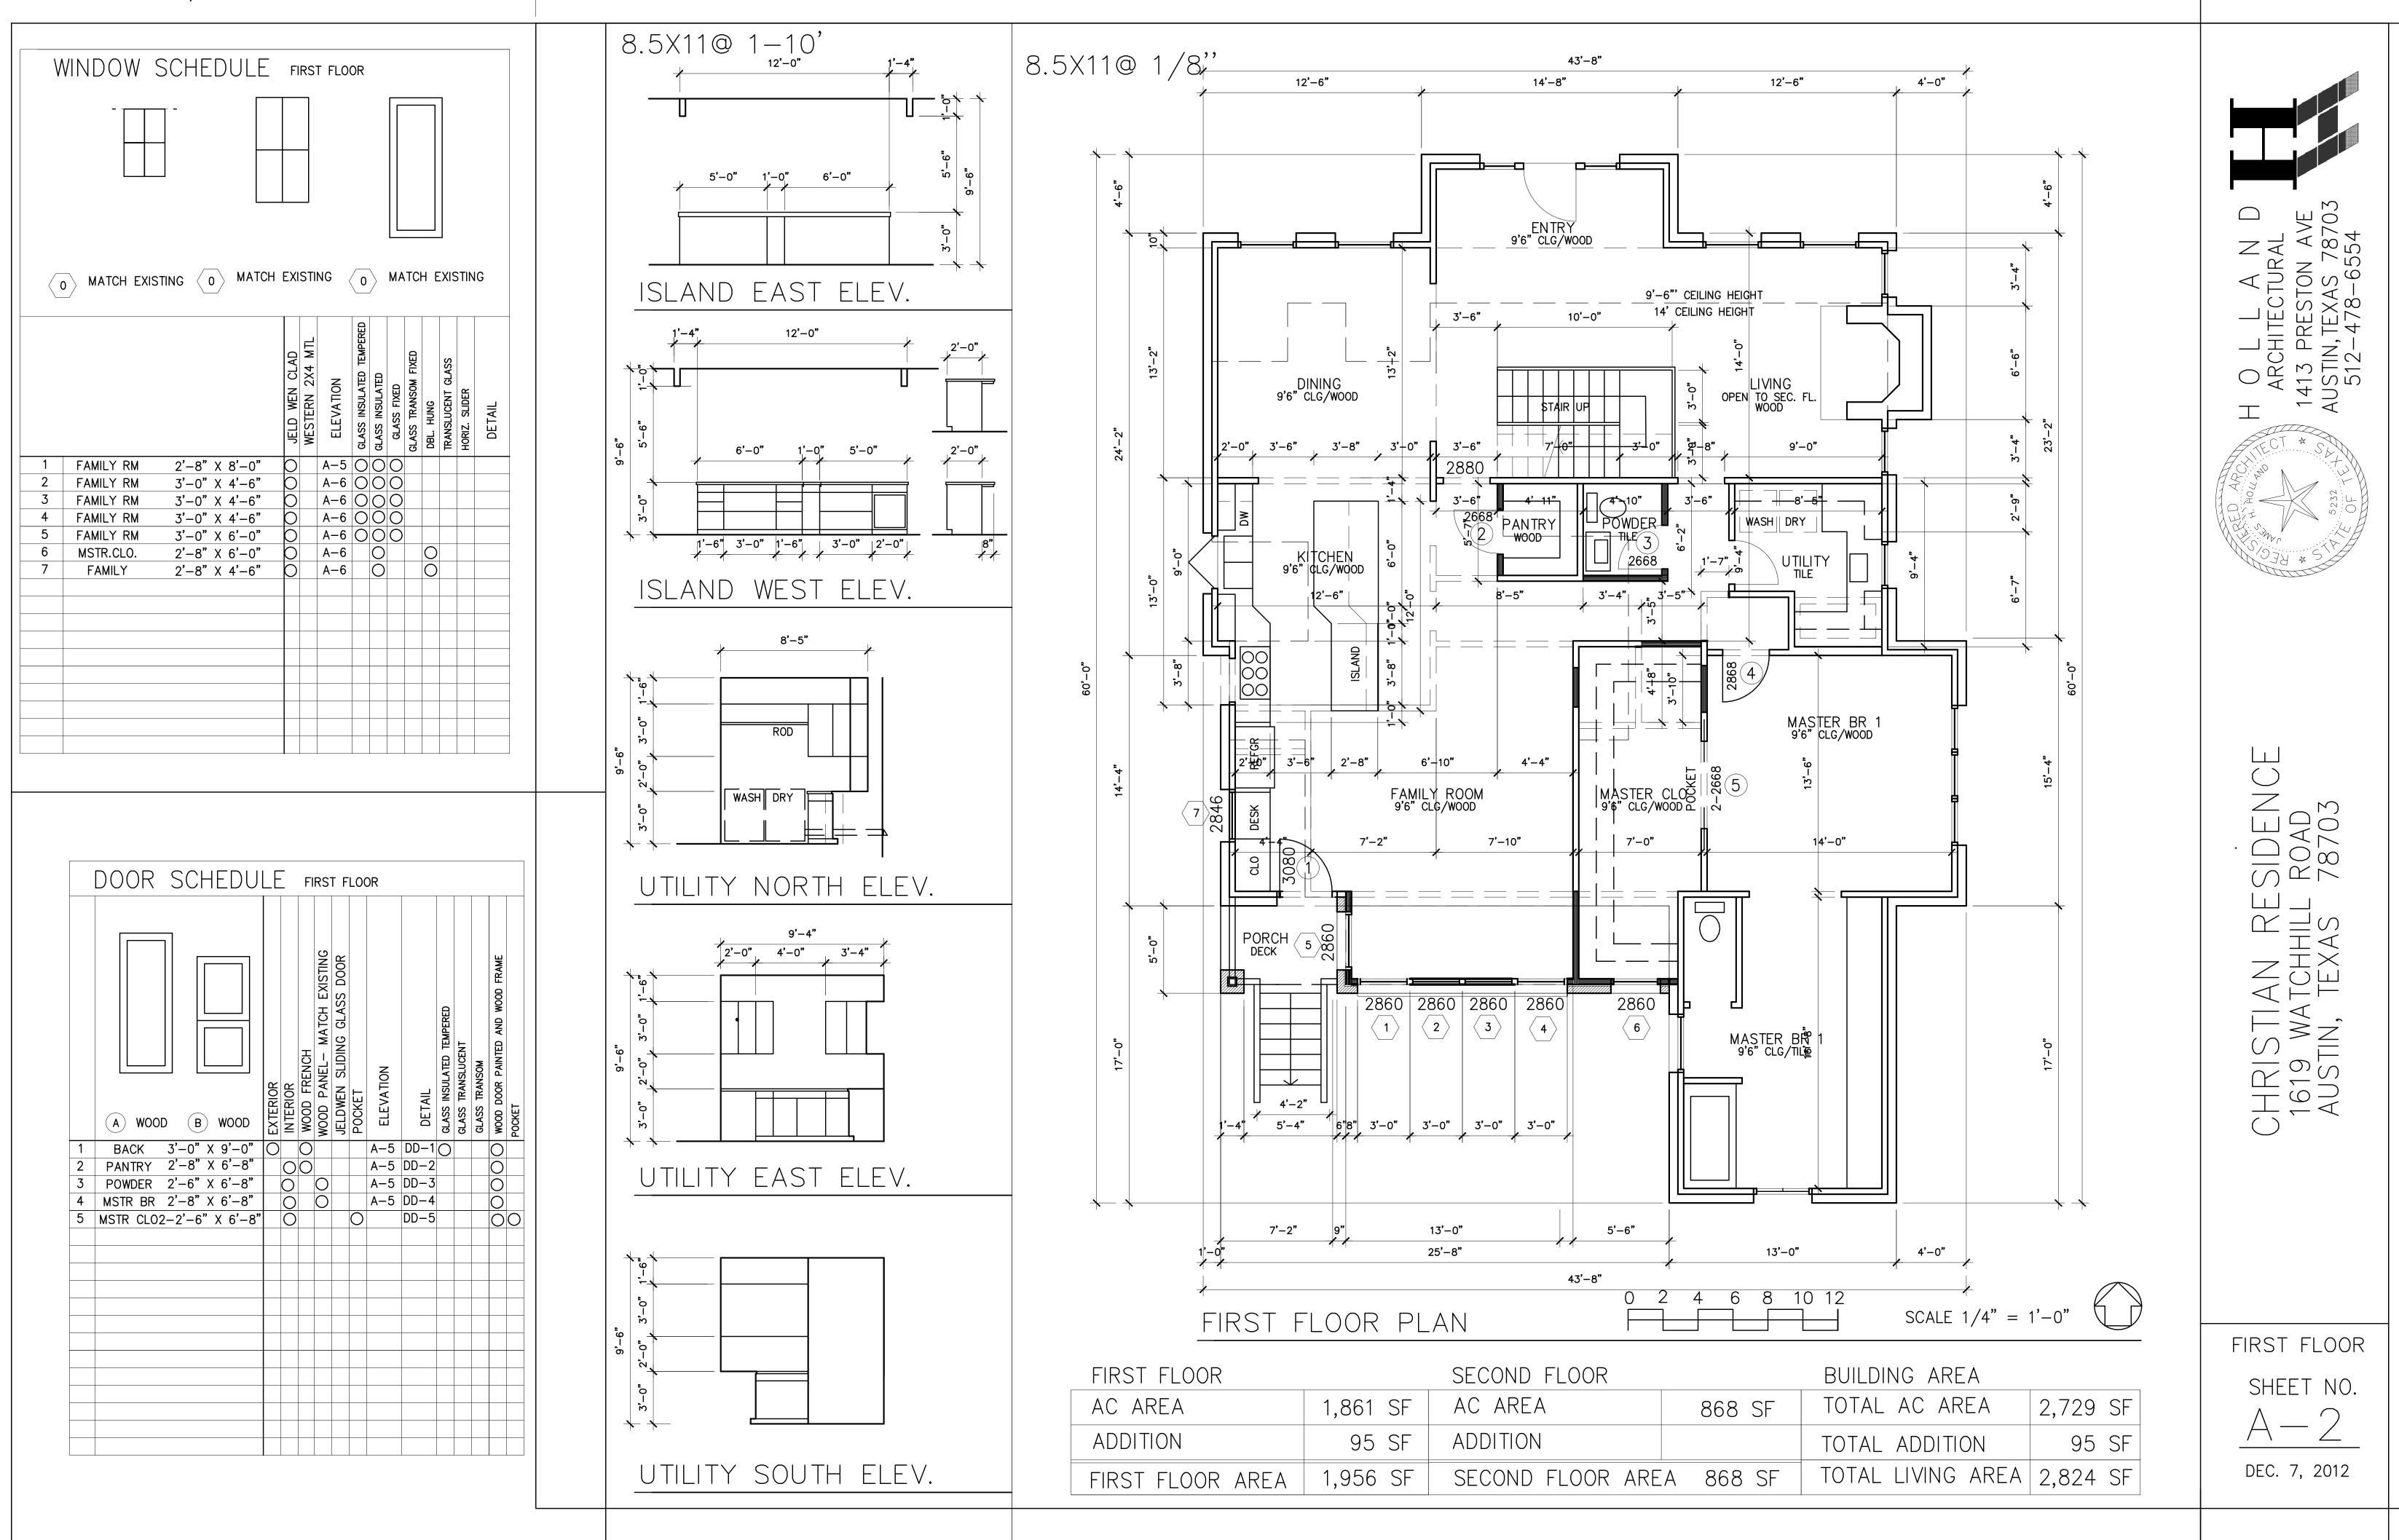

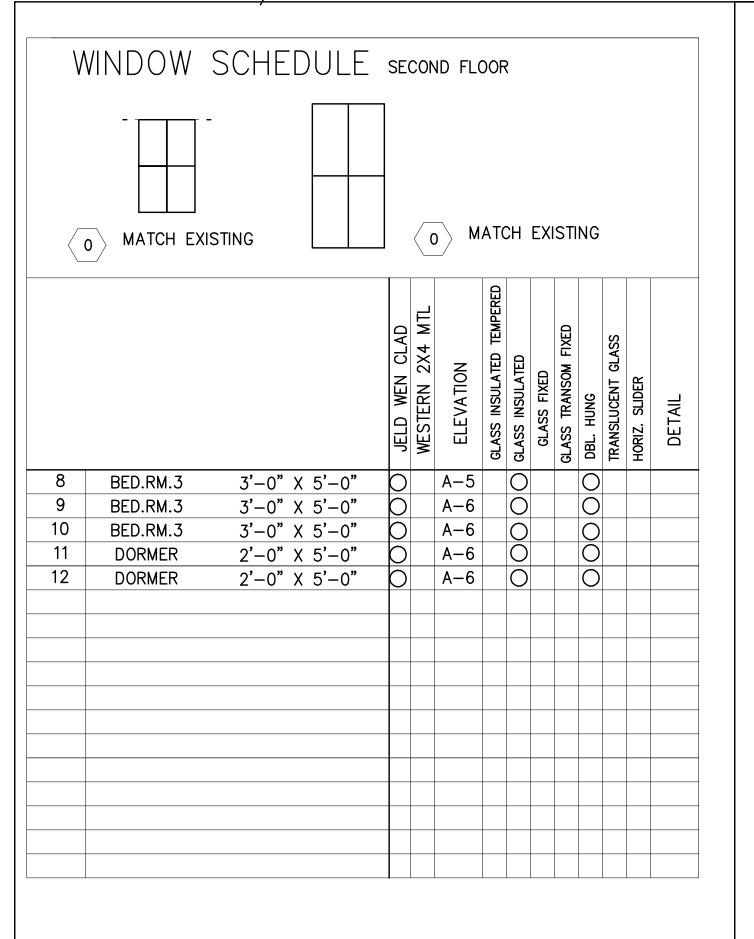

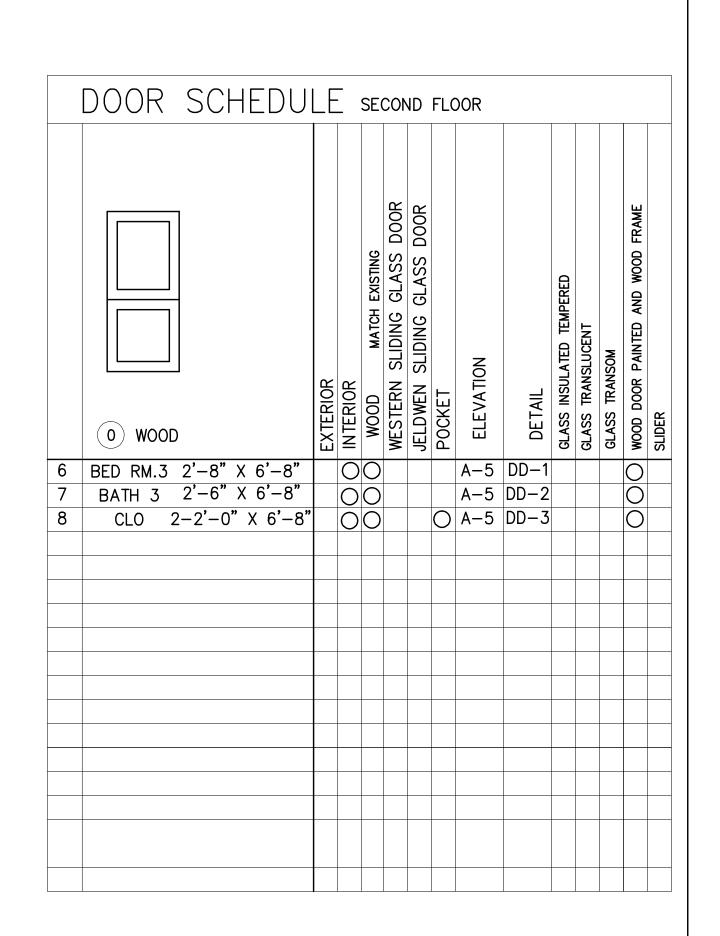

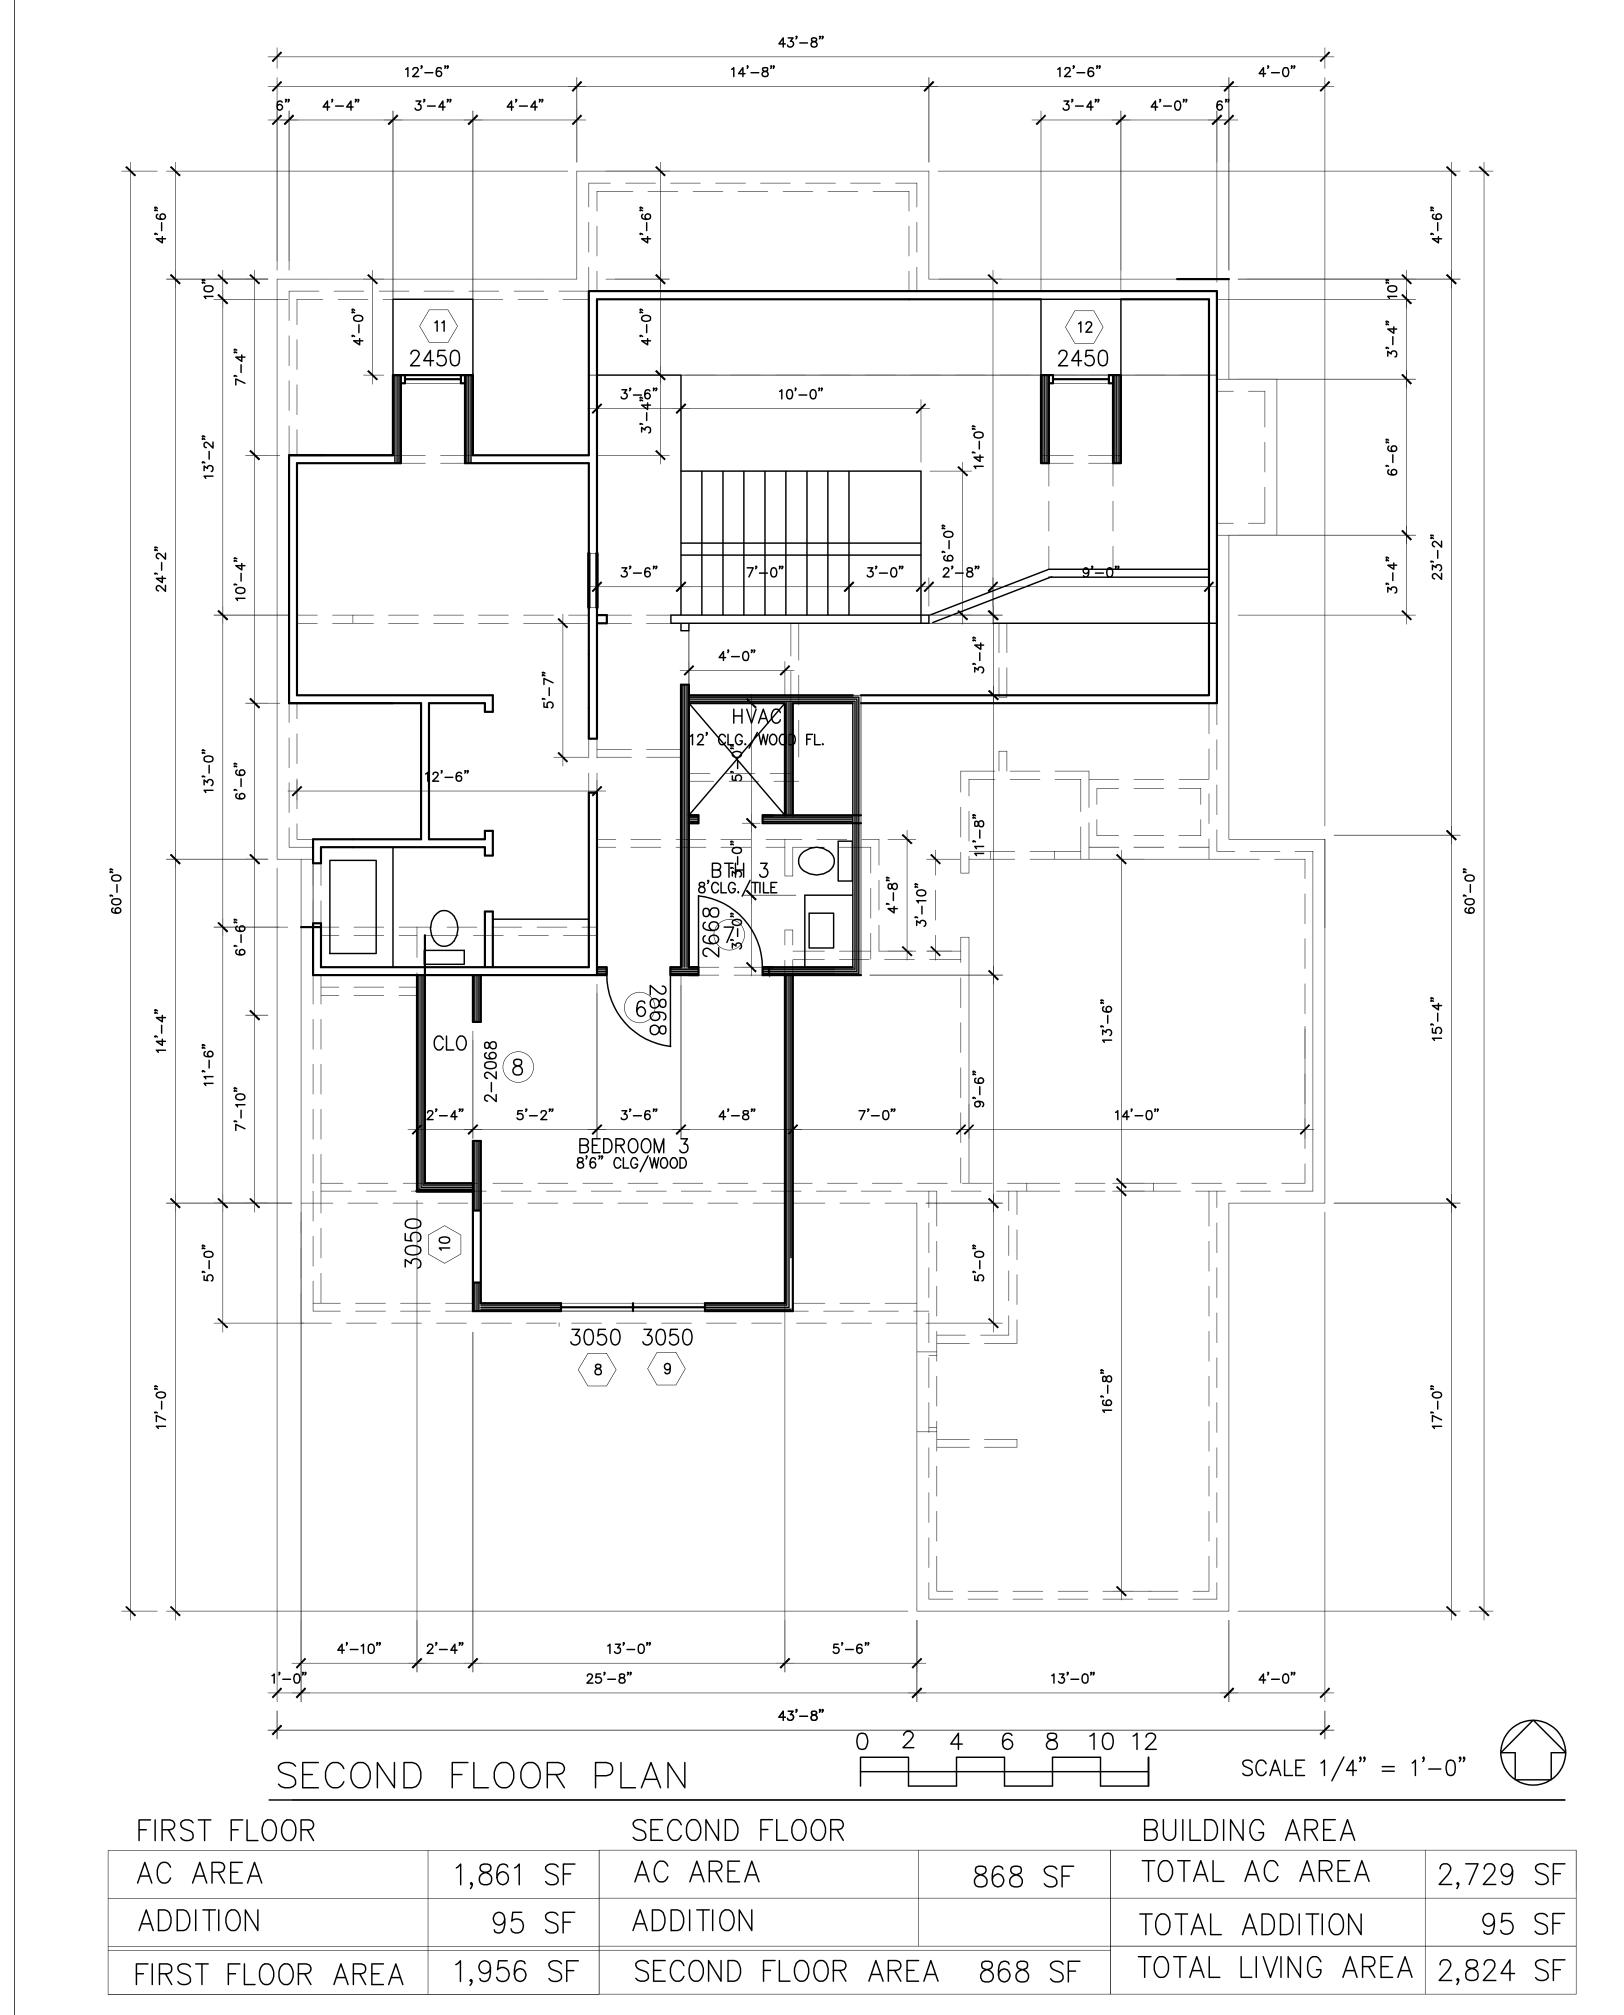

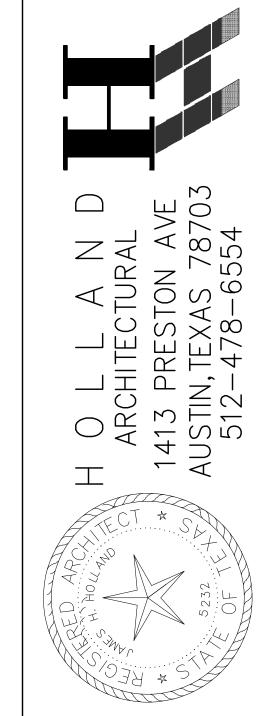

CHRISTIAN RESIDENCI 1619 Watchhill Road Austin, texas 78703

SECOND FLOOR

SHEET NO.

A — 3

DEC. 7, 2012



