CVM

STRUCTURAL ENGINEER

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GENERAL CONTRACTOR

RISINGER HOMES 5126 BURNET ROAD AUSTIN, TEXAS 78756

CONTACT: ERIC RAUSER ERIC@RISINGERHOMES.COM T: 512.751.5580





FOR REFERENCE ONLY

	12TH STREET
PROJECT SITE	a man
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The Sent Marie	December 1
1	- June 1
$\overset{\mathtt{N}}{\bigoplus}$	VICINITY MAP

BUILDING COVERAGE				
AREA	EXISTING	REMOVED	ADDED	TOTAL
MAIN FLOOR CONDITIONED	1,237	0	558	1,795 SQ FT
ACCESSORY BUILDINGS	498	-85	0	413 SQ FT
COVERED PARKING	665	-18	0	647 SQ FT
COVERED PATIO, DECK OR PORCH	504	0	170	674 SQ FT
TOTAL GROSS BUILDING AREA	2,904	-103	728	3,529 SQ FT
SITE AREA				15,076 SQ FT
PERCENTAGE OF SITE (MAX. 40%)				23.4 % OF LOT

IMPERVIOUS COVER				
AREA	EXISTING	REMOVED	ADDED	TOTAL
BUILDING COVERAGE	2,904	-103	728	3,529 SQ FT
DRIVEWAY	1,739	-363	0	1,376 SQ FT
WALKS	180	-29	55	206 SQ FT
UNCOVERED PORCHES	348	-348	345	345 SQ FT
WOOD DECK (50%)	56	-56	152	152 SQ FT
OTHER (RETAINING WALLS, POOL COPING)	1,065	-84	50	1,031 SQ FT
TOTAL IMPERVIOUS COVER	6,292	-983	1,330	6,639 SQ FT
SITE AREA				15,076 SQ FT
PERCENTAGE OF SITE (MAX. 45%)				44.0 % OF LOT

FLOOR AREA RATIO					
AREA	EXISTING	REMOVED	ADDED	EXEMPTION	TOTAL
BASEMENT CONDITIONED	1,237	0	545		1,782 SQ FT
MAIN FLOOR CONDITIONED	1,237	0	558		1,795 SQ FT
ATTIC	238	0	0		238
GARAGE (DETACHED)	665	0	0	-450	215 SQ FT
CARPORT (DETACHED)	0	0	0		0 SQ FT
ACCESSORY BUILDINGS	498	-85	0		413 SQ FT
GROUND FLOOR PORCH	504	0	0	-200	304 SQ FT
TOTAL FAR	4,379	-85	1,103	-650	4,747 SQ FT
SITE AREA					15,076 SQ FT
PERCENTAGE OF SITE (MAX. 45%)					31.5 % OF LOT

PROJECT DESCRIPTION

REMODEL OF AN EXISTING 2-STORY SINGLE-FAMILY RESIDENCE. 2-STORY ADDITION INCLUDING A MASTER SUITE AND DINING ROOM. REMODEL OF EXISTING, DETACHED GUEST HOUSE. NEW BREEZEWAY AND OUTDOOR LIVING SPACE CONNECTING MAIN HOUSE AND GUEST HOUSE.

LEGAL DESCRIPTION

LOT 19&20 BLOCK 6 OLT 5 DIV Z SILLIMAN, A SUBDIVISION IN TRAVIS COUNTY, TEXAS, ACCORDING TO THE MAP OR PLAT THEREOF RECORDED IN VOLUME X PAGE X OF THE PLAT RECORD OF TRAVIS COUNTY, TEXAS. (TCAD PARCEL #107006)

ZONING			
F - 3 - H - HD - NP			
NEIGHBORHOOD			

OLD WEST AUSTIN NEIGHBORHOOD ASSOCIATION GENERAL PROJECT NOTES

PERFORMALL WORK IN ACCORDANCE WITH THE CITY OF AUSTIN CODES, REGULATIONS & ORDINANCES

DO NOT SCALE DRAWING, CONTACT ARCHITECT UPON DISCOVERY OF MISSING INFORMATION OR CONFLICTS IN DRAWINGS

STRUCTURAL ENGINEERING FOR ALL PARTS OF THIS PROJECT TO BE DESIGNED BY OTHERS

MECH, ELEC, PLUMB & FIRE ENGINEERING TO BE PROVIDED BY OTHERS. MAY REQUIRE COORDINATION WITH ARCHITECT

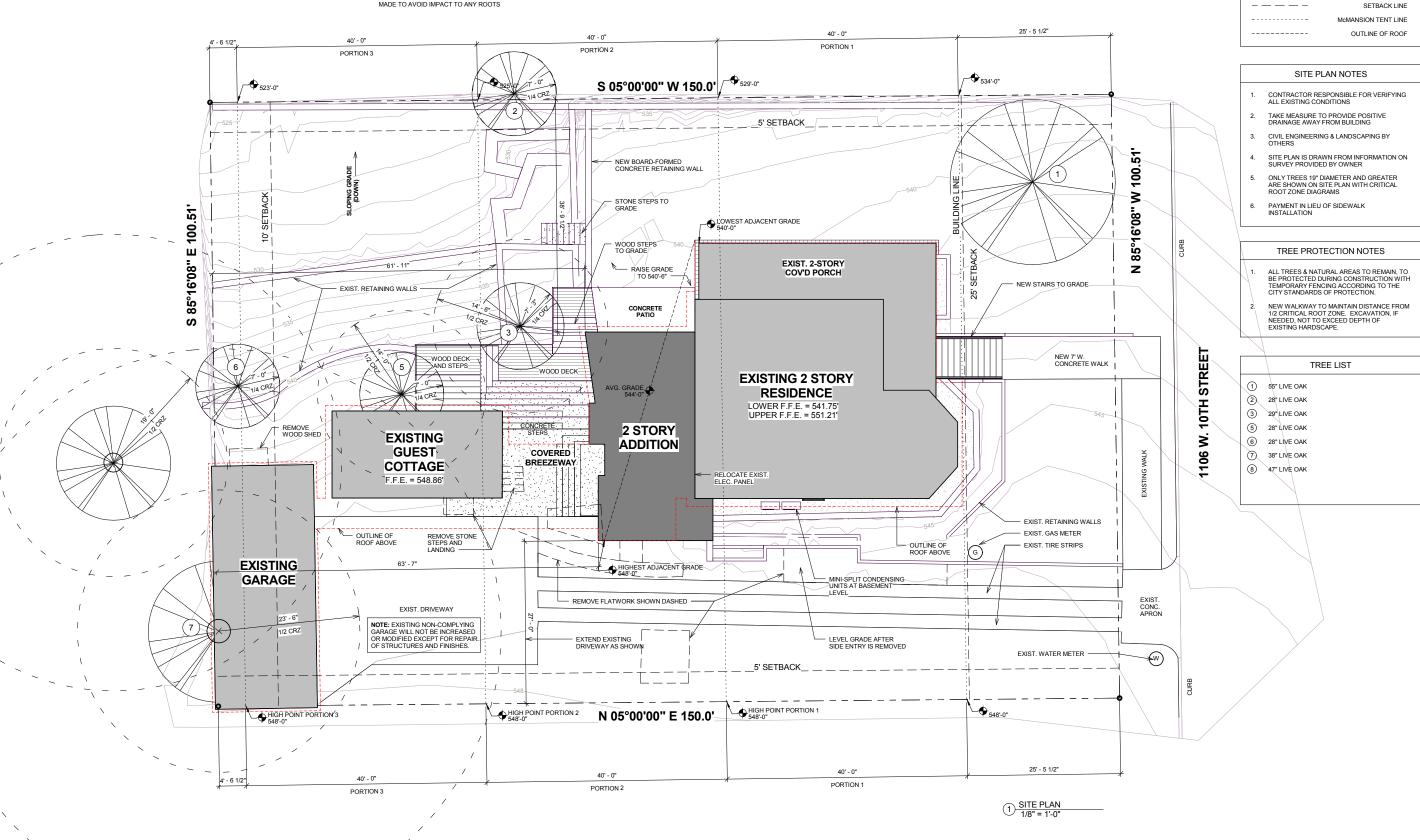
1106 W. 10TH STREET SHEET LIST		
SHEET NO.	SHEET NAME	
A0.0	TITLE SHEET & PROJECT INFORMATION	
A0.1	SITE PLAN	
A0.2	MAIN FLOOR DEMOLITION PLAN	
A0.3	BASEMENT DEMOLITION PLAN	
A1.1	MAIN FLOOR PLAN	
A1.2	MAIN FLOOR DIMENSION PLAN	
A1.3	BASEMENT FLOOR PLAN	
A1.4	BASEMENT DIMENSION PLAN	
A1.5	ROOF PLAN	
A2.1	EXTERIOR ELEVATIONS	
A2.2	EXTERIOR ELEVATIONS	
A2.3	EXTERIOR ELEVATIONS	
A8.1	PICTURE LOCATION DIAGRAM	
A9.1	3D EXTERIOR VIEWS	
A9.2	3D EXTERIOR VIEWS	

A0.0

4.22.15 HLC SUBMISSION

TITLE SHEET & **PROJECT INFORMATION** 1 of 15

NOTE FOR TREE #3, #5 & #7: THERE WILL BE NO EXCAVATION WITHIN 50% CRZ - PERIMETER BEAM WILL REST ON TOP OF GRADE AND NOT



NOT FOR PERMIT, CONSTRUCTION, OR REGULATORY APPROVAL

Drawn by CAI, CVM

SITE PLAN LEGEND EXISTING TO BE REMODELED

> NEW ADDITION PROPERTYLINE

Kahlon-Patel Residence

1106 W. 10th St. Austin, Texas 78703 austinarchitect.com 512.796.4001

A0.1

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SITE PLAN

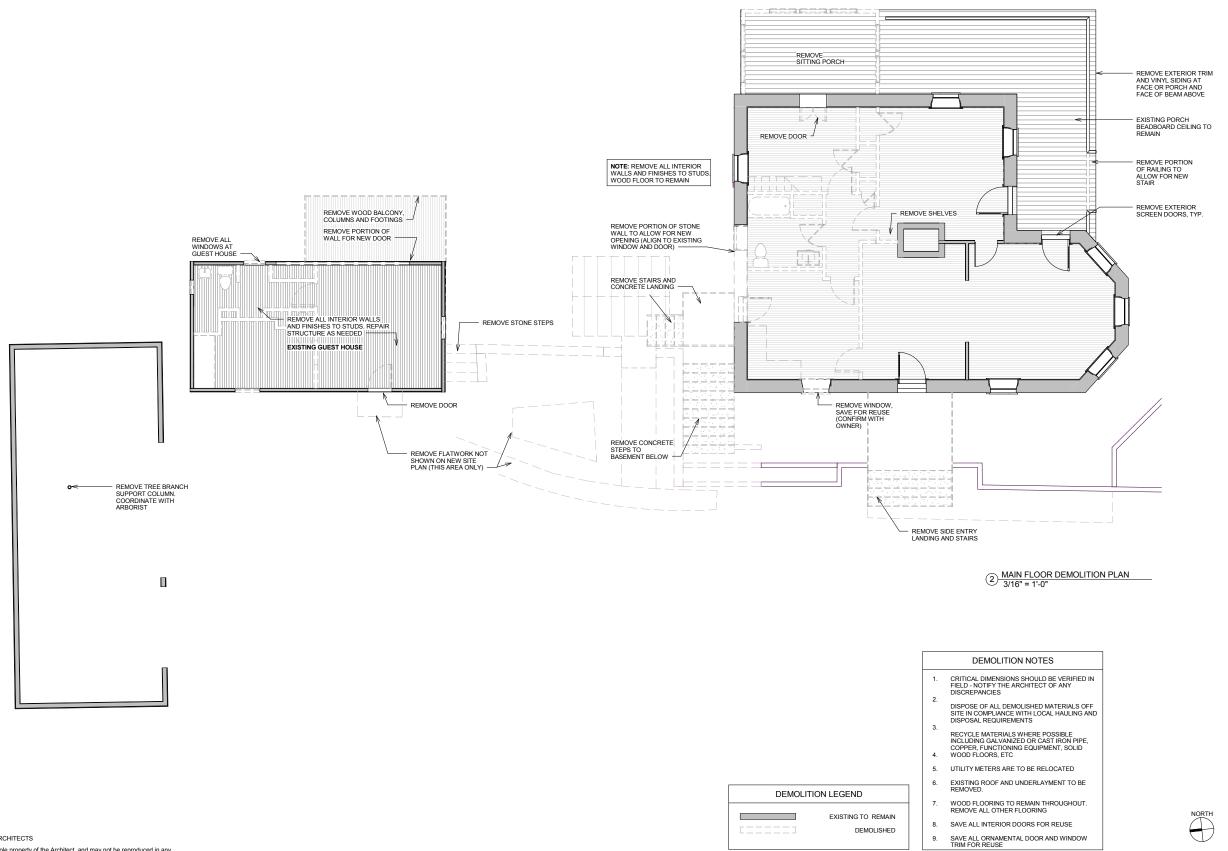
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Issue: HLC SUBMISSION
Revision: NO

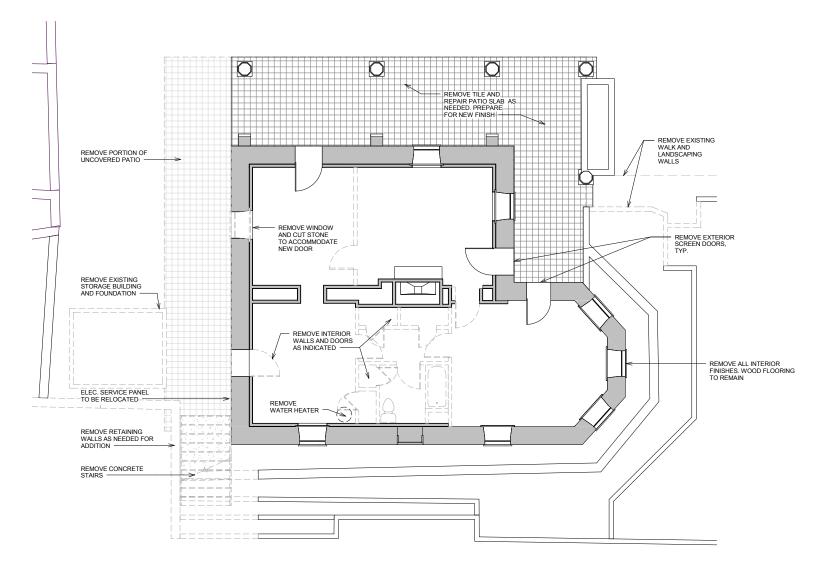
A0.2

MAIN FLOOR DEMOLITION PLAN



BASEMENT DEMOLITION PLAN

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1 BASEMENT DEMOLITION PLAN 3/16" = 1'-0"

DEMOLITION NOTES

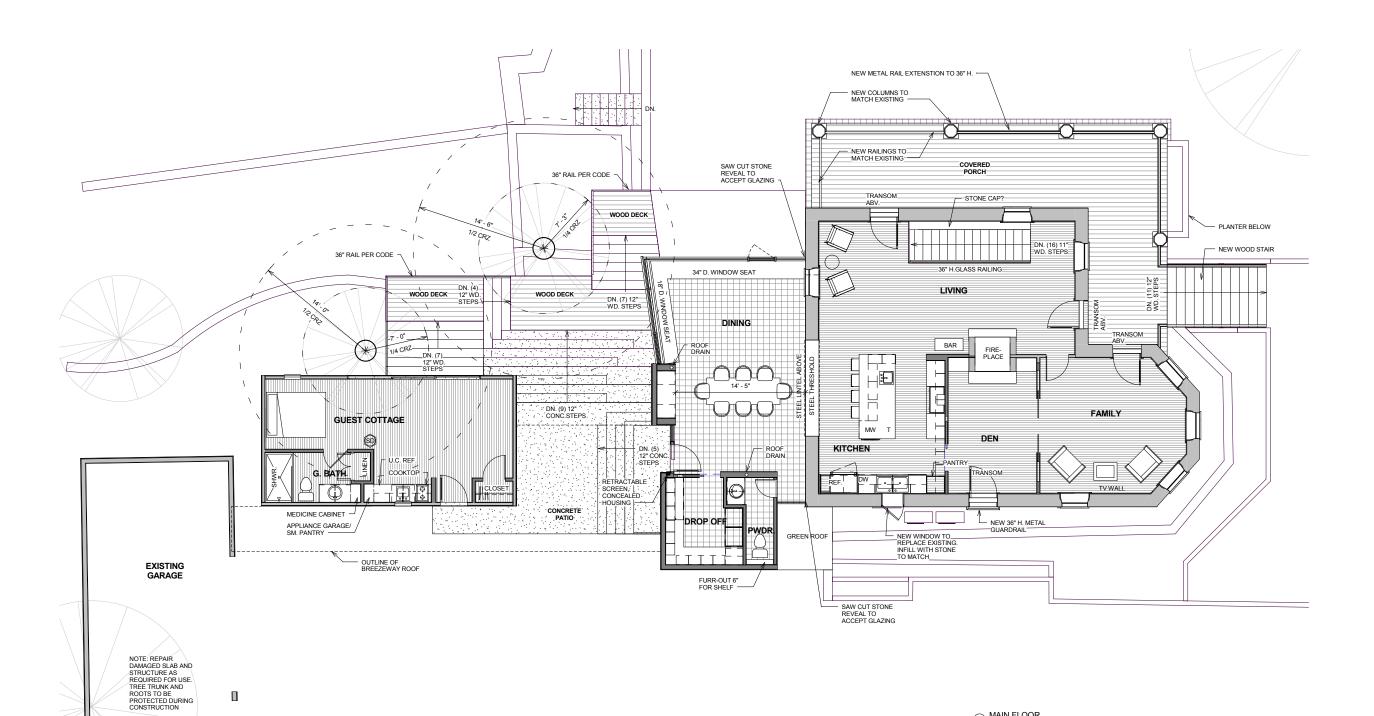
- CRITICAL DIMENSIONS SHOULD BE VERIFIED IN FIELD NOTIFY THE ARCHITECT OF ANY DISCREPANCIES
- DISPOSE OF ALL DEMOLISHED MATERIALS OFF SITE IN COMPLIANCE WITH LOCAL HAULING AND DISPOSAL REQUIREMENTS
- RECYCLE MATERIALS WHERE POSSIBLE INCLUDING GALVANIZED OR CAST IRON PIPE, COPPER, FUNCTIONING EQUIPMENT, SOLID
 WOOD FLOORS, ETC
- 5. UTILITY METERS ARE TO BE RELOCATED
- EXISTING ROOF AND UNDERLAYMENT TO BE REMOVED.
- WOOD FLOORING TO REMAIN THROUGHOUT. REMOVE ALL OTHER FLOORING
- 8. SAVE ALL INTERIOR DOORS FOR REUSE
- 9. SAVE ALL ORNAMENTAL DOOR AND WINDOW TRIM FOR REUSE

DEMOLITION LEGEND EXISTING TO REMAIN



A1.1 MAIN FLOOR PLAN

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1 MAIN FLOOR 3/16" = 1'-0"

FLOOR PLAN NOTES

- PERFORM ALL WORK IN ACCORDANCE WITH CITY OF AUSTIN CODES AND ORDINANCES
- DO NOT SCALE DRAWING, CONTACT ARCHITECT UPON DISCOVERY OF MISSING INFORMATION OR CONFLICTS IN DRAWING
- MINIMUM R-15 INSULATION IN WALLS
- USE 1/2" GYP. BOARD FOR ALL WALLS AND CEILINGS EXCEPT IN THE FOLLOWING LOCATIONS.USE 1/2" WATER RESISTANT GYP. BD. IN BATHROOM AND KITCHEN ON ALL WALLS EXCEPT BEHIND CERAMIC TILE AND BATHTUB WHERE TILE BACKER BOARD IS USED
 - CONTRACTOR TO INSTALL BLOCKING IN WALLS AND CEILINGS AS REQUIRED FOR ALL ACCESSORIES, WALL MOUNTED ITEMS, CEILING FAN, ETC. INCLUDING 2X6 BLOCKING INSIDE ALL BATHROOM WALLS AT 36" ABOVE FINISHED FLOOR

EXISTING WALL TO REMAIN NEW WALL NEW GLASS WALL ----- OVERHEAD FEATURE / ROOF

(SD)

FLOOR PLAN LEGEND

SMOKE DETECTOR

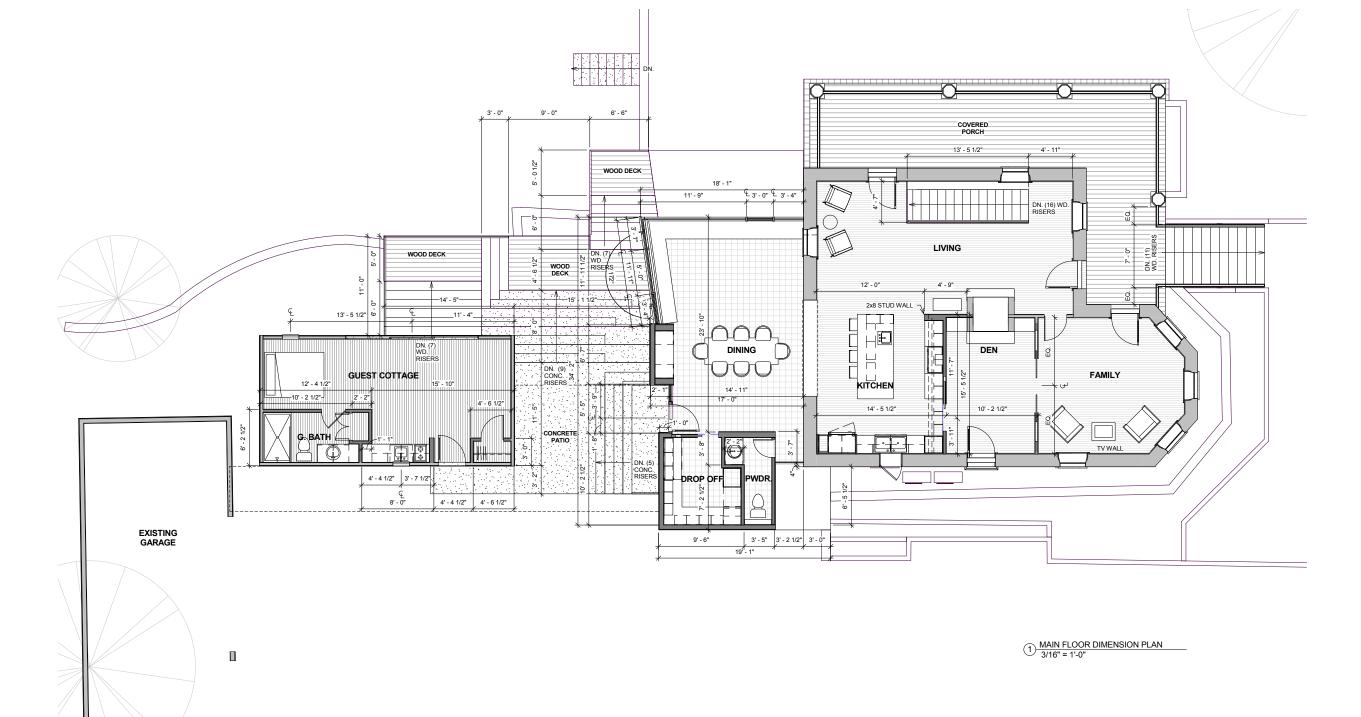
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A1.2

MAIN FLOOR DIMENSION PLAN

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- ALL NEW EXTERIOR WALLS TO BE FRAMED WITH 6" STUDS U.N.O. ALL INTERIOR WALLS TO BE FRAME WITH 4" STUDS U.N.O.
- FIELD VERIFY ALL DIMENSIONS PRIOR TO CONSTRUCTION



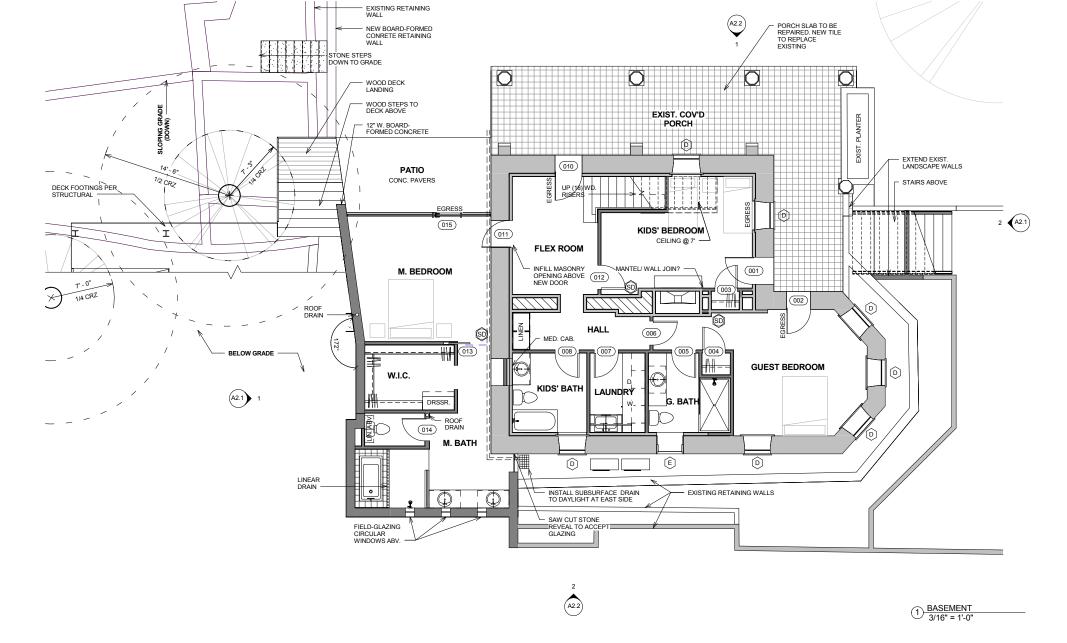
DIMENSION NOTES

- ALL DIMENSIONS ARE TAKEN FROM FACE OF STUD FOR NEW WALLS AND FROM FINISHED FACE OF EXISTING WALLS UNLESS NOTED OTHERWISE
- DISTANCE BETWEEN HINGE SIDE OF DOOR AND ADJACENT WALL IS 6" UNLESS NOTED OTHERWISE

A1.3

BASEMENT FLOOR PLAN

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- PERFORM ALL WORK IN ACCORDANCE WITH CITY OF AUSTIN CODES AND ORDINANCES
 - DO NOT SCALE DRAWING, CONTACT ARCHITECT UPON DISCOVERY OF MISSING INFORMATION OR CONFLICTS IN DRAWING
- 3. CONTACT ARCHITECT/ OWNER WITH ANY FRAMING QUESTIONS/ DISCREPANCIES
- 4. MINIMUM R-15 INSULATION IN WALLS
- 5. USE 1/2" GYP. BOARD FOR ALL WALLS AND CEILINGS EXCEPT IN THE FOLLOWING LOCATIONS:USE 1/2" WATER RESISTANT GYP. BD. IN BATHROOM AND KITCHEN ON ALL WALLS EXCEPT BEHIND CERAMIC TILE AND BATHTUB WHERE TILE BACKER BOARD IS USED

FLOOR PLAN LEGEND

OVERHEAD FEATURE / ROOF

(SD)

NEW GLASS WALL

SMOKE DETECTOR

CONTRACTOR TO INSTALL BLOCKING IN WALLS AND CEILINGS AS REQUIRED FOR ALL ACCESSORIES, WALL MOINTED ITEMS, CEILING FAN, ETC. INCLUDING 2X6 BLOCKING INSIDE ALL BATHROOM WALLS AT 36" ABOVE FINISHED LOOR

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DIMENSION NOTES

- ALL DIMENSIONS ARE TAKEN FROM FACE OF STUD FOR NEW WALLS AND FROM FINISHED FACE OF EXISTING WALLS UNLESS NOTED OTHERWISE
- ALL NEW EXTERIOR WALLS TO BE FRAMED WITH 6" STUDS U.N.O. ALL INTERIOR WALLS TO BE FRAME WITH 4" STUDS U.N.O.
- FIELD VERIFY ALL DIMENSIONS PRIOR TO CONSTRUCTION
- 4. DISTANCE BETWEEN HINGE SIDE OF DOOR AND ADJACENT WALL IS 6" UNLESS NOTED OTHERWISE

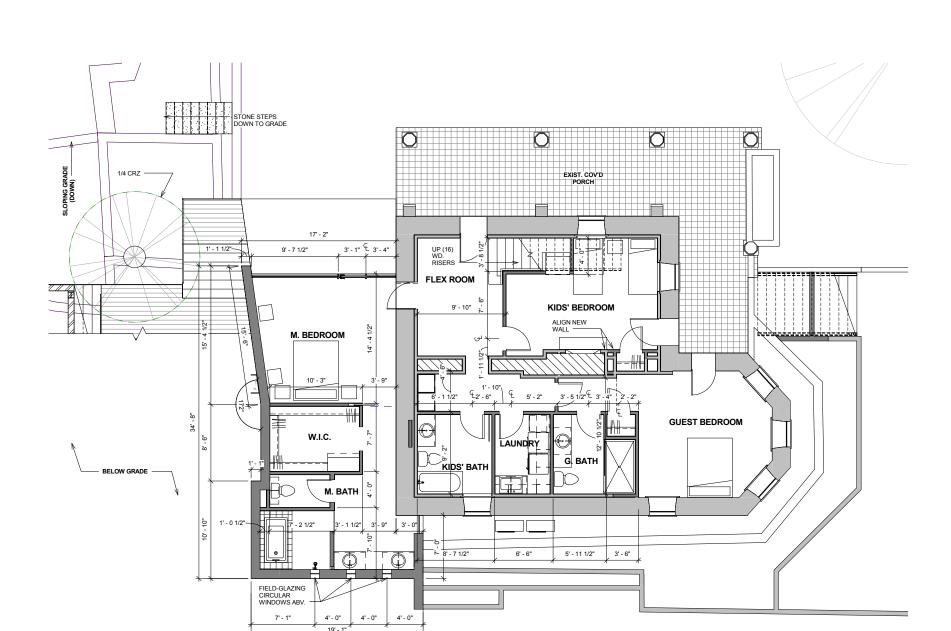


A1.4 BASEMENT DIMENSION PLAN

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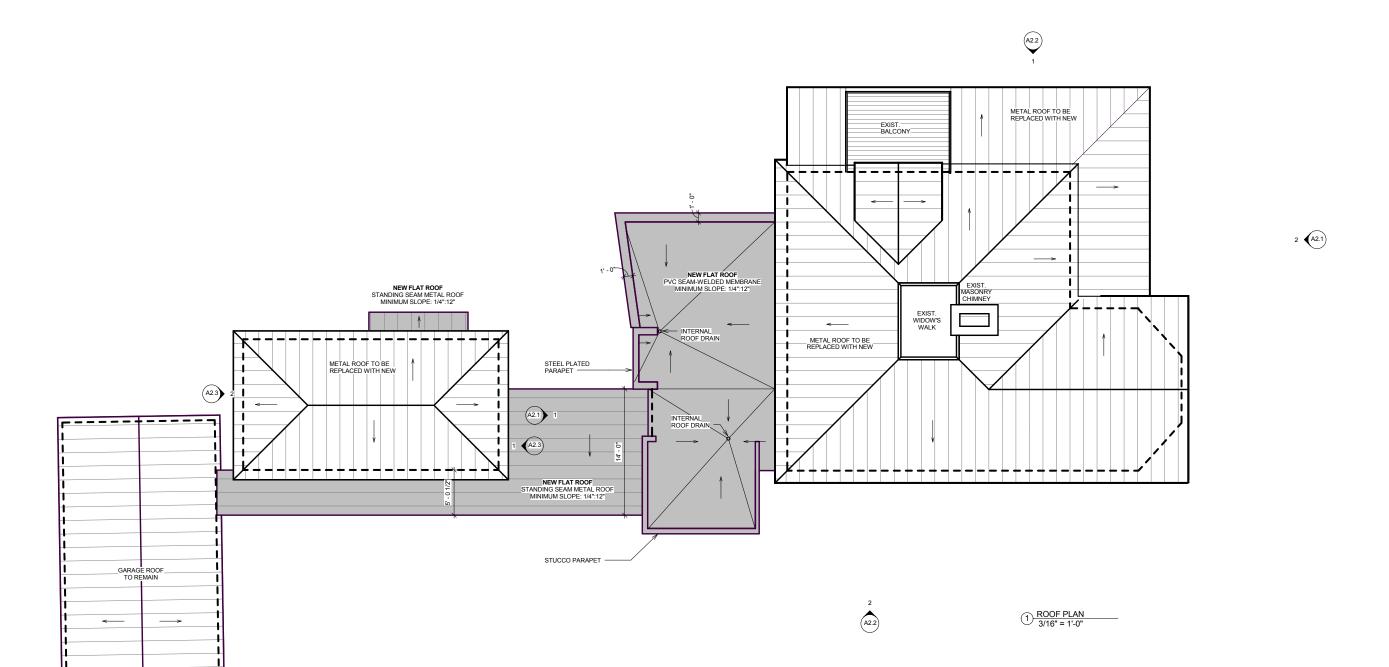


1 BASEMENT DIMENSION PLAN
3/16" = 1'-0"

A1.5

ROOF PLAN

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ROOF PLAN NOTES

- 1. VENT ALL MECH/ PLUMBING FIXTURES
- ALL VENTS THROUGH THE ROOF (VTR) TO BE PAINTED TO MATCH ROOF COLOR
- PROVIDE R-38 INSULATION BETWEEN NEW ROOF AND CEILING

ROOF LEGEND

─ ─ ─ OUTLINE OF WALLS BELOW

NEW ROOF

EXISTING ROOF TO BE REPLACED

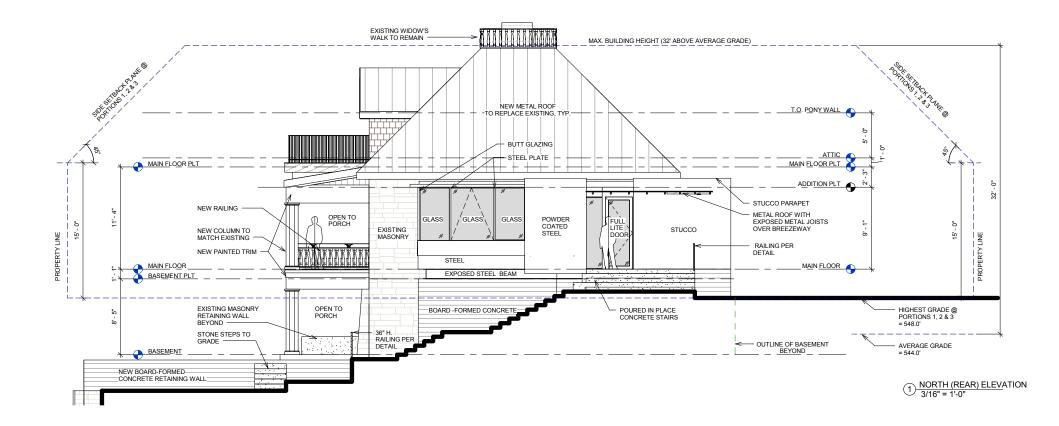
LOW-SLOPE ROOF DRAINS WITH DRAINAGE ARROWS

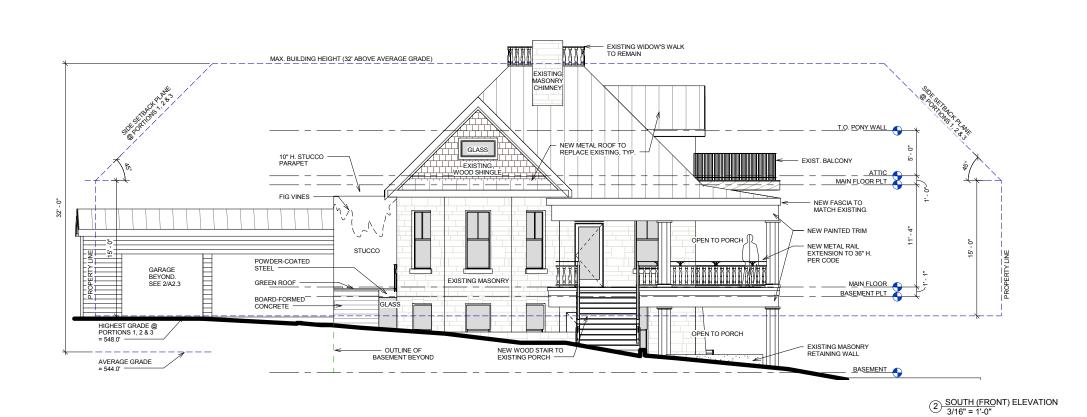
- EXISTING ROOFS TO RECEIVE NEW UNDERLAYMENT, INSULATION AND METAL ROOF
- FLASHING, UNDERLAYMENT AND FASTENING DETAILS PER ROOF MANFUNFACTURER. INSTALLER TO VERIFY WITH ARCHITECT
- NEW ROOF SHALL BE AN UNVENTED FLAT ROOF SYSTEM
- 7. CONFIRM DOWNSPOUT LOCATIONS WITH ARCHITECT PRIOR TO INSTALLATION

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EXTERIOR ELEVATIONS

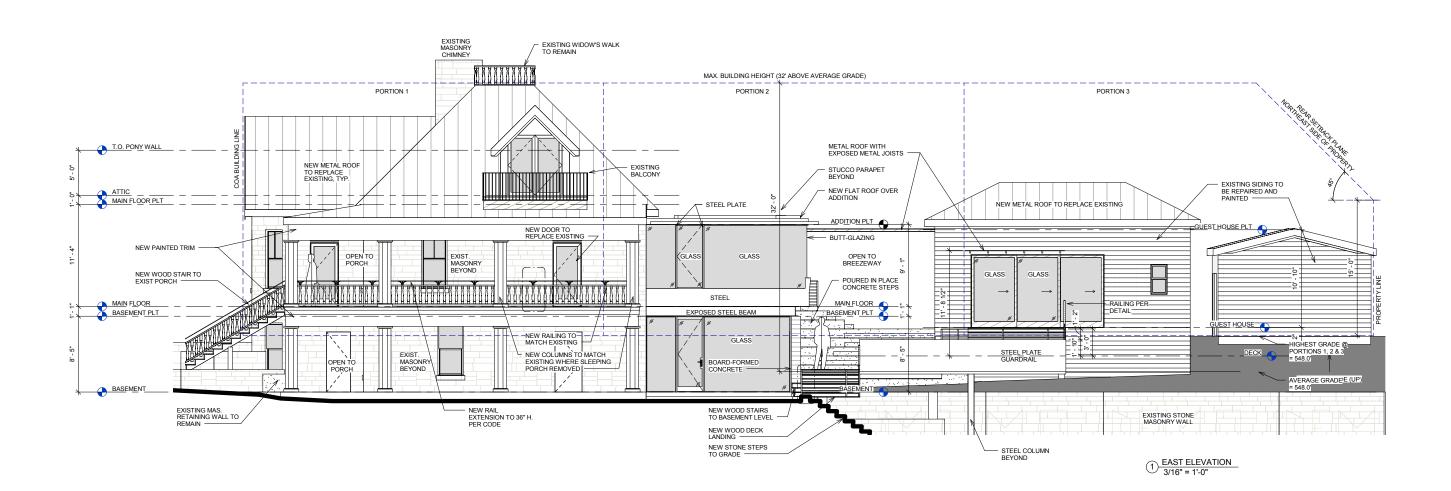


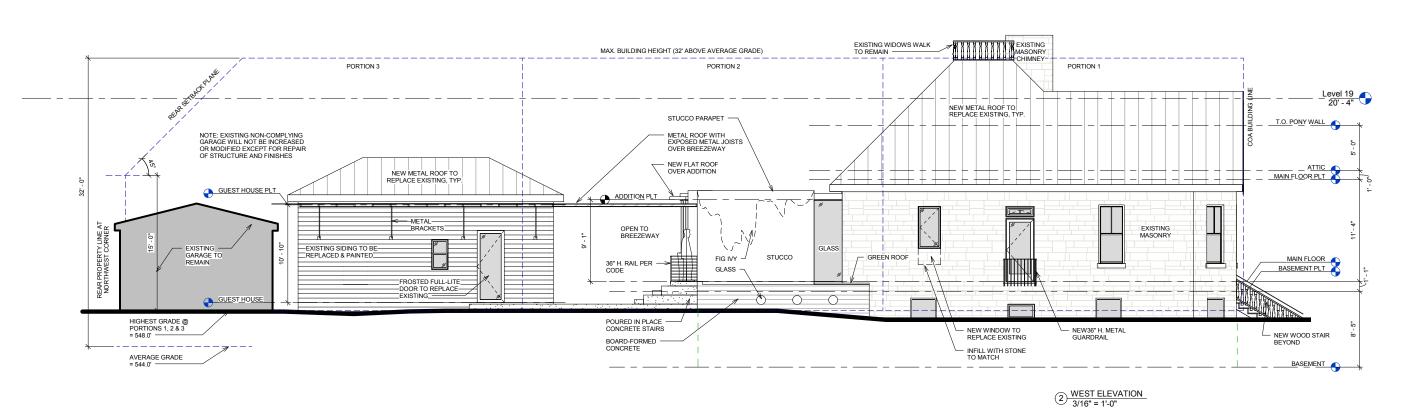


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A2.2 EXTERIOR ELEVATIONS





4.22.15 HLC SUBMISSION Date: Issue:

A2.3

EXTERIOR ELEVATIONS

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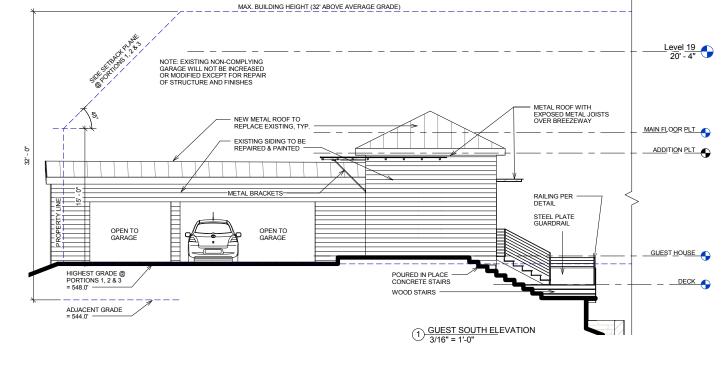


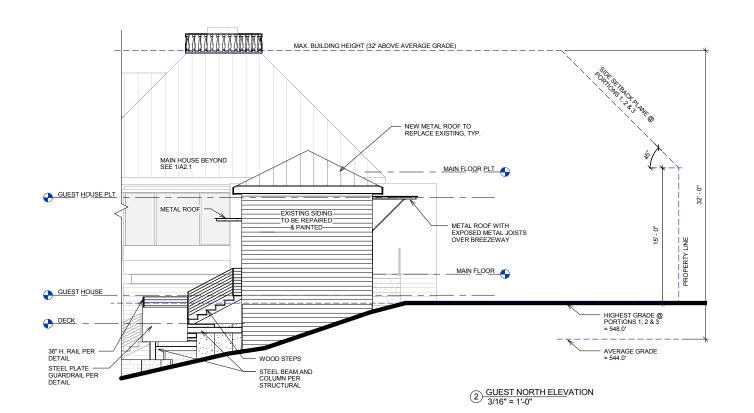
2x1/2" STEEL PLATE HANDRAIL @ 36" H. DECOR. STEEL COMPONENTS, EA. SIDE - 1 1/2" SQ. STEEL POST SURFACE-MOUNTED @ 48" O.C., ALIGN WITH BALUSTER BELOW EXISTING WOOD BALUSTRADE @ 28" H.

1x3" WOOD HANDRAIL @ 36" H. 3/16" STAINLESS STEEL CABLE SPACED MAX. 4" O.C., TYP.

- 1 1/2" SQ. POST, STAINLESS STEEL, BLACK, SURFACE MOUNTED PER MANUFACTURER

4 HISTORIC RAILING EXTENSION
3/8" = 1'-0"





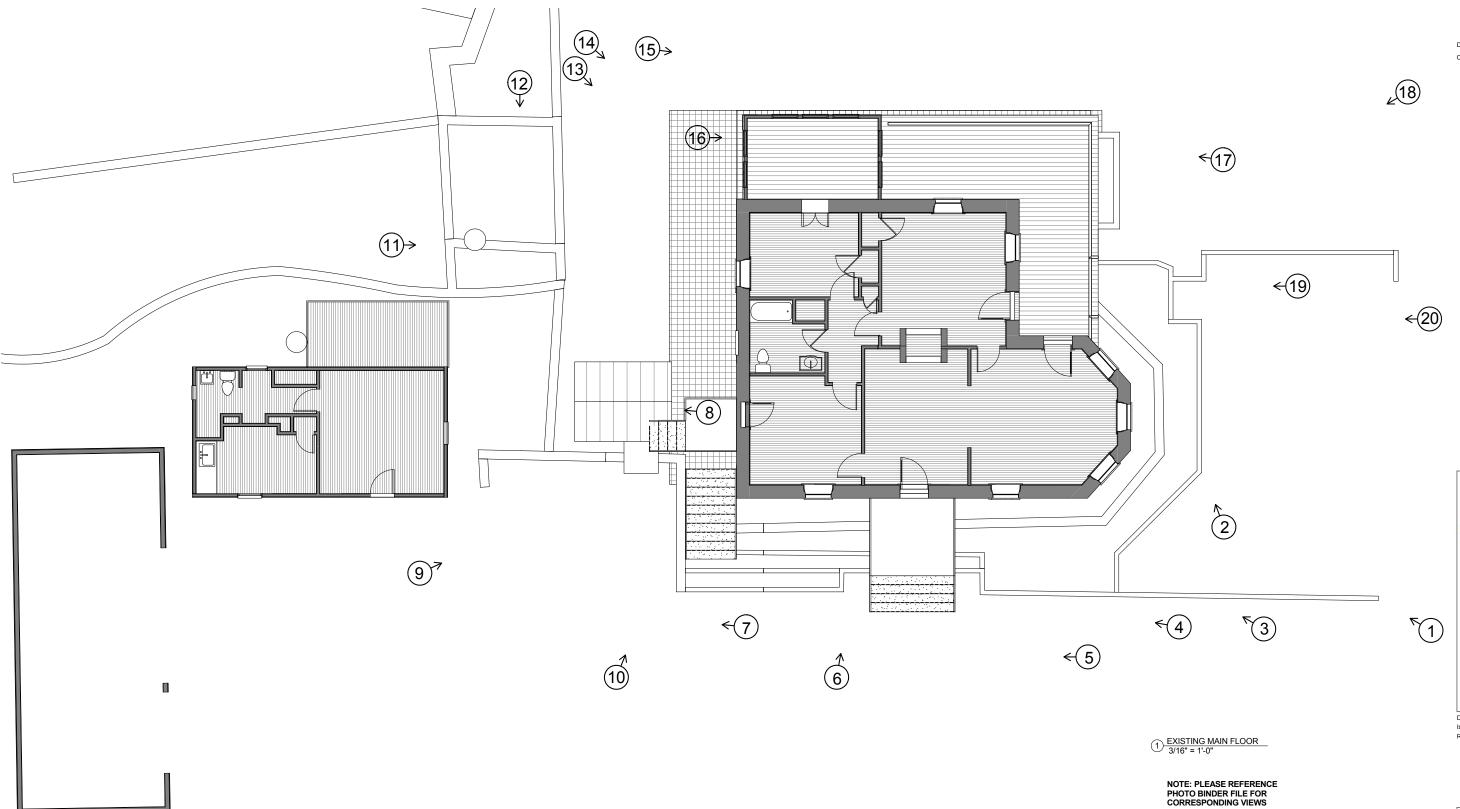
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A8.1

PICTURE LOCATION DIAGRAM 13 of 15



COVERED PORCH EXTENDED WHERE SLEEPING PORCH REMOVED, COLUMNS AND BALUSTRADE TO MATCH EXISTING

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A9.1 3D EXTERIOR **VIEWS**

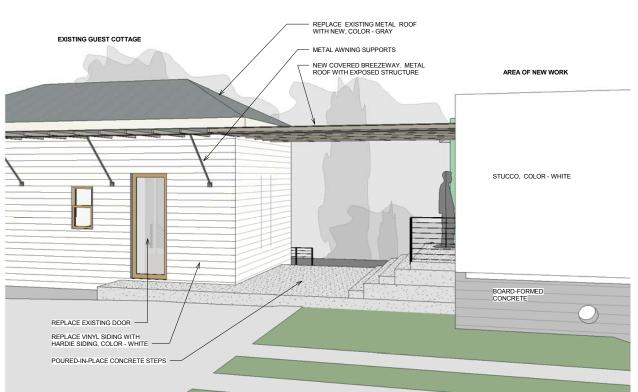
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REPLACE EXISTING METAL ROOF WITH NEW, COLOR - GRAY NEW WOOD STAIR

- EXISTING TRIM REPLACED, PAINTED WHITE TO MATCH

NEW WOOD STAIR

- RAIL EXTENSION



EXISTING MAIN HOUSE

REPLACE EXISTING METAL ROOF WITH NEW, COLOR - GRAY

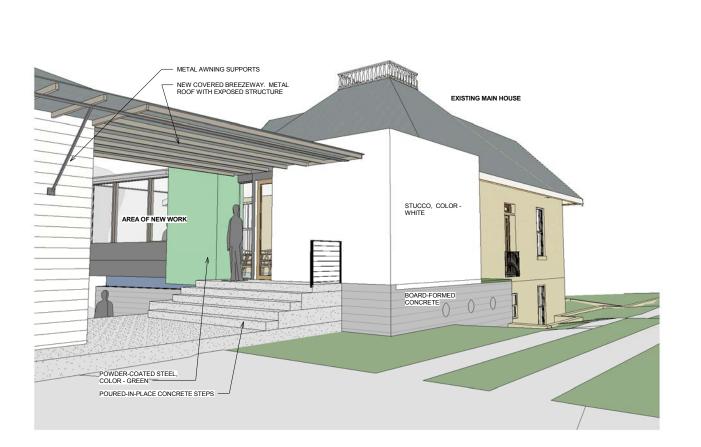
STUCCO, COLOR -

GREEN ROOF

AREA OF NEW WORK

BOARD-FORMED CONCRETE

NEW RAILING



EXISTING MAIN HOUSE

A9.2
3D EXTERIOR VIEWS



