# CVM

### Drawn by CAI, CVM

HUGH JEFFERSON RANDOLPH ARCHITECTS 1009 W 6TH STREET; SUITE 201 AUSTIN, TEXAS 78703

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### **GENERAL CONTRACTOR**

RISINGER HOMES 5126 BURNET ROAD AUSTIN, TEXAS 78756

CONTACT: ERIC RAUSER ERIC@RISINGERHOMES.COM T: 512.751.5580

### STRUCTURAL ENGINEER

STRUCTURES 1018 W. 11TH ST., SUITE 100 AUSTIN, TEXAS 78703

CONTACT: JERRY GARCIA JERRY@STRUCTURESTX.COM T: 512.499.0919





FOR REFERENCE ONLY

PROJECT SITE VICINITY MAP

В	UILDING COV	/ERAGE		
AREA	EXISTING	REMOVED	ADDED	TOTAL
MAIN FLOOR CONDITIONED	1,237	0	434	1,671 SQ FT
ACCESSORY BUILDINGS	498	-85	0	413 SQ FT
COVERED PARKING	665	-18	0	647 SQ FT
COVERED PATIO, DECK OR PORCH	504	0	0	504 SQ FT
TOTAL GROSS BUILDING AREA	2,904	-103	434	3,235 SQ FT
SITE AREA				15,076 SQ FT
PERCENTAGE OF SITE (MAX. 40%)				21.5 % OF LOT

IMPERVIOUS COVER				
AREA	EXISTING	REMOVED	ADDED	TOTAL
BUILDING COVERAGE	2,904	-103	434	3,235 SQ FT
DRIVEWAY	1,739	-380	0	1,359 SQ FT
WALKS	180	-29	57	208 SQ FT
UNCOVERED PORCHES	348	-348	418	418 SQ FT
WOOD DECK (50%)	56	-56	0	0 SQ FT
OTHER (RETAINING WALLS, POOL COPING)	1,065	-84	90	1,071 SQ FT
TOTAL IMPERVIOUS COVER	6,292	-1,000	999	6,291 SQ FT
SITE AREA				15,076 SQ FT
PERCENTAGE OF SITE (MAX. 45%)				41.7 % OF LO

FLOOR AREA RATIO					
AREA	EXISTING	REMOVED	ADDED	EXEMPTION	TOTAL
BASEMENT CONDITIONED	1,237	0	438		1,675 SQ FT
MAIN FLOOR CONDITIONED	1,237	0	434		1,671 SQ FT
ATTIC	238	0	472		710 SQ FT
GARAGE (DETACHED)	665	0	0	-450	215 SQ FT
CARPORT (DETACHED)	0	0	0		0 SQ FT
ACCESSORY BUILDINGS	498	-85	0		413 SQ FT
GROUND FLOOR PORCH	504	0	0	-200	304 SQ FT
TOTAL FAR	4,379	-85	1,344	-650	4,988 SQ FT
SITE AREA					15,076 SQ FT
PERCENTAGE OF SITE (MAX. 45%)					33.1 % OF LOT


PROJECT DESCRIPTION
REMODEL OF AN EXISTING 2-STORY SINGLE-FAMILY RESIDENCE. 2-STORY ADDITION INCLUDING A MASTER SUITE AND DINING ROOM. REMODEL OF EXISTING, DETACHED GUEST HOUSE. NEW PATIO CONNECTING MAIN HOUSE AND GUEST HOUSE.
LEGAL DESCRIPTION
LOT 19820 BLOCK 6 OLT 5 DIV Z SILLIMAN, A SUBDIVISION IN TRAVIS COUNTY, TEXAS, ACCORDING TO THE MAP OR PLAT THEREOF RECORDED IN VOLUME X PAGE X OF THE PLAT RECORD OF TRAVIS COUNTY, TEXAS. (TCAD PARCEL #107006)
ZONING
SF - 3 - H - HD - NP
NEIGHBORHOOD
OLD WEST AUSTIN NEIGHBORHOOD ASSOCIATION
GENERAL PROJECT NOTES
PERFORM ALL WORK IN ACCORDANCE WITH THE CITY OF AUSTIN CODES, REGULATIONS & ORDINANCES
DO NOT SCALE DRAWING, CONTACT ARCHITECT UPON DISCOVERY OF MISSING INFORMATION OR CONFLICTS IN DRAWINGS
STRUCTURAL ENGINEERING FOR ALL PARTS OF THIS PROJECT TO BE DESIGNED BY OTHERS
MECH, ELEC, PLUMB & FIRE ENGINEERING TO BE PROVIDED BY OTHERS. MAY REQUIRE COORDINATION WITH ARCHITECT

	SHEET LIST
SHEET NO.	SHEET NAME
A0.1	SITE PLAN
A0.2	MAIN FLOOR DEMOLITION PLAN
A0.3	BASEMENT & ATTIC DEMOLITION PLAN
A1.1	MAIN FLOOR PLAN
A1.2	MAIN FLOOR DIMENSION PLAN
A1.3	BASEMENT & ATTIC FLOOR PLANS
A1.4	BASEMENT & ATTIC DIMENSION PLAN
A1.5	ROOF PLAN
A2.1	EXTERIOR ELEVATIONS
A2.2	EXTERIOR ELEVATIONS
A2.3	EXTERIOR ELEVATIONS
A8.1	PICTURE LOCATION DIAGRAM
A9.1	3D EXTERIOR VIEWS
A9.2	3D EXTERIOR VIEWS

A0.0

TITLE SHEET & **PROJECT INFORMATION** 1 of 15

6.17.15 HLC SUBMITTAL

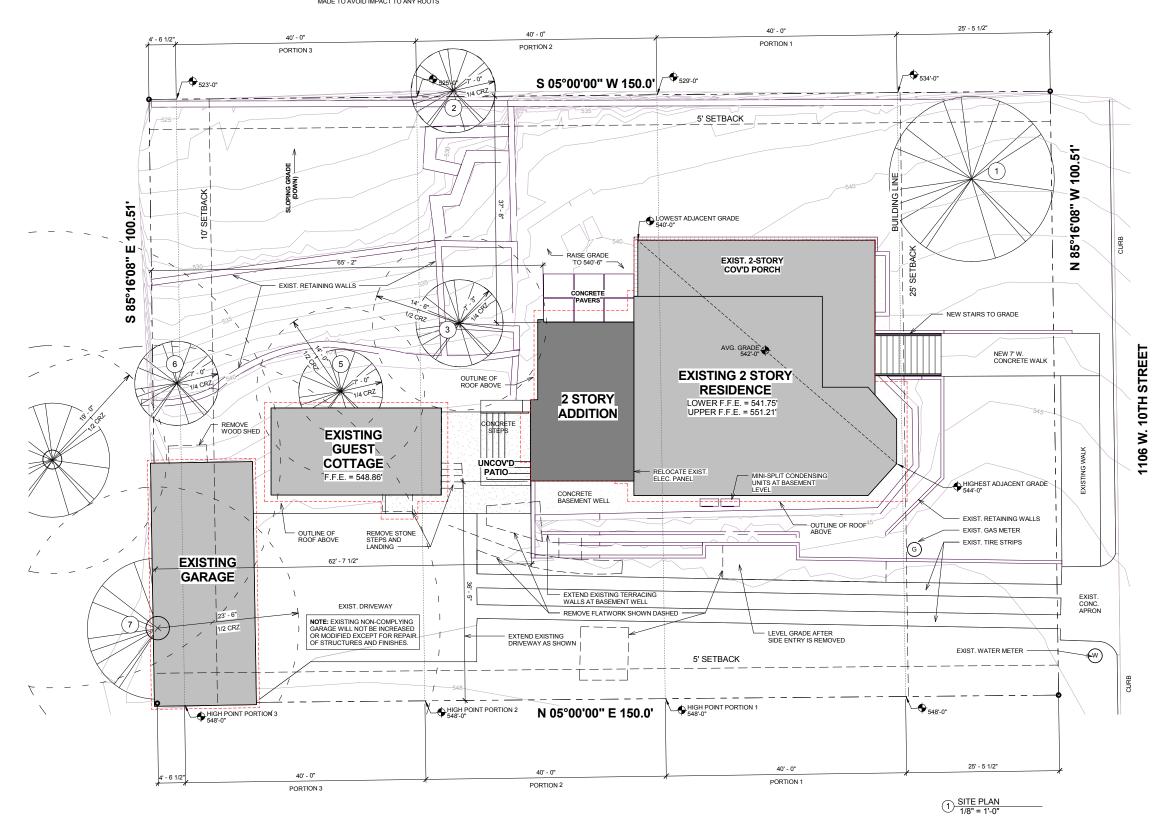



# NOT FOR PERMIT, CONSTRUCTION, OR REGULATORY APPROVAL

Kahlon-Patel Residence

1106 W. 10th St. Austin, Texas 78703

Drawn by CAI, CVM

### SITE PLAN NOTES

- CONTRACTOR RESPONSIBLE FOR VERIFYING ALL EXISTING CONDITIONS
- TAKE MEASURE TO PROVIDE POSITIVE DRAINAGE AWAY FROM BUILDING
- 3. CIVIL ENGINEERING & LANDSCAPING BY OTHERS
- SITE PLAN IS DRAWN FROM INFORMATION ON SURVEY PROVIDED BY OWNER
- 5. ONLY TREES 19" DIAMETER AND GREATER ARE SHOWN ON SITE PLAN WITH CRITICAL ROOT ZONE DIAGRAMS
- 6. PAYMENT IN LIEU OF SIDEWALK INSTALLATION

### TREE PROTECTION NOTES

	TREE LIST
1	55" LIVE OAK
2	28" LIVE OAK
3	29" LIVE OAK
(5)	28" LIVE OAK
6	28" LIVE OAK
7	38" LIVE OAK
8	47" LIVE OAK

- NEW WALKWAY TO MAINTAIN DISTANCE FROM 1/2 CRITICAL ROOT ZONE. EXCAVATION, IF NEEDED, NOT TO EXCEED DEPTH OF EXISTING HARDSCAPE.



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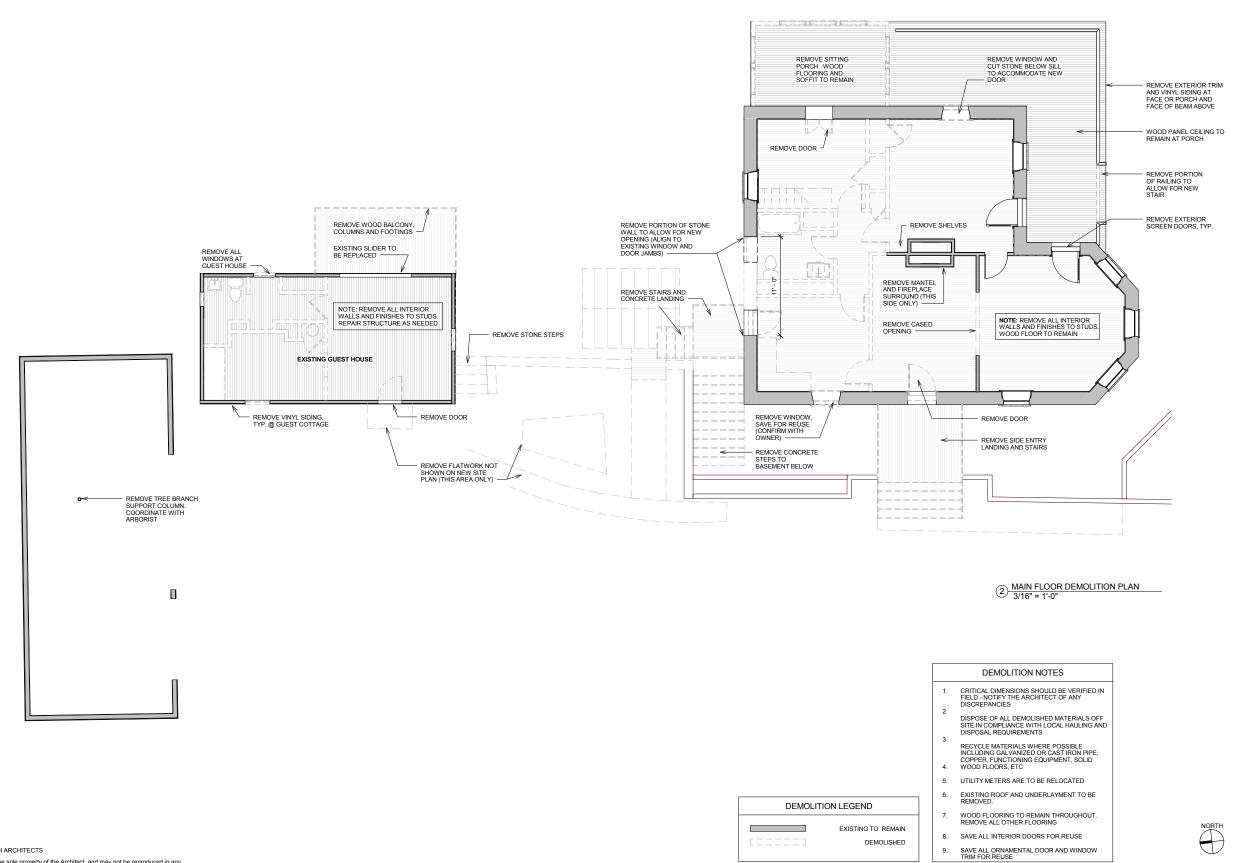
**A0.1** SITE PLAN

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Date: 6.17.15
Issue: HLC SUBMITTAL
Revision: NO.


A0.2

MAIN FLOOR DEMOLITION PLAN




BASEMENT & ATTIC DEMOLITION PLAN

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2 ATTIC DEMOLITION PLAN
3/16" = 1'-0"

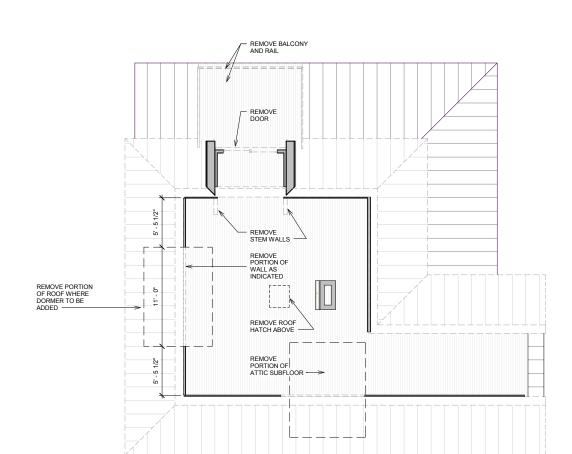

1 BASEMENT DEMOLITION PLAN 3/16" = 1'-0"
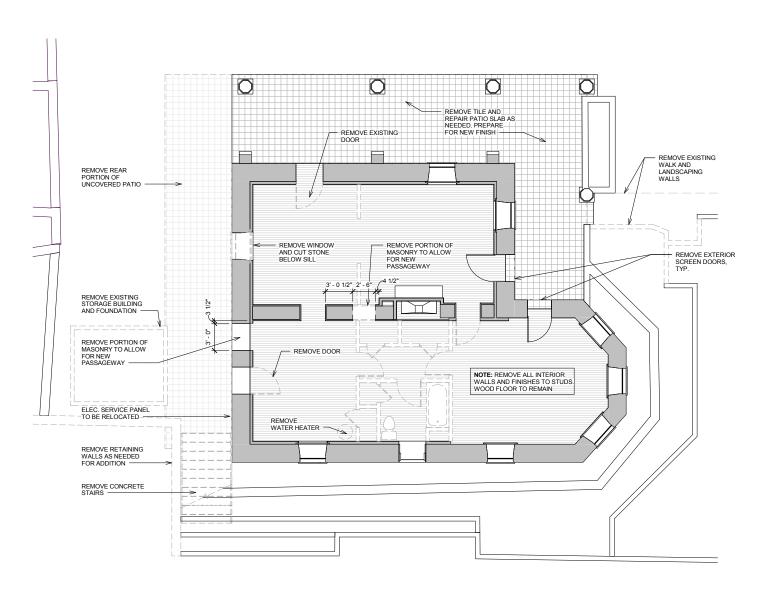
### DEMOLITION NOTES

- CRITICAL DIMENSIONS SHOULD BE VERIFIED IN FIELD NOTIFY THE ARCHITECT OF ANY DISCREPANCIES
- DISPOSE OF ALL DEMOLISHED MATERIALS OFF SITE IN COMPLIANCE WITH LOCAL HAULING AND DISPOSAL REQUIREMENTS
- RECYCLE MATERIALS WHERE POSSIBLE INCLUDING GALVANIZED OR CAST IRON PIPE, COPPER, FUNCTIONING EQUIPMENT, SOLID WOOD FLOORS, ETC

- 5. UTILITY METERS ARE TO BE RELOCATED
- EXISTING ROOF AND UNDERLAYMENT TO BE REMOVED.
- WOOD FLOORING TO REMAIN THROUGHOUT. REMOVE ALL OTHER FLOORING
- 8. SAVE ALL INTERIOR DOORS FOR REUSE
- SAVE ALL ORNAMENTAL DOOR AND WINDOW TRIM FOR REUSE
- EXISTING TO REMAIN

DEMOLITION LEGEND

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**A1.1** 

EXISTING WALL TO REMAIN

----- OVERHEAD FEATURE / ROOF

(SD)


NEW WALL NEW GLASS WALL

SMOKE DETECTOR

CONTRACTOR TO INSTALL BLOCKING IN WALLS AND CEILINGS AS REQUIRED FOR ALL ACCESSORIES, WALL MOUNTED ITEMS, CEILING FAN, ETC. INCLUDING 2X6 BLOCKING INSIDE ALL BATHROOM WALLS AT 36" ABOVE FINISHED FLOOR

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MAIN FLOOR PLAN

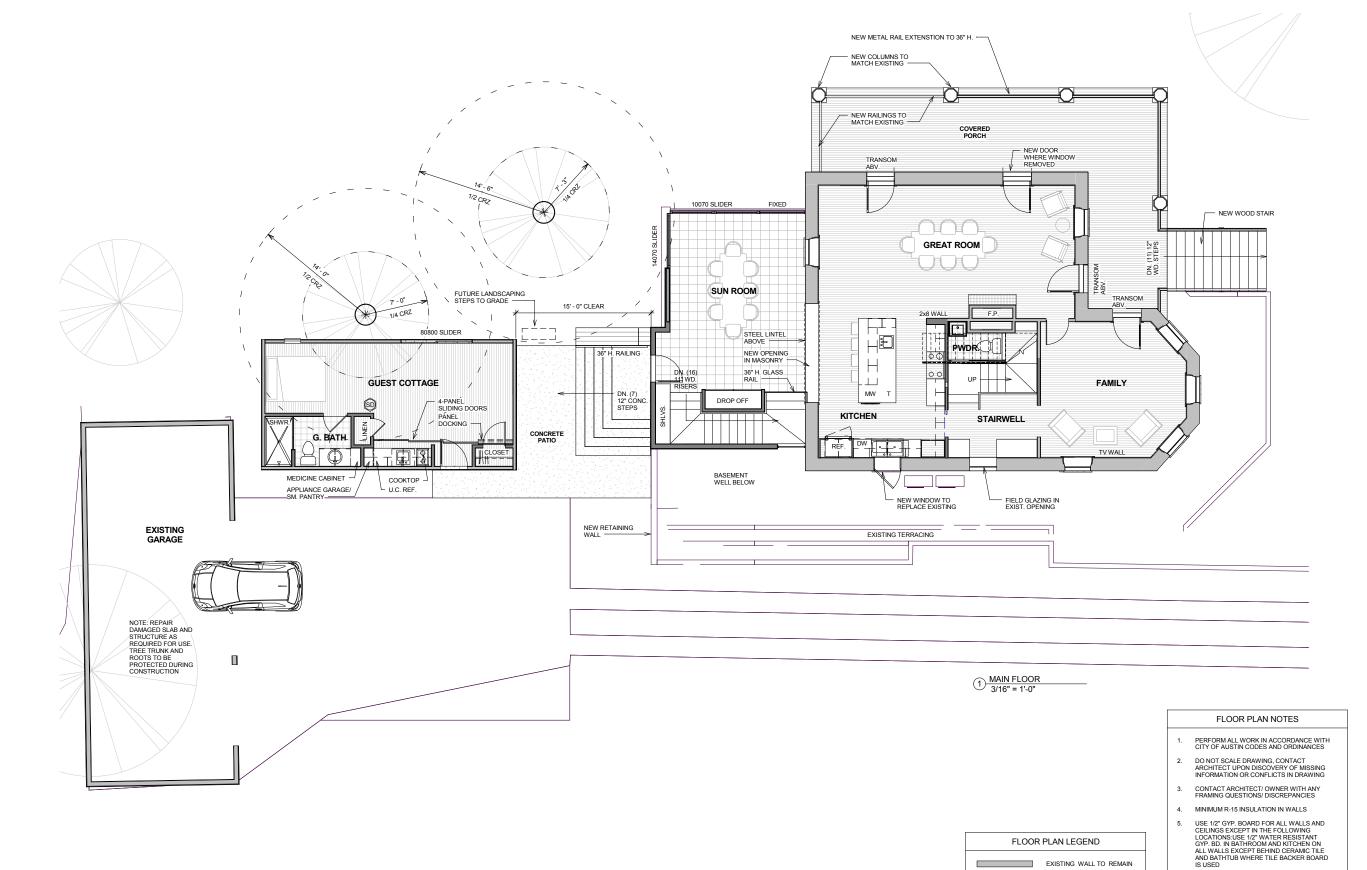


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**A1.2** 

MAIN FLOOR DIMENSION PLAN

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- ALL NEW EXTERIOR WALLS TO BE FRAMED WITH 6" STUDS U.N.O. ALL INTERIOR WALLS TO BE FRAME WITH 4" STUDS U.N.O.



### DIMENSION NOTES

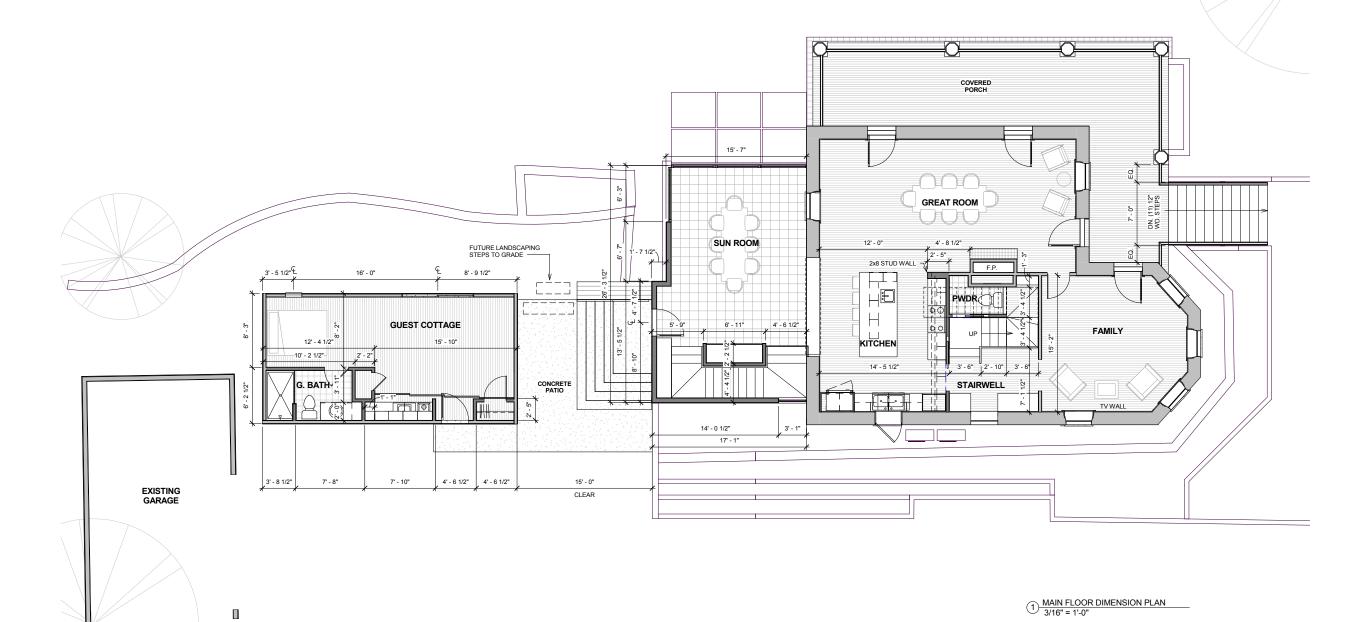- ALL DIMENSIONS ARE TAKEN FROM FACE OF STUD FOR NEW WALLS AND FROM FINISHED FACE OF EXISTING WALLS UNLESS NOTED OTHERWISE

  - FIELD VERIFY ALL DIMENSIONS PRIOR TO CONSTRUCTION
  - DISTANCE BETWEEN HINGE SIDE OF DOOR AND ADJACENT WALL IS 6" UNLESS NOTED OTHERWISE

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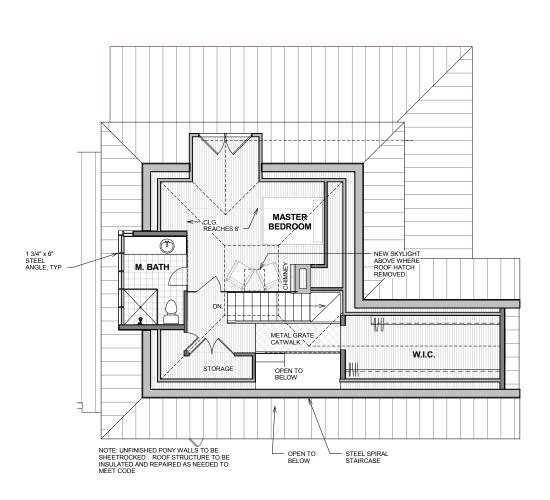
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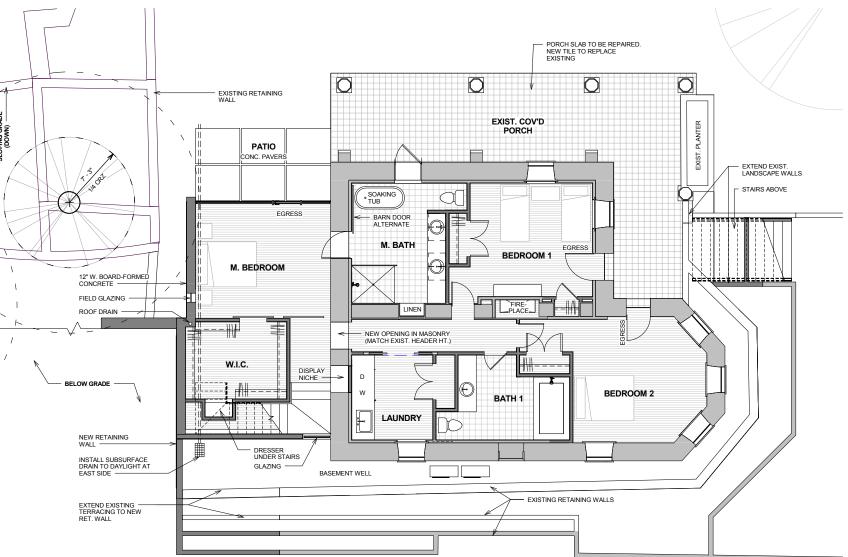
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MINIMUM R-15 INSULATION IN WALLS

USE 1/2" GYP, BOARD FOR ALL WALLS AND CEILINGS EXCEPT IN THE FOLLOWING LOCATIONS: USE 1/2" WATER RESISTANT GYP. BB. IN BATHROOM AND KITCHEN ON ALL WALLS EXCEPT BEHIND CERAMIC TILE AND BATHTUB WHERE TILE BACKER BOARD IS USED





### FLOOR PLAN NOTES

1 BASEMENT 3/16" = 1'-0"

- PERFORM ALL WORK IN ACCORDANCE WITH CITY OF AUSTIN CODES AND ORDINANCES
- DO NOT SCALE DRAWING, CONTACT ARCHITECT UPON DISCOVERY OF MISSING INFORMATION OR CONFLICTS IN DRAWING
- CONTACT ARCHITECT/ OWNER WITH ANY FRAMING QUESTIONS/ DISCREPANCIES
- - CONTRACTOR TO INSTALL BLOCKING IN WALLS AND CEILINGS AS REQUIRED FOR ALL ACCESSORIES, WALL MOUNTED ITEMS, ACCESSORIES, WALL MOUNTED TIEMS, CEILING FAN, ETC. INCLUDING 2X6 BLOCKING INSIDE ALL BATHROOM WALLS AT 36" ABOVE FINISHED FLOOR

NEW GLASS WALL OVERHEAD FEATURE / ROOF

SMOKE DETECTOR

FLOOR PLAN LEGEND

(SD)

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BASEMENT & ATTIC FLOOR **PLANS** 7 of 15

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**A1.4** 


BASEMENT & ATTIC DIMENSION PLAN


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- ALL NEW EXTERIOR WALLS TO BE FRAMED WITH 6" STUDS U.N.O. ALL INTERIOR WALLS TO BE FRAME WITH 4" STUDS U.N.O.
- FIELD VERIFY ALL DIMENSIONS PRIOR TO CONSTRUCTION
- DISTANCE BETWEEN HINGE SIDE OF DOOR AND ADJACENT WALL IS 6" UNLESS NOTED OTHERWISE



1 BASEMENT DIMENSION PLAN
3/16" = 1'-0"



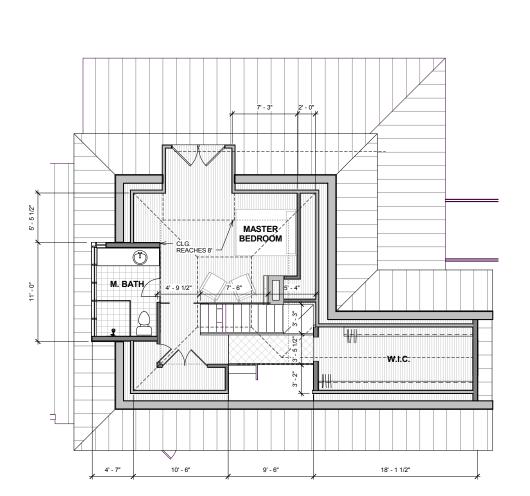

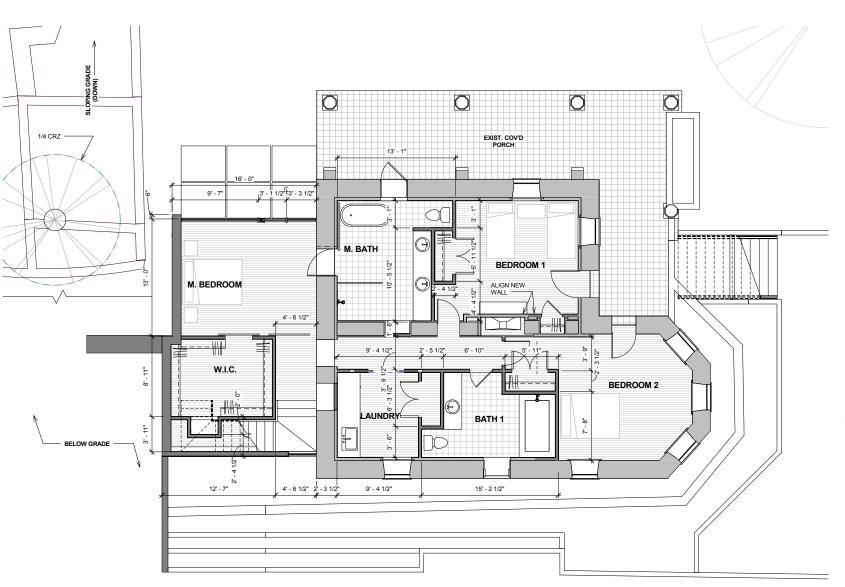2 ATTIC DIMENSION PLAN
3/16" = 1'-0"

### DIMENSION NOTES

- ALL DIMENSIONS ARE TAKEN FROM FACE OF STUD FOR NEW WALLS AND FROM FINISHED FACE OF EXISTING WALLS UNLESS NOTED OTHERWISE

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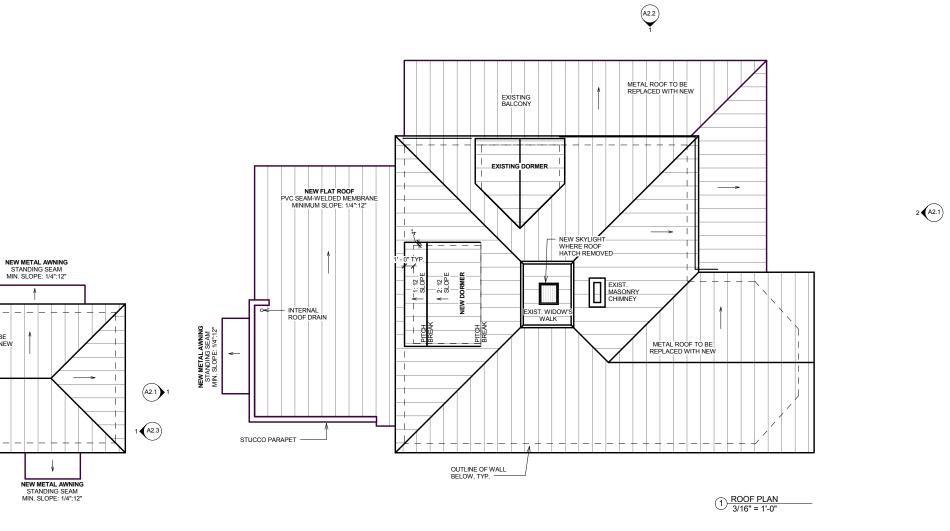
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A1.5

**ROOF PLAN** 

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NORTH





### ROOF LEGEND EXISTING ROOF TO BE REPLACED NEW ROOF ─ ─ ─ OUTLINE OF WALLS BELOW LOW-SLOPE ROOF DRAINS WITH DRAINAGE ARROWS

### ROOF PLAN NOTES

- 1. VENT ALL MECH/ PLUMBING FIXTURES
- 2. ALL VENTS THROUGH THE ROOF (VTR) TO BE PAINTED TO MATCH ROOF COLOR
- PROVIDE R-38 INSULATION BETWEEN NEW ROOF AND CEILING
- EXISTING ROOFS TO RECEIVE NEW UNDERLAYMENT, INSULATION AND METAL ROOF
- FLASHING, UNDERLAYMENT AND FASTENING DETAILS PER ROOF MANFUNFACTURER. INSTALLER TO VERIFY WITH ARCHITECT
- NEW ROOF SHALL BE AN UNVENTED FLAT ROOF SYSTEM
- 7. CONFIRM DOWNSPOUT LOCATIONS WITH ARCHITECT PRIOR TO INSTALLATION

(A2.3) 2

METAL ROOF TO BE REPLACED WITH NEV

OUTLINE OF WALL BELOW, TYP.


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\_GARAGE ROOF\_ TO REMAIN

**A2.1 EXTERIOR** 


**ELEVATIONS** 10 of 15


MAX. BUILDING HEIGHT (32' ABOVE AVERAGE GRADE) NEW METAL ROOF TO REPLACE EXISTING, TYP. METAL PANEL T.O. PONY WALL METAL AWNING WITH EXPOSED METAL JOISTS MAIN FLOOR PLT MAIN FLOOR PLT STUCCO NEW RAILING TO MATCH EXIST — POWDER COATED METAL PANEL GLASS GLASS MAIN FLOOR MAIN FLOOR GLASS → EXISTING MASONRY RETAINING WALL BEYOND CAST IN PLACE CONCRETE STAIRS HIGHEST GRADE @ PORTIONS 1, 2 & 3 = 548.0' BOARD -FORMED CONCRETE OUTLINE OF BASEMENT BEYOND - AVERAGE GRADE = 544.0' 1 NORTH (REAR) ELEVATION 3/16" = 1'-0"

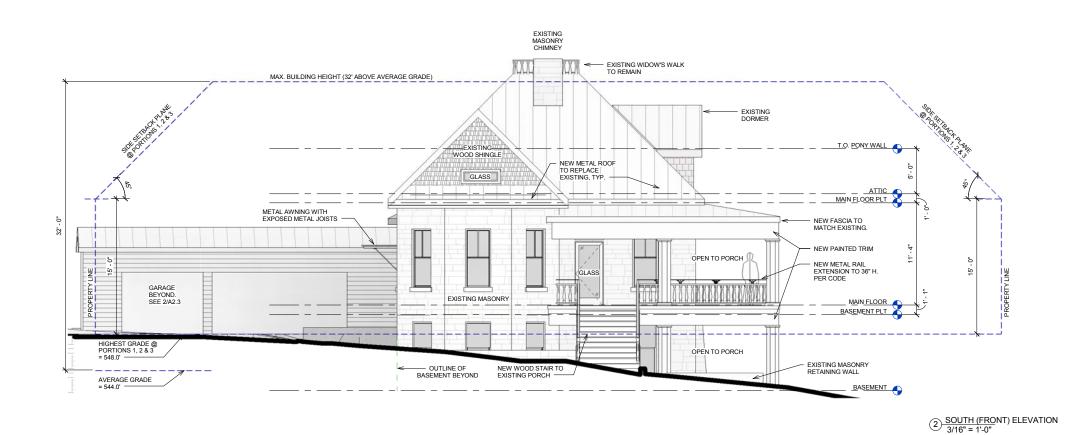

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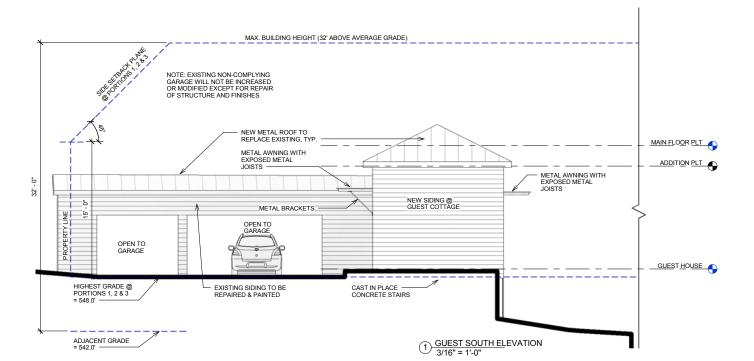
**ELEVATIONS** 




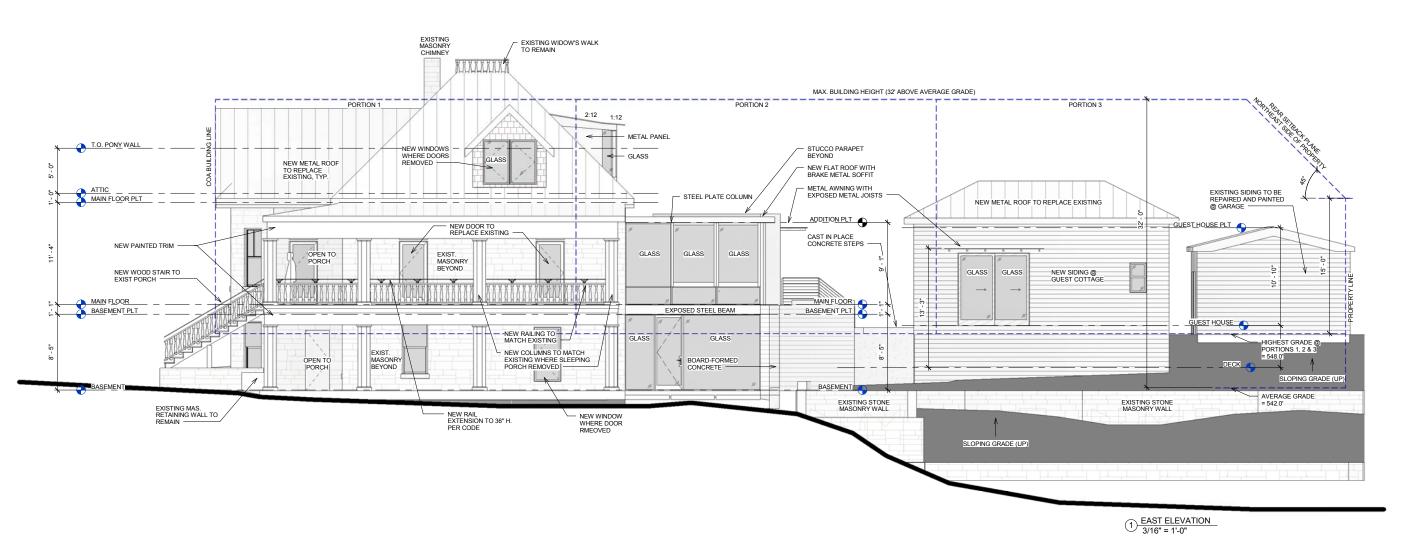

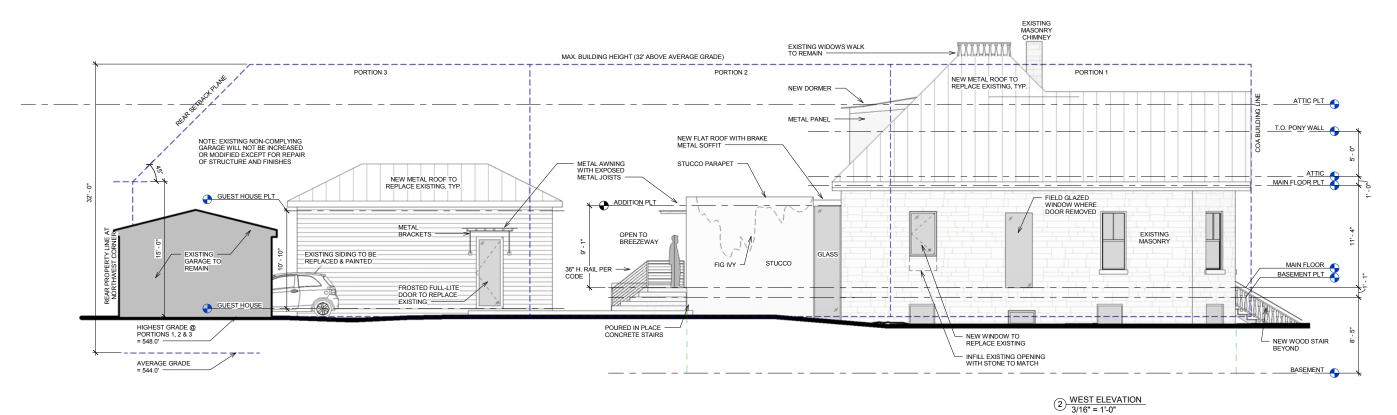
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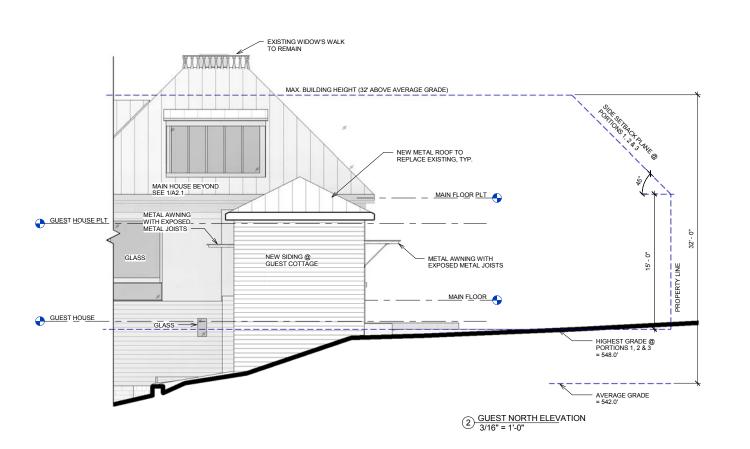




### 3 DECK RAILING 3/4" = 1'-0"

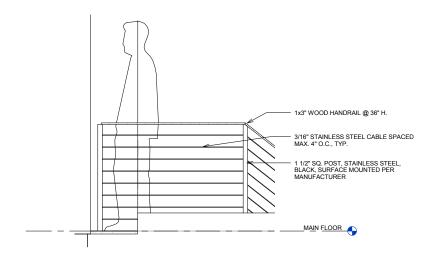


4 HISTORIC RAILING EXTENSION
3/4" = 1'-0"

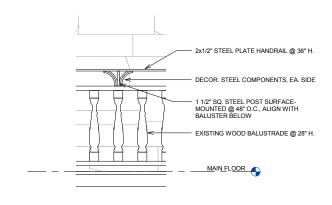

NOTE: PLEASE REFERENCE PHOTO BINDER FILE FOR CORRESPONDING VIEWS

**A8.1** 

PICTURE LOCATION DIAGRAM 13 of 15

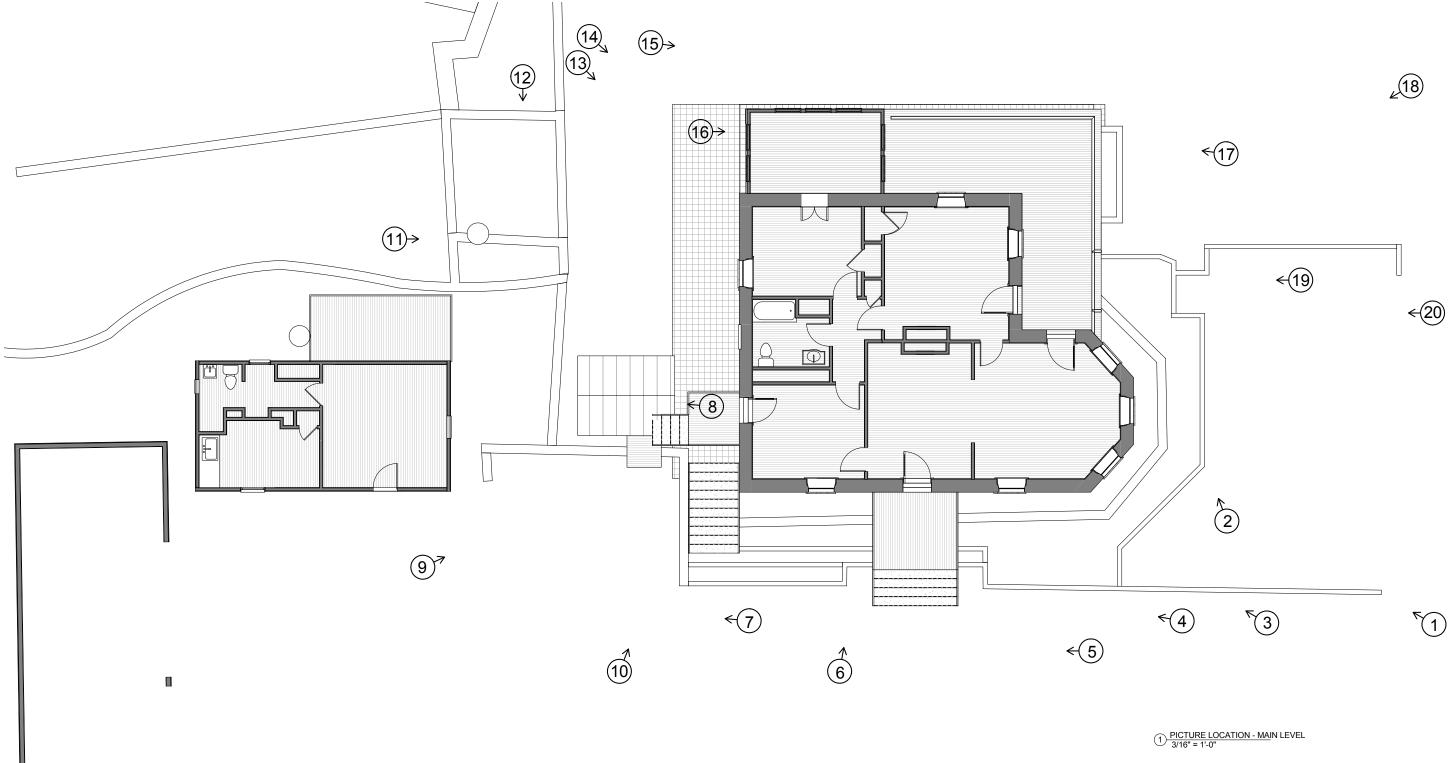


# Kahlon-Patel Residence


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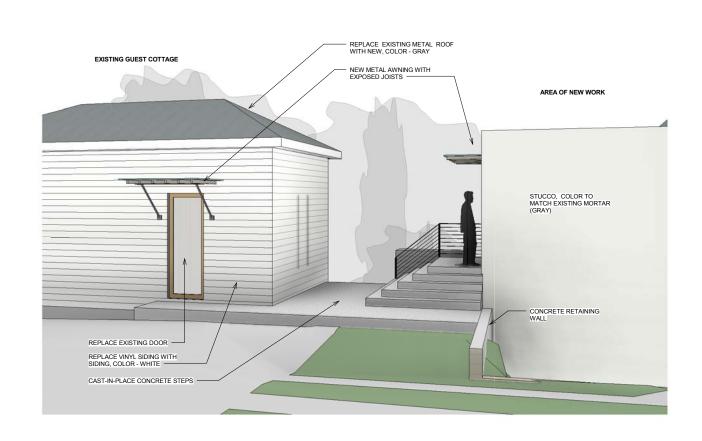
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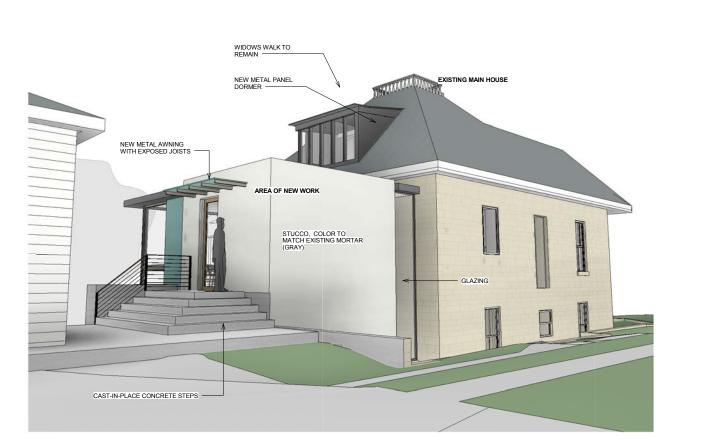
A9.1

3D EXTERIOR **VIEWS** 





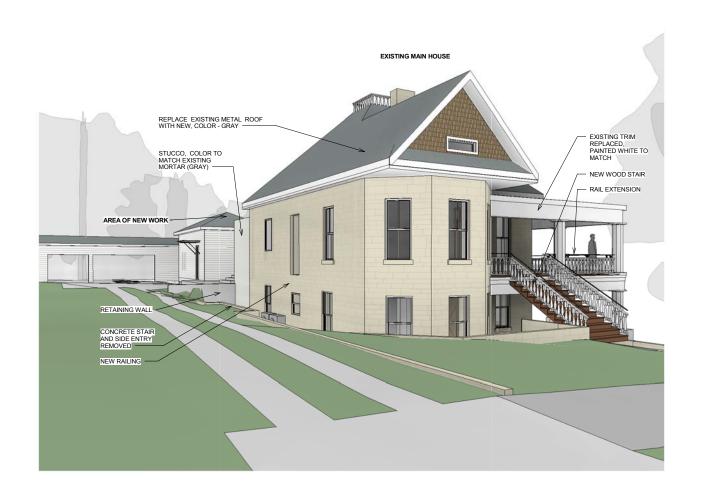

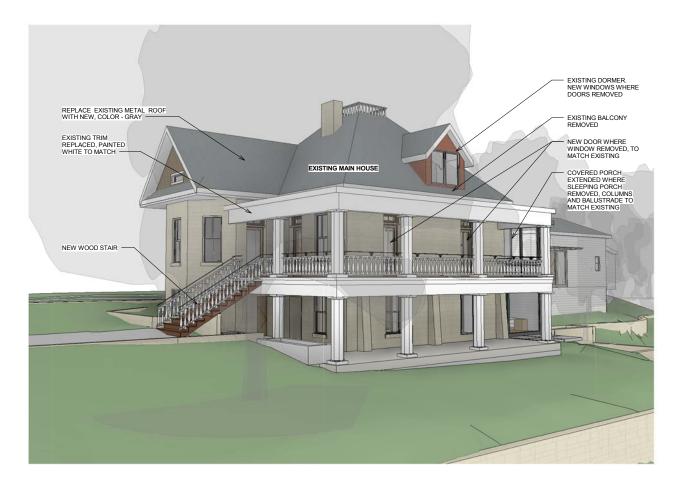

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A9.2

3D EXTERIOR VIEWS

