

All rights reserved. All designs, drawings, plans & specifications are the property of RODENBERG DESIGN / DEVELOPMENT, LLP. Purchaser's rights are conditional & limited to a one-time use to construct a single project on the site & use is limited specifications are the property of RODENBERG DESIGN / DEVELOPMENT, LLP.

JOSEPH BUILDERS

RD/D

Rodenberg Design Development Ryan Rodenberg 512.796.5995 rrodenberg@gmail.com

> THERESA - LOT 5 USTIN, TEXAS 78703

DRAWN BY: RR

RR

 $\infty$ 

CONTACT:

DATE: 3/17/17


JOB #: 17.03


SURVEY

A0.2

1 30111

FULL SIZE SCALE: 1" = 15'
HALF SIZE SCALE: 1" = 30'

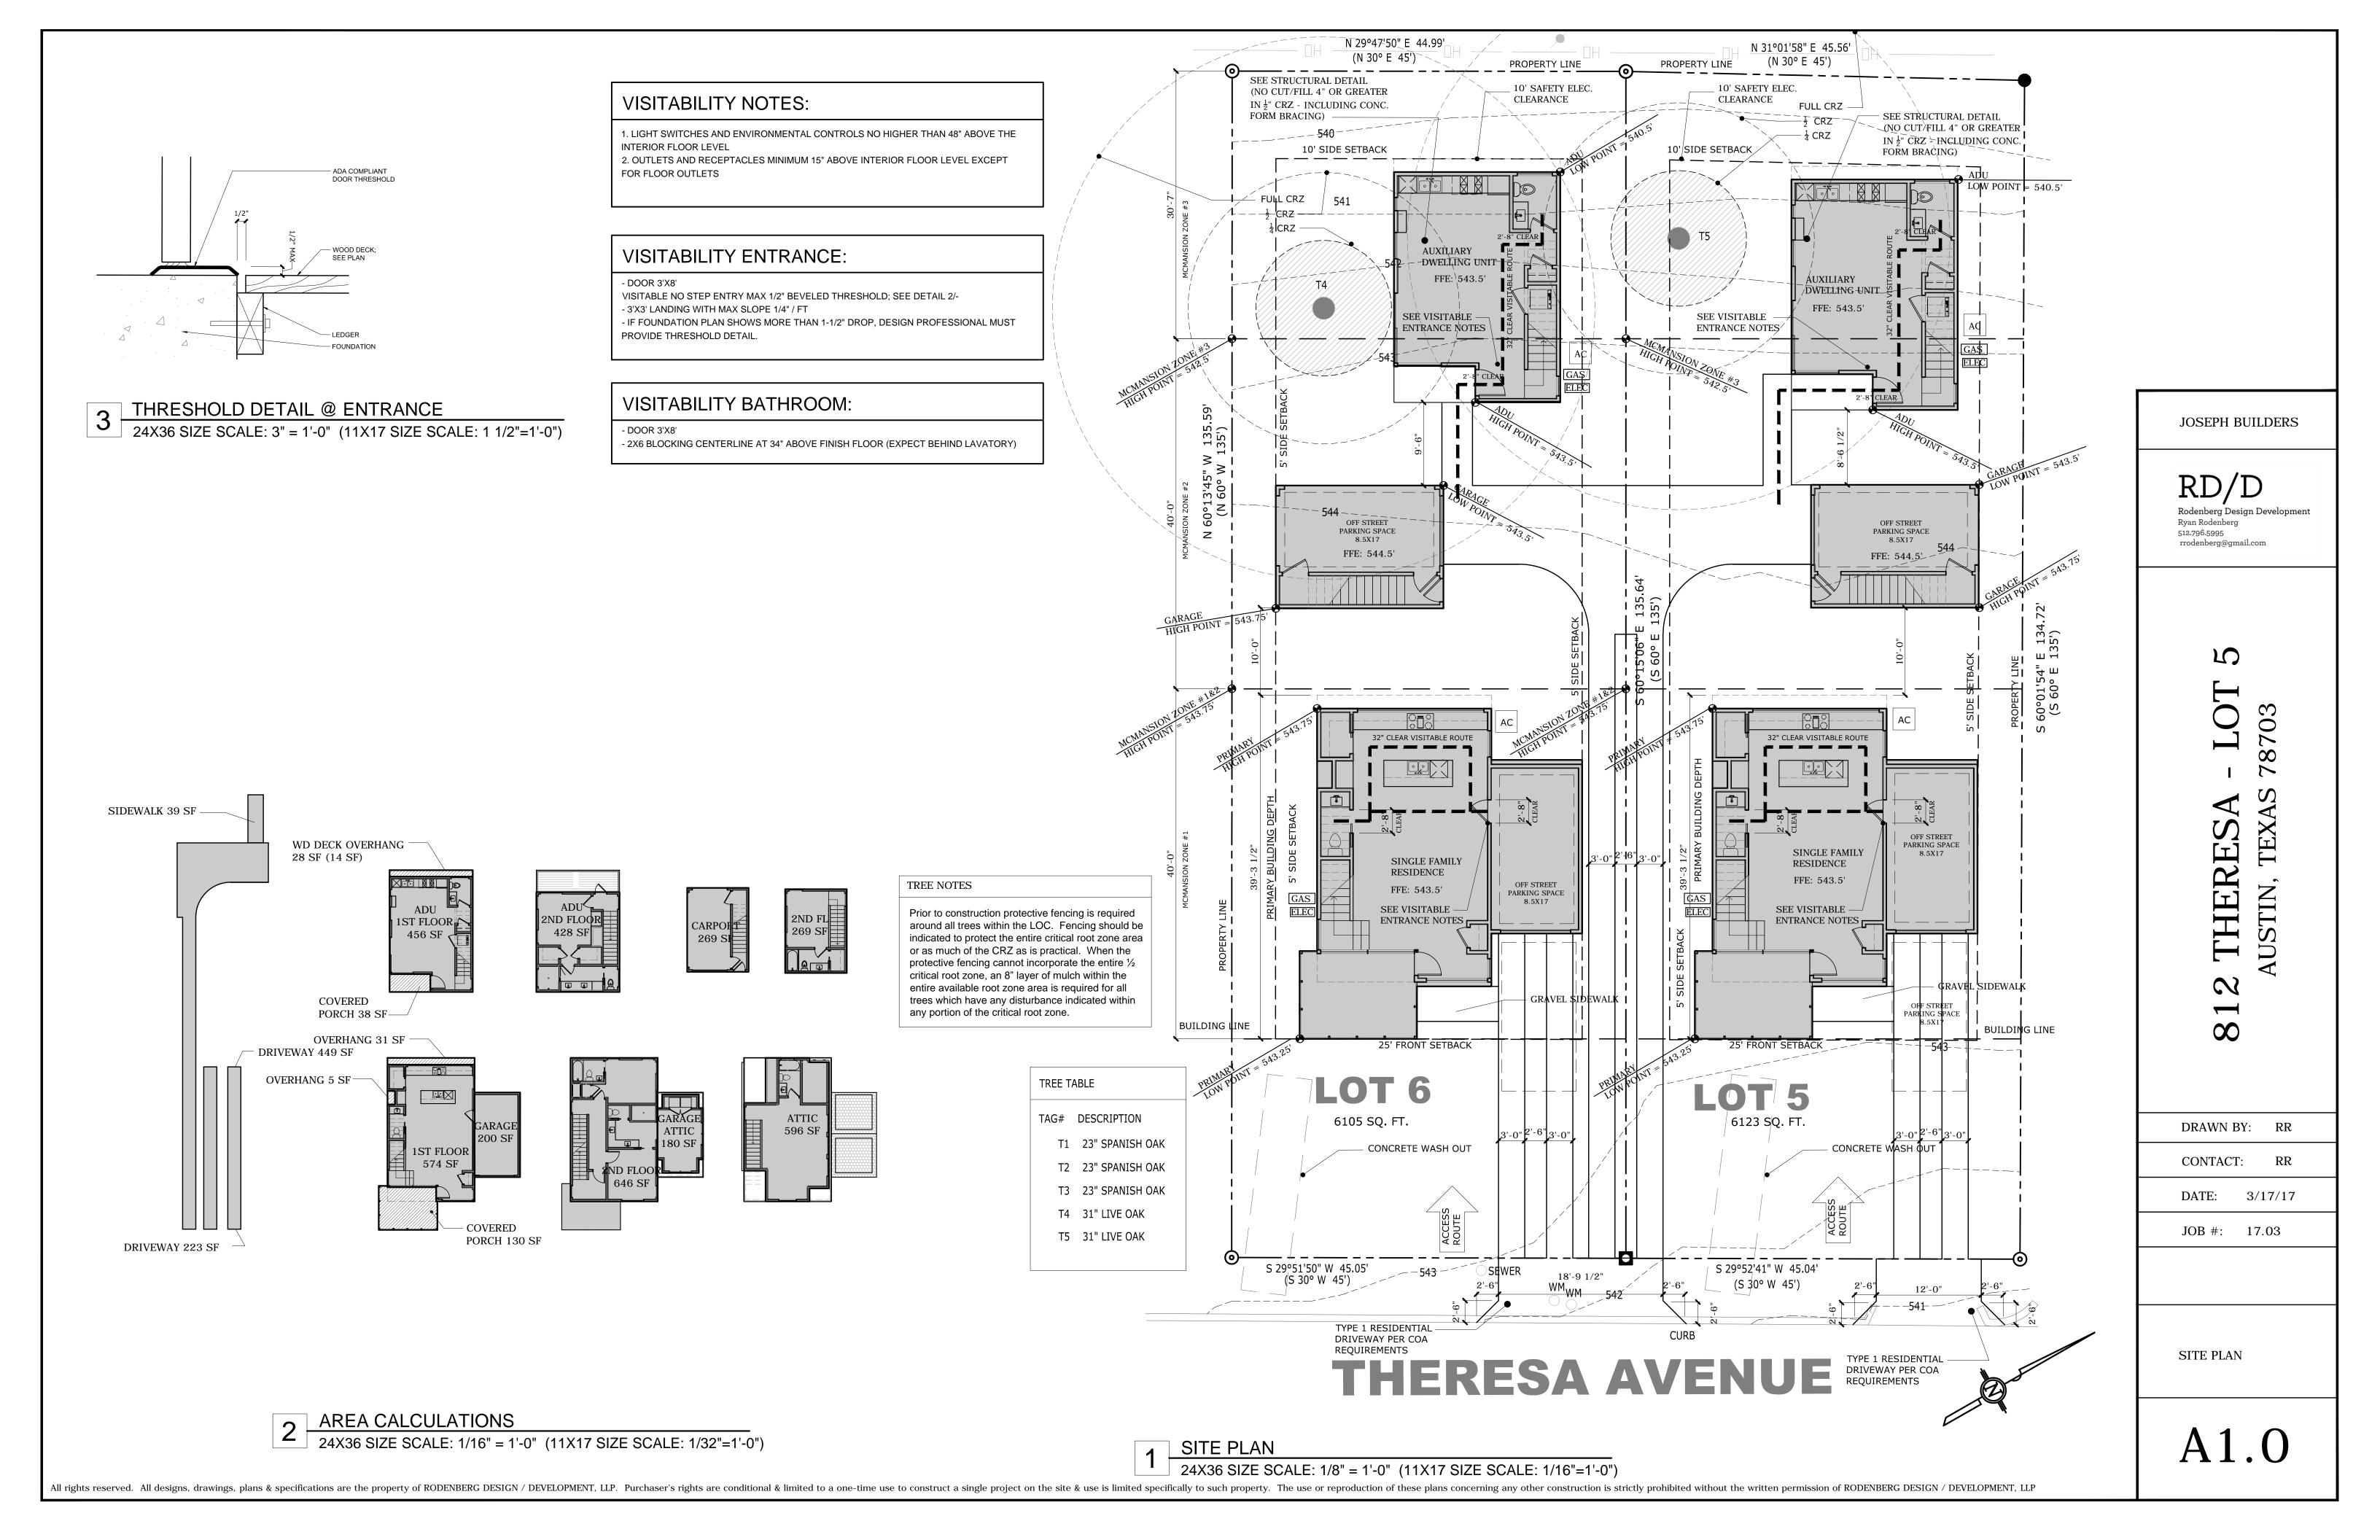

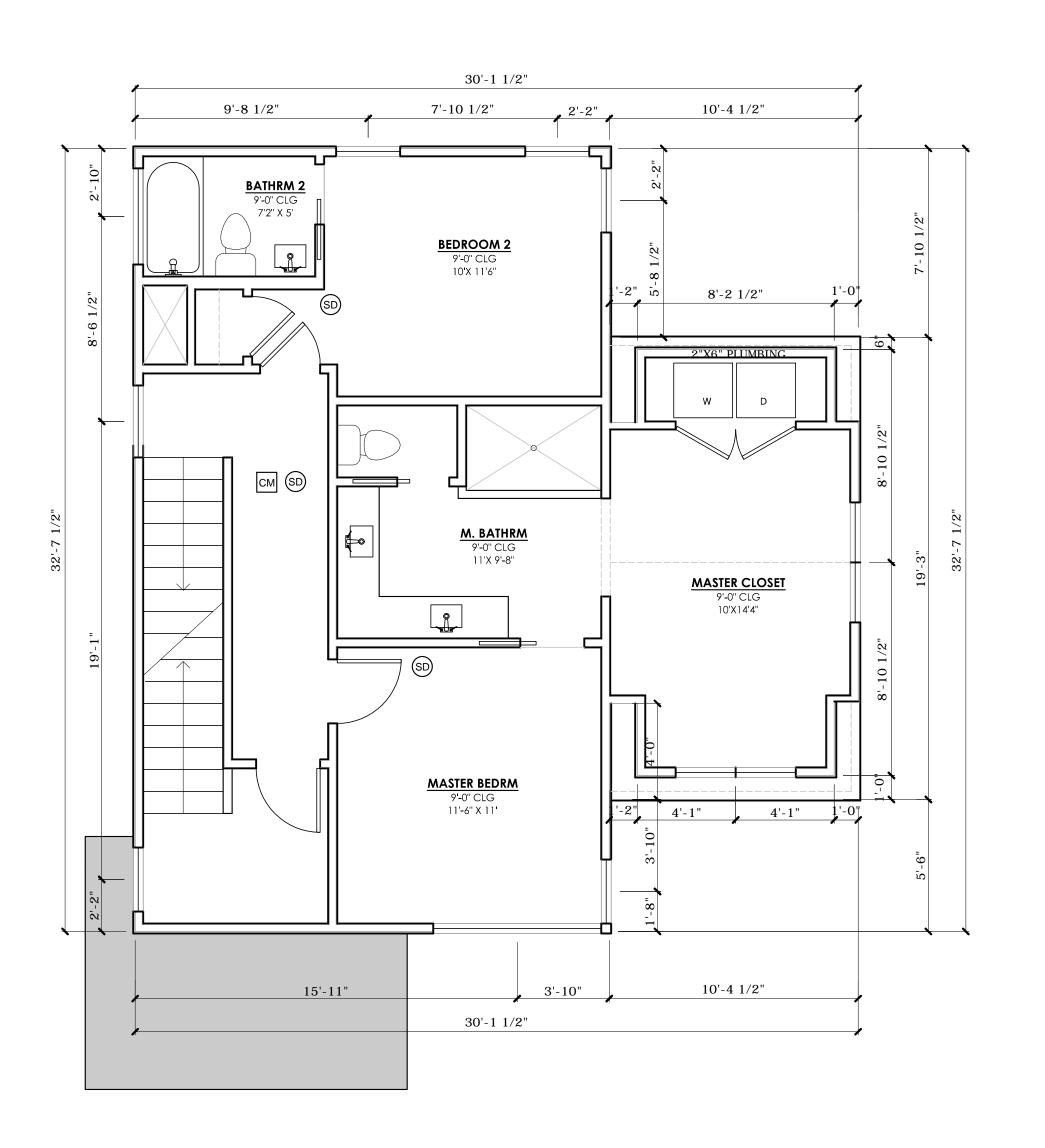

PRIMARY - SECOND FLOOR PLAN

24X36 SIZE SCALE: 1/4" = 1'-0" (11X17 SIZE SCALE: 1/8"=1'-0")

# **GENERAL NOTES:**

- FLOORING:

FIRST FLOOR: SEALED CONCRETE

SECOND FLOOR:  $\frac{5}{8}$  T & G WOOD THROUGHOUT.

BATHROOMS, LAUNDRY; TILE: x; PORCELAIN TILE ON HARDIBACKER OVER  $\frac{3}{4}$ " T&G PLYWOOD DECK.

ALL WALLS; 2X4; PLUMBING WALLS; 2X6. INSULATE EXTERIOR WALLS R-19 MIN. FORM INSULATE ROOF, R-38 MIN.

# - ALL DOOR HAVE A 96" HEIGHT



NOTES:

SD SMOKE DETECTOR INSTALLED IN ACCORDANCE WITH IRC 2012 R314

CARBON MONOXIDE DETECTOR INSTALLED IN ACCORDANCE WITH IRC 2012 R315

# PLAN NOTES:


1. ALL EGRESS WINDOWS AND DOORS TO COMPLY WITH 2012 IRC R310.1, R311.2, R312.2.

2. STAIRS, HANDRAILS, AND GUARDRAILS TO COMPLY WITH 2012 IRC R311.5.1, R311.7, R312.1.

3. FIRST FLOOR OF NEW CONSTRUCTION WITH ANY LIVING SPACE TO COMPLY WITH ALL VISITABILITY STANDARDS UNDER CITY CODE SEC. 25-12-243, R320. VISITABILITY ITEMS ARE REFERENCED ON FLOOR PLANS.

JOSEPH BUILDERS

Rodenberg Design Development Ryan Rodenberg 512.796.5995 rrodenberg@gmail.com

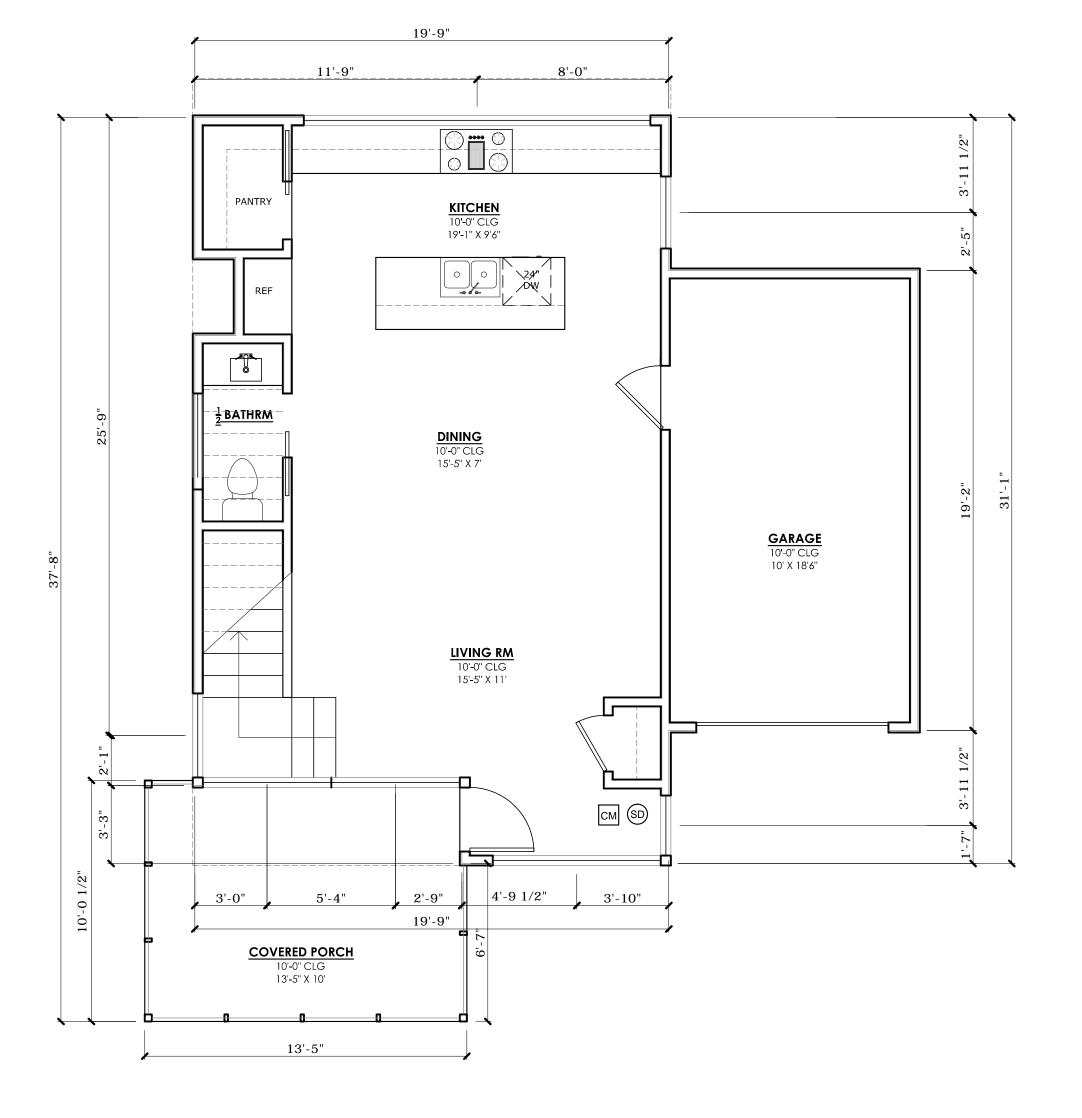

PRIMARY - FIRST FLOOR PLAN

24X36 SIZE SCALE: 1/4" = 1'-0" (11X17 SIZE SCALE: 1/8"=1'-0")

8703 THER

DRAWN BY: RR

CONTACT: RR

DATE: 3/17/17

JOB #: 17.03


PRIMARY -FLOOR PLANS

A2.0

All rights reserved. All designs, drawings, plans & specifications are the property of RODENBERG DESIGN / DEVELOPMENT, LLP. Purchaser's rights are conditional & limited to a one-time use to construct a single project on the site & use is limited specifically to such property. The use or reproduction of these plans concerning any other construction is strictly prohibited without the written permission of RODENBERG DESIGN / DEVELOPMENT, LLP.

# **GENERAL NOTES:**

- 1. DIMENSIONS INDICATED ARE HORIZONTAL PLAN DIMENSIONS.
- 2. REFER TO REFLECTED CEILING PLAN FOR EXTENT OF SOFFITS.
- 3. ROOF VENT LOCATIONS ARE NOT SHOWN. COORDINATE WITH OTHER TRADES FOR EXACT LOCATION OF ALL ROOF PENETRATIONS CENTERED IN METAL ROOF PANEL SYMMETRICAL WITH STANDING SEAMS AT 12" O.C., AND COORDINATE WITH RAFTERS AT 16" O.C.
- 4. ROOF ASSEMBLY: METAL ROOF SYSTEM, MBCI "BATTENLOK HS" OR APPROVED EQUAL, MINIMUM 24 GAUGE PERFORMED, GALVALUME, LARGE BATTEN, VERTICAL LEG, CONCEALED FASTENER, STANDING SEAM METAL ROOF SYSTEM, CONTINUOUSLY LOCKED, MECHANICALLY SEAMED ROOF PANEL SYSTEM.
- 5. BREATHABLE, HIGH TEMP METAL ROOF UNDERLAYMENT PER MANUFACTURER'S RECOMMENDATIONS TITANIUM UDL 50 OR SIMILAR. PROVIDE 1" UNDER-DECK VENTILATION / AIR SPACE WHEN USING POLYURETHANE FOAM INSULATION.
- 6. ALL ROOF PENETRATIONS, CURBS, FLUES, VENTS, VENT CAPS, HOODS, FAN HOUSINGS, ETC. SHALL BE FINISHED OR PAINTED TO MATCH ROOF
- 7. PROVIDE FLEXIBLE PIPE FLASHINGS UNITS AT ALL PLUMBING, COOKTOP/RANGE, AND DRYER VENT PENETRATIONS THROUGH THE METAL ROOF.
- 8. ALL HARDWARE IN CONTACT WITH PRESERVATIVE PRESSURE TREATED (PPT) LUMBER SHALL BE STAINLESS STEEL, DOUBLE HOT DIPPED GALVANIZED, OR TRIPLE ZINC (ZMAX), INCLUDING STRUCTURAL METAL ANCHORS, ANGLES OR TIES, BOLTS, NAILS, LAG SCREWS AND SCREWS.

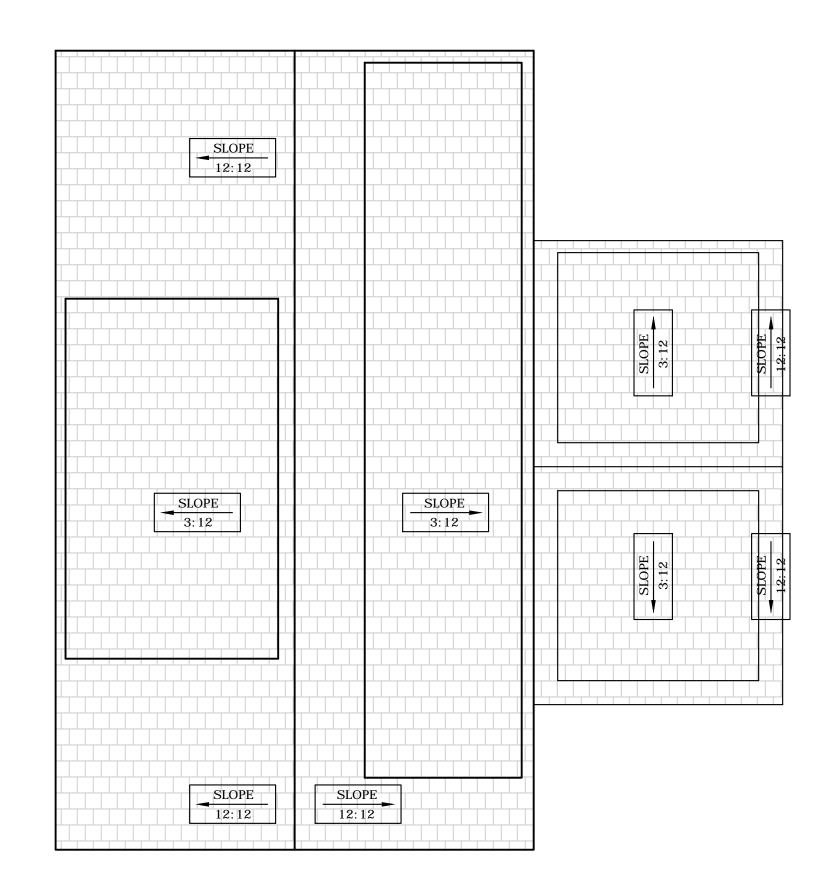

PRIMARY - ROOF PLAN

24X36 SIZE SCALE: 1/4" = 1'-0" (11X17 SIZE SCALE: 1/8"=1'-0")

# GENERAL NOTES: - FLOORING: FIRST FLOOR: SEALED CONCRETE SECOND FLOOR: 5" T & G WOOD THROUGHOUT. BATHROOMS, LAUNDRY; TILE: x; PORCELAIN TILE ON HARDIBACKER OVER 3" T&G PLYWOOD DECK. - ALL WALLS; 2X4; PLUMBING WALLS; 2X6. INSULATE EXTERIOR WALLS R-19 MIN. - FORM INSULATE ROOF, R-38 MIN. - ALL DOOR HAVE A 96" HEIGHT

# NOTES:




SMOKE DETECTOR INSTALLED IN ACCORDANCE WITH IRC 2012 R314



CARBON MONOXIDE
DETECTOR INSTALLED
IN ACCORDANCE WITH
IRC 2012 R315

# PLAN NOTES:

- 1. ALL EGRESS WINDOWS AND DOORS TO COMPLY WITH 2012 IRC R310.1, R311.2, R312.2.
- 2. STAIRS, HANDRAILS, AND GUARDRAILS TO COMPLY WITH 2012 IRC R311.5.1, R311.7, R312.1.
- 3. FIRST FLOOR OF NEW CONSTRUCTION WITH ANY LIVING SPACE TO COMPLY WITH ALL VISITABILITY STANDARDS UNDER CITY CODE SEC. 25-12-243, R320. VISITABILITY ITEMS ARE REFERENCED ON FLOOR PLANS.

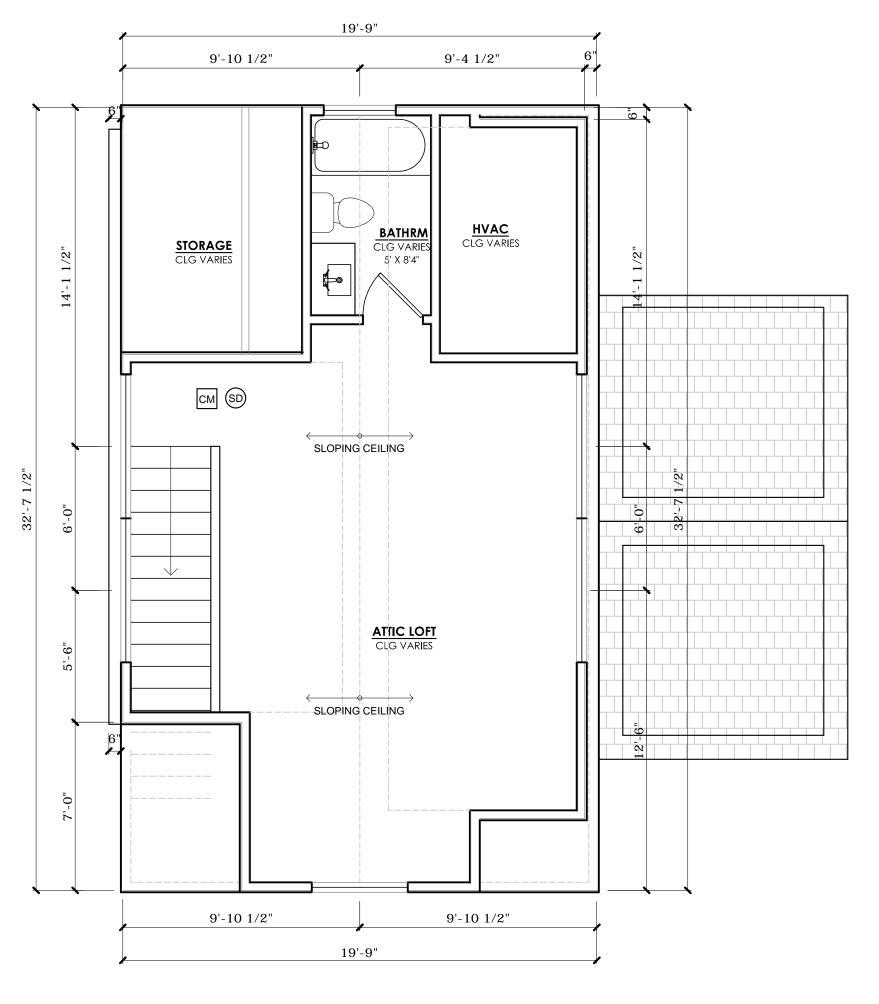

PRIMARY - ATTIC FLOOR PLAN

24X36 SIZE SCALE: 1/4" = 1'-0" (11X17 SIZE SCALE: 1/8"=1'-0")

JOSEPH BUILDERS

RD/D
Rodenberg Design Development
Ryan Rodenberg
512.796.5995

rrodenberg@gmail.com

812 THERESA - LOT 5 AUSTIN, TEXAS 78703

DRAWN BY: RR

CONTACT: RR


DATE: 3/17/17

JOB #: 17.03


PRIMARY -FLOOR PLANS

A2.1

GENERAL NOTES:	PLAN NOTES:	NOTES:	
- ALL WALLS; 2X4; LAUNDRY WALLS; 2X6. INSULATE EXTERIOR WALLS R-19 MIN FORM INSULATE ROOF, R-38 MIN.	<ol> <li>ALL EGRESS WINDOWS AND DOORS TO COMPLY WITH 2012 IRC R310.1, R311.2, R312.2.</li> <li>STAIRS, HANDRAILS, AND GUARDRAILS TO COMPLY WITH 2012 IRC R311.5.1, R311.7, R312.1.</li> </ol>		SMOKE DETECTOR INSTALLED IN ACCORDANCE WITH IRC 2012 R314  CARBON MONOXIDE DETECTOR INSTALLED IN ACCORDANCE WITH IRC 2012 R315
	3. FIRST FLOOR OF NEW CONSTRUCTION WITH ANY LIVING SPACE TO COMPLY WITH ALL VISITABILITY STANDARDS UNDER CITY CODE SEC. 25-12-243, R320. VISITABILITY ITEMS ARE REFERENCED ON FLOOR PLANS.	СМ	

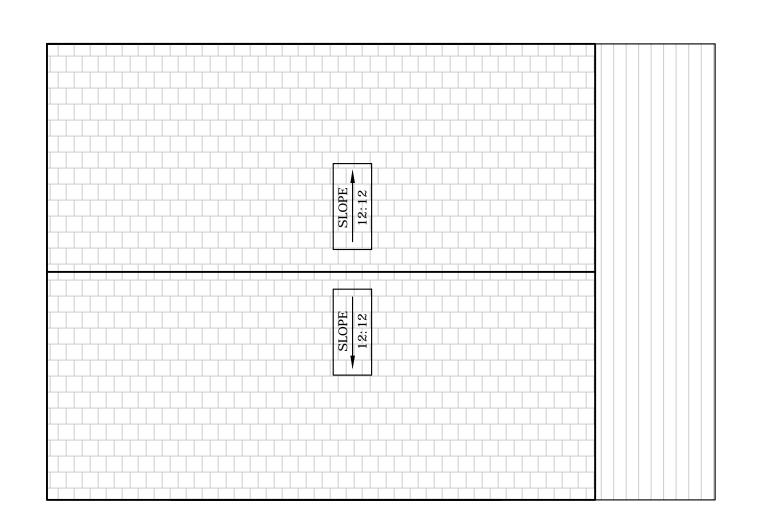


6 ADU - ROOF PLAN
24X36 SIZE SCALE: 1/4" = 1'-0" (11X17 SIZE SCALE: 1/8"=1'-0")

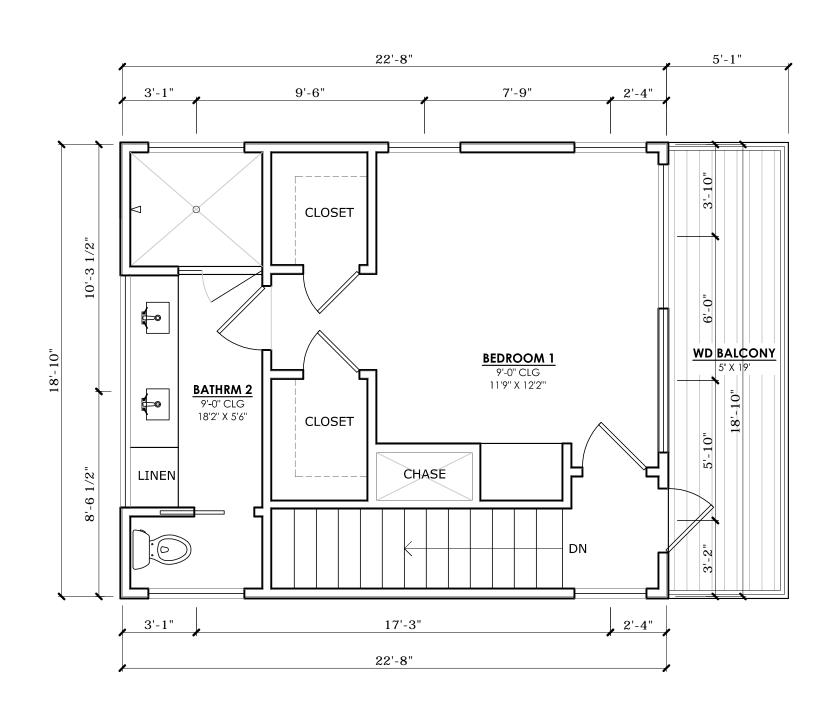


ADU - SECOND FLOOR


24X36 SIZE SCALE: 1/4" = 1'-0" (11X17 SIZE SCALE: 1/8"=1'-0")

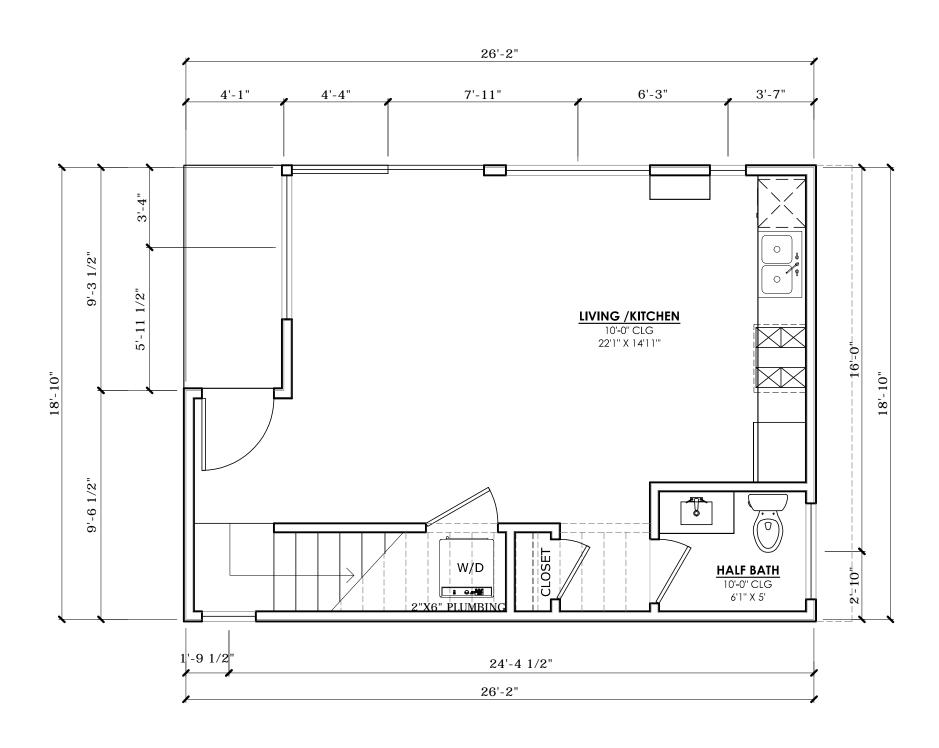


2 ADU - FIRST FLOOR PLAN
24X36 SIZE SCALE: 1/4" = 1'-0" (11X17 SIZE SCALE: 1/8"=1'-0")

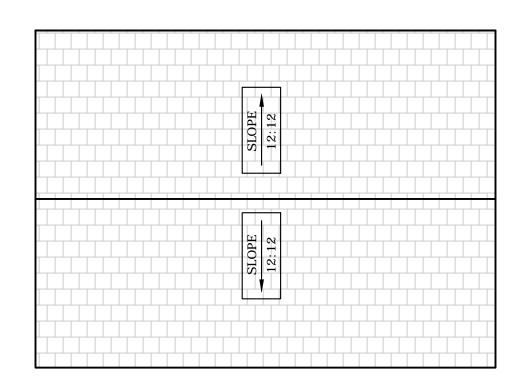

5 CARPORT - ROOF PLAN
24X36 SIZE SCALE: 1/4" = 1'-0" (11X17 SIZE SCALE: 1/8"=1'-0")

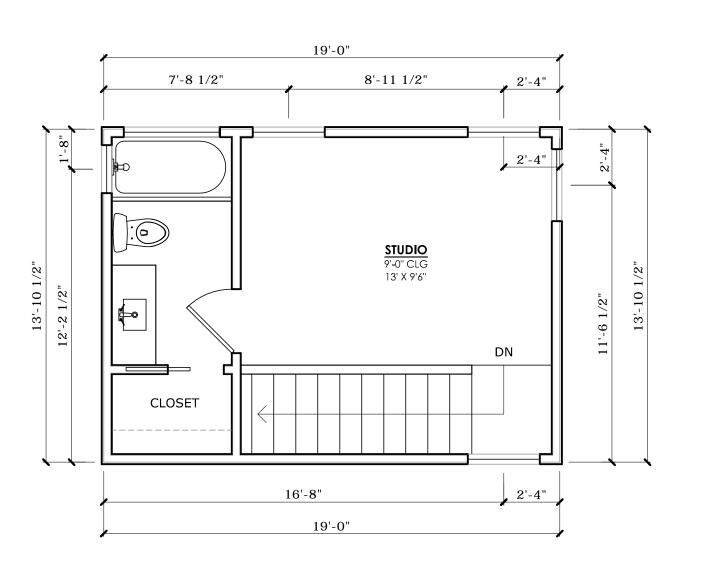

3 CARPORT - SECOND FLOOR
24X36 SIZE SCALE: 1/4" = 1'-0" (11X17 SIZE SCALE: 1/8"=1'-0")

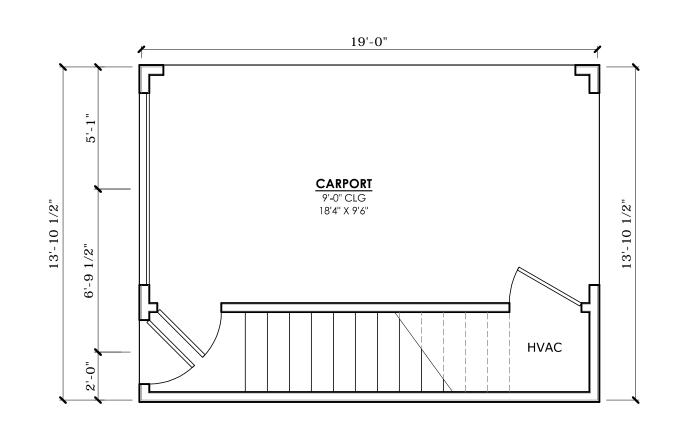

1 CARPORT - FIRST FLOOR PLAN
24X36 SIZE SCALE: 1/4" = 1'-0" (11X17 SIZE SCALE: 1/8"=1'-0")

JOSEPH BUILDERS

RD/D

Rodenberg Design Development
Ryan Rodenberg
512.796.5995
rrodenberg@gmail.com

812 THERESA - LOT 5 AUSTIN, TEXAS 78703

DRAWN BY: RR

CONTACT: RR

DATE: 3/17/17

JOB #: 17.03

ADU -FLOOR PLANS

A2.2

### FINISH NOTES:

- ALL SIDING, FASCIA, AND EXTERIOR ELEMENTS TO BE SMOOTH FINISH


### SIDING NOTES:

- TYPE 1 SIDING: FIBER CEMENT BOARD AND BATTEN SIDING "HARDIE BOARD" BY JAMES HARDIE. COLOR TO BE SELECTED BY ARCHITECT. SMOOTH FINISH.

- TYPE 2 SIDING: FIBER CEMENT BOARD AND BATTEN SIDING "HARDIE BOARD" BY JAMES HARDIE. COLOR TO BE SELECTED BY ARCHITECT. SMOOTH FINISH. 6" BATTEN SPACING

### EXTERIOR PAINT COLORS:

BODY / TRIM WHITE PORCH / TRIM / RAILING WHITE SOFFIT FASCIA WHITE GARAGE DOOR **BLACK** 

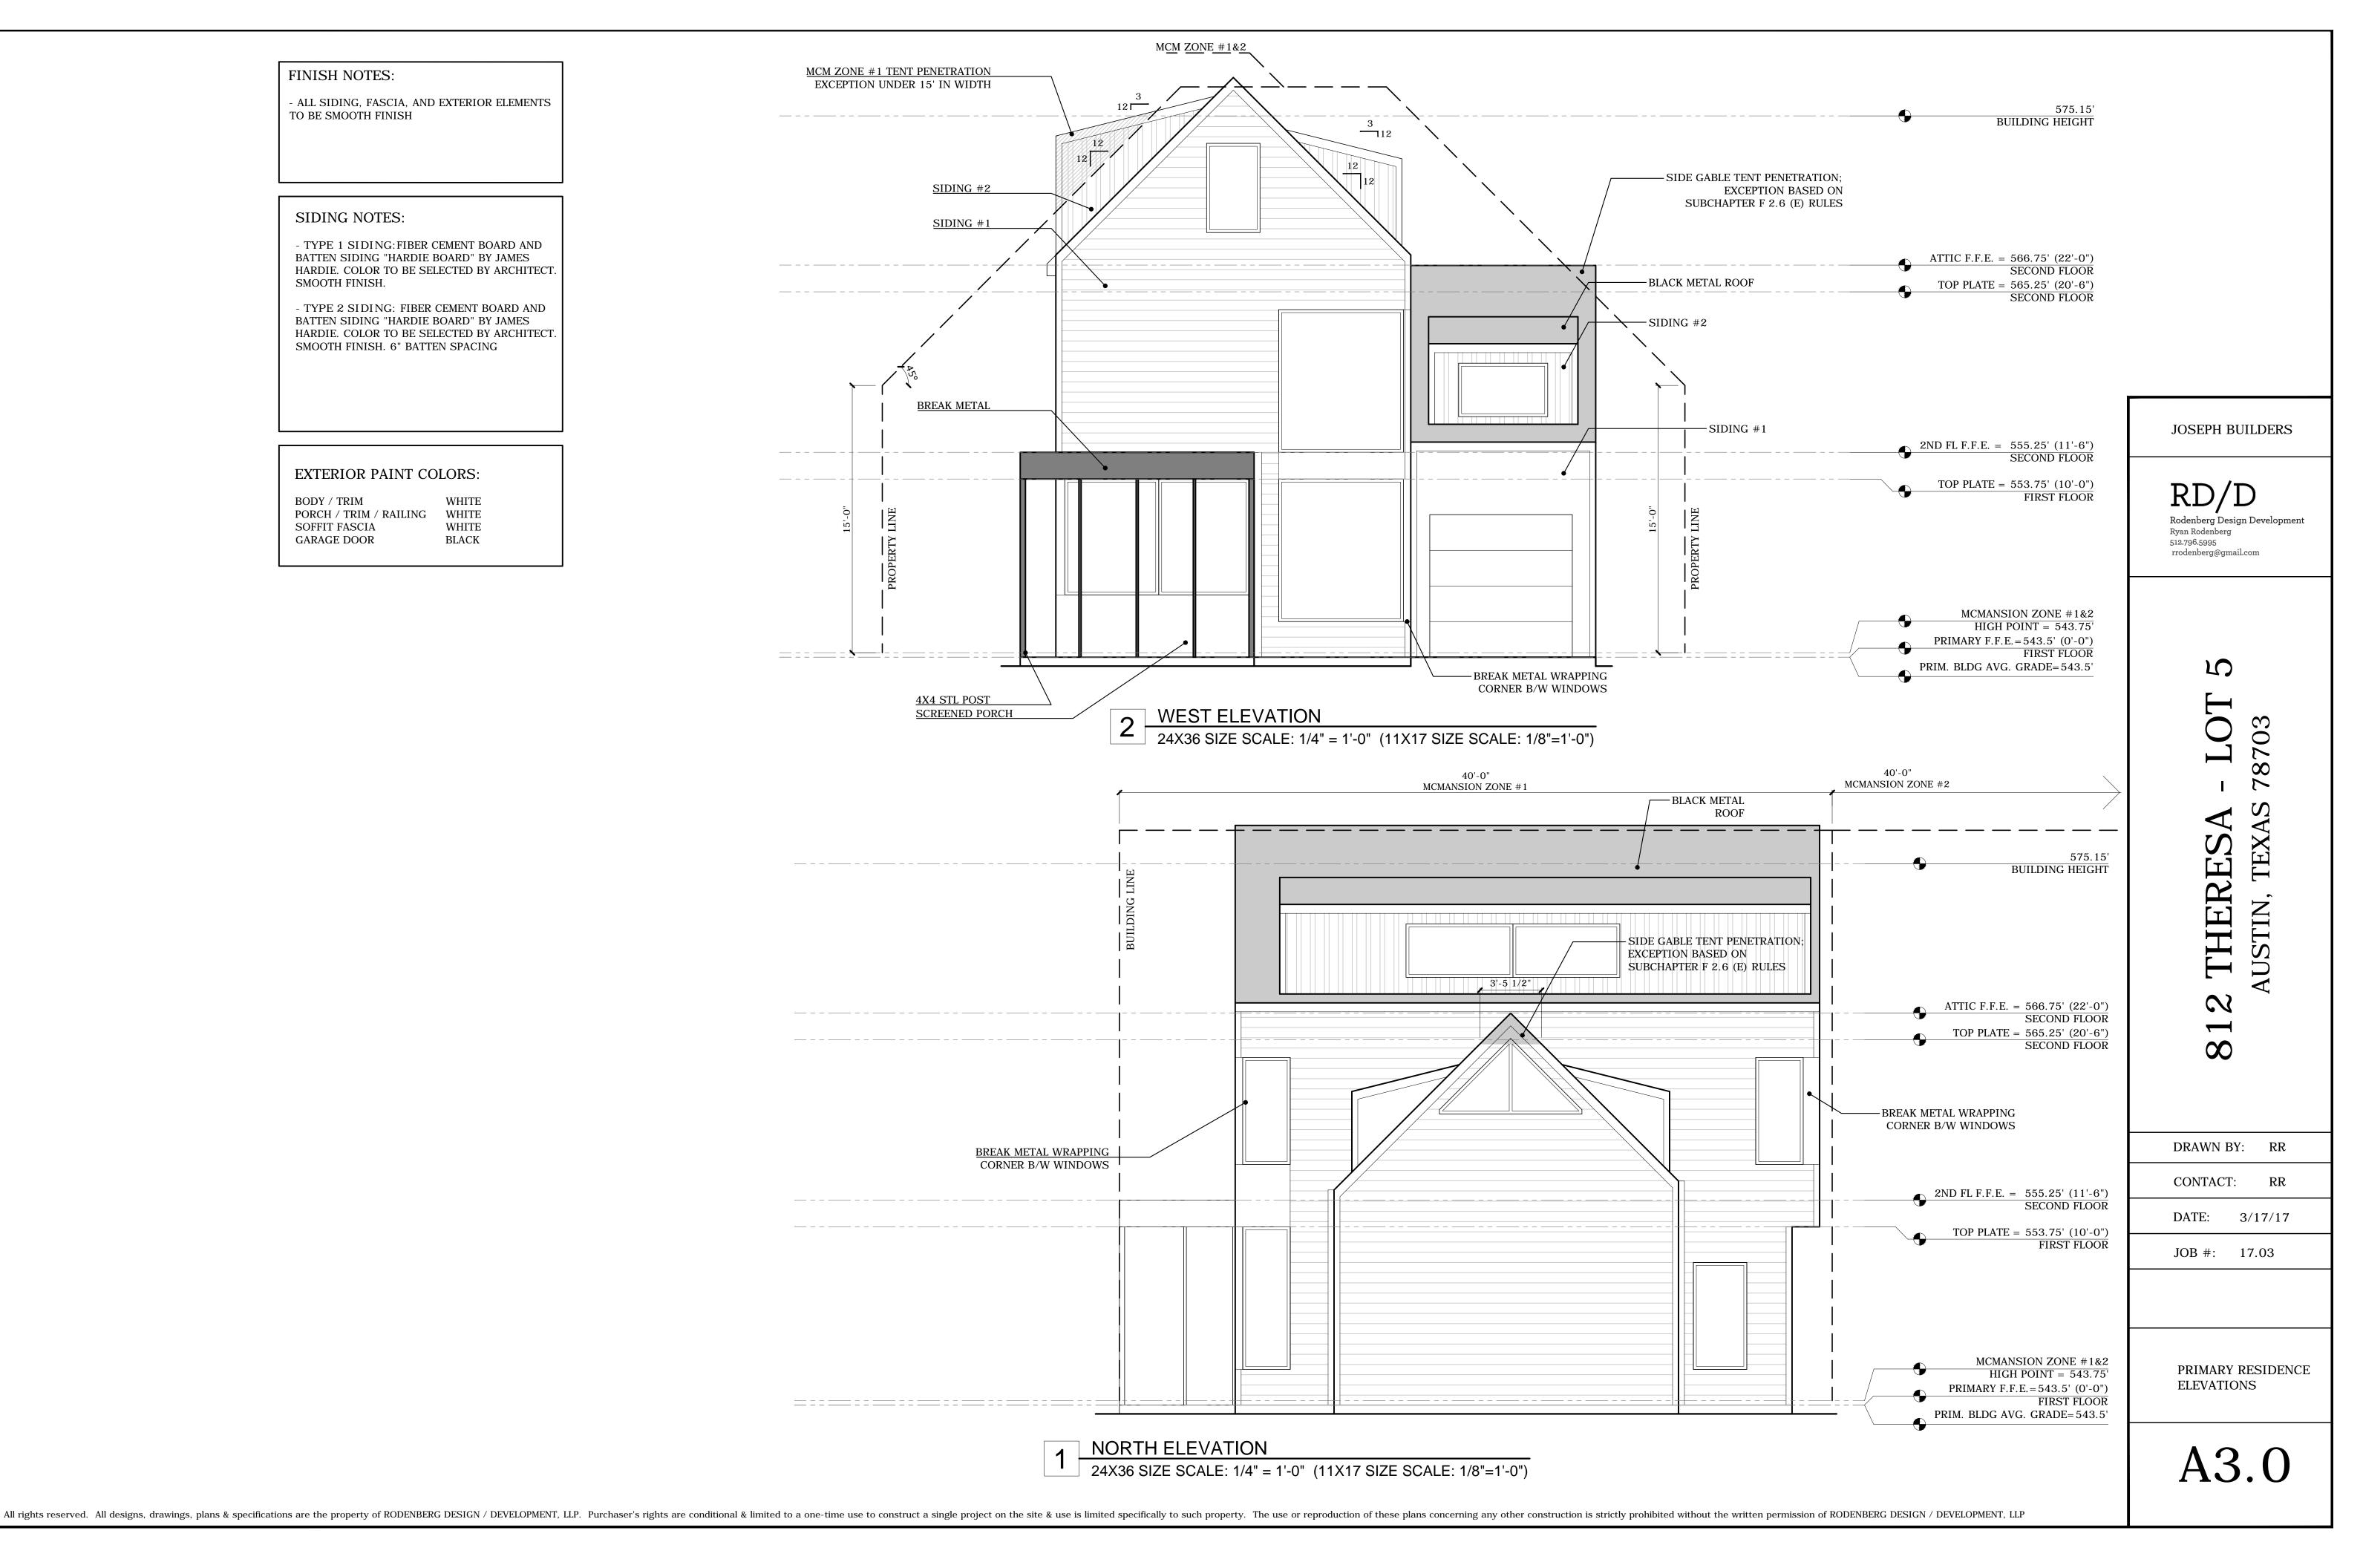

### FINISH NOTES:

- ALL SIDING, FASCIA, AND EXTERIOR ELEMENTS TO BE SMOOTH FINISH


### SIDING NOTES:


- TYPE 1 SIDING: FIBER CEMENT BOARD AND BATTEN SIDING "HARDIE BOARD" BY JAMES HARDIE. COLOR TO BE SELECTED BY ARCHITECT. SMOOTH FINISH.

- TYPE 2 SIDING: FIBER CEMENT BOARD AND BATTEN SIDING "HARDIE BOARD" BY JAMES HARDIE. COLOR TO BE SELECTED BY ARCHITECT. SMOOTH FINISH. 6" BATTEN SPACING

## EXTERIOR PAINT COLORS:

BODY / TRIM WHITE
PORCH / TRIM / RAILING WHITE
SOFFIT FASCIA WHITE
GARAGE DOOR BLACK

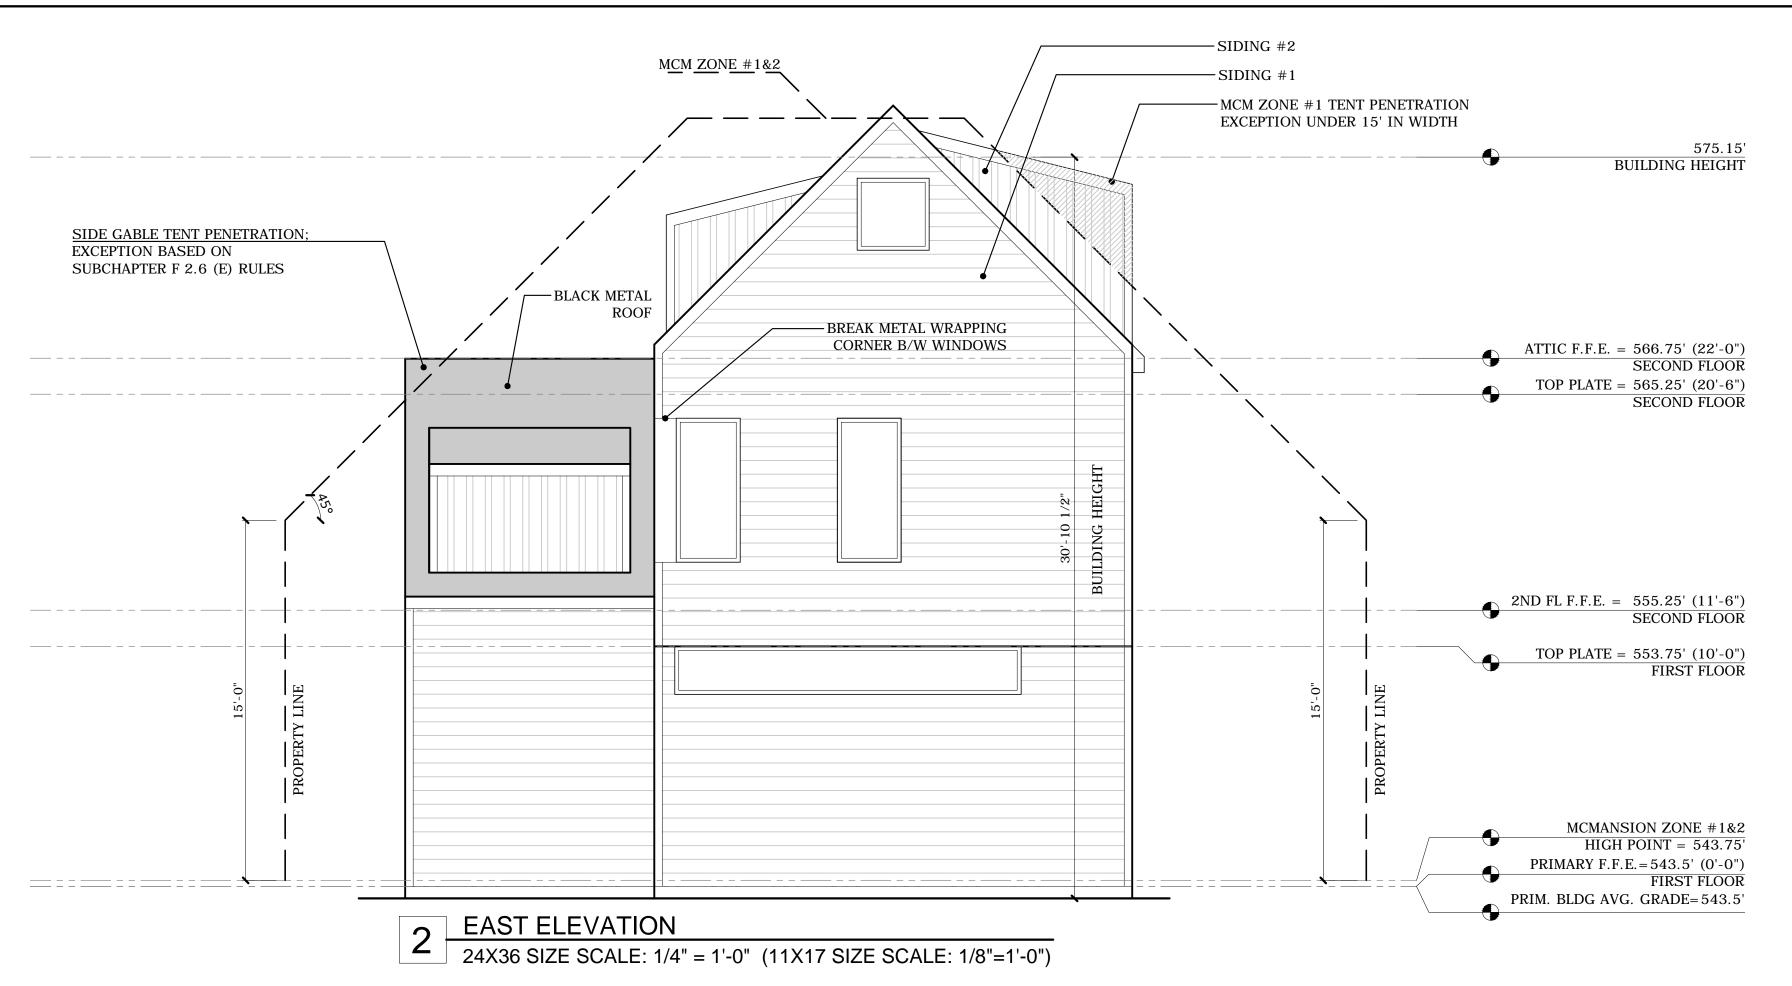

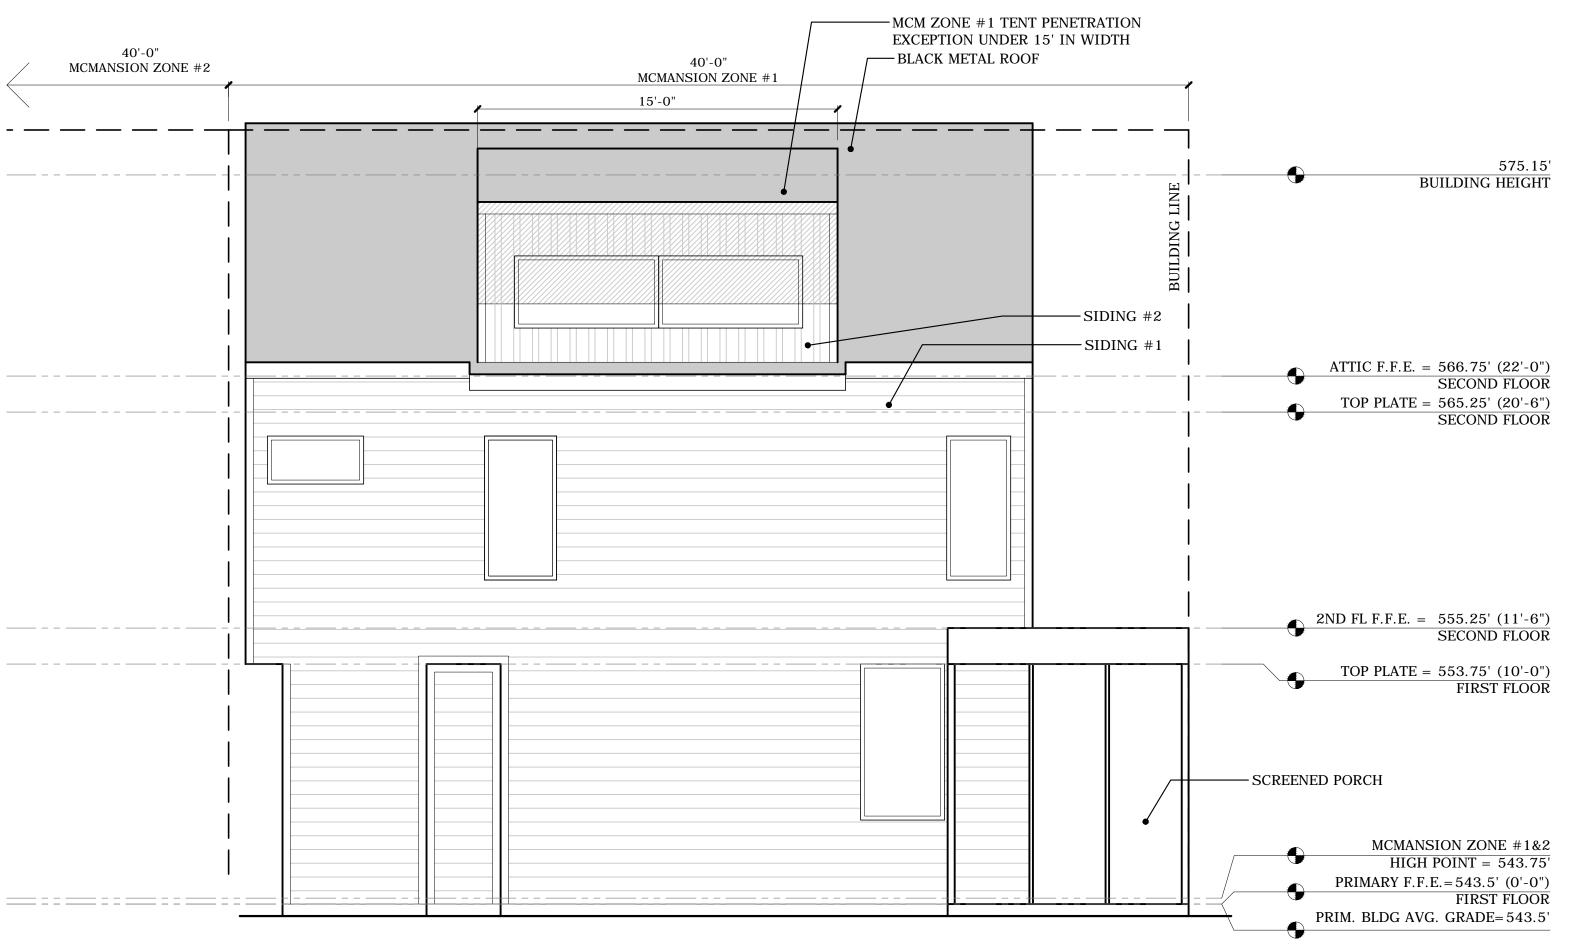

JOSEPH BUILDERS

RD/D
Rodenberg Design Development
Ryan Rodenberg
512.796.5995

rrodenberg@gmail.com

312 THERESA - LOT 5 AUSTIN, TEXAS 78703

DRAWN BY: RR

DATE: 3/17/17

CONTACT: RR

JOB #: 17.03

PRIMARY RESIDENCE

A3.1

**ELEVATIONS** 

1 SOUTH ELEVATION
24X36 SIZE SCALE: 1/4" = 1'-0" (11X17 SIZE SCALE: 1/8"=1'-0")

All rights reserved. All designs, drawings, plans & specifications are the property of RODENBERG DESIGN / DEVELOPMENT, LLP. Purchaser's rights are conditional & limited specifically to such property. The use or reproduction of these plans concerning any other construction is strictly prohibited without the written permission of RODENBERG DESIGN / DEVELOPMENT, LLP.



- ALL SIDING, FASCIA, AND EXTERIOR ELEMENTS TO BE SMOOTH FINISH


### SIDING NOTES:

- TYPE 1 SIDING: FIBER CEMENT BOARD AND BATTEN SIDING "HARDIE BOARD" BY JAMES HARDIE. COLOR TO BE SELECTED BY ARCHITECT SMOOTH FINISH.

- TYPE 2 SIDING: FIBER CEMENT BOARD AND BATTEN SIDING "HARDIE BOARD" BY JAMES HARDIE. COLOR TO BE SELECTED BY ARCHITECT. SMOOTH FINISH. 6" BATTEN SPACING

### **EXTERIOR PAINT COLORS:**


BODY / TRIM WHITE
PORCH / TRIM / RAILING WHITE
SOFFIT FASCIA WHITE
GARAGE DOOR BLACK

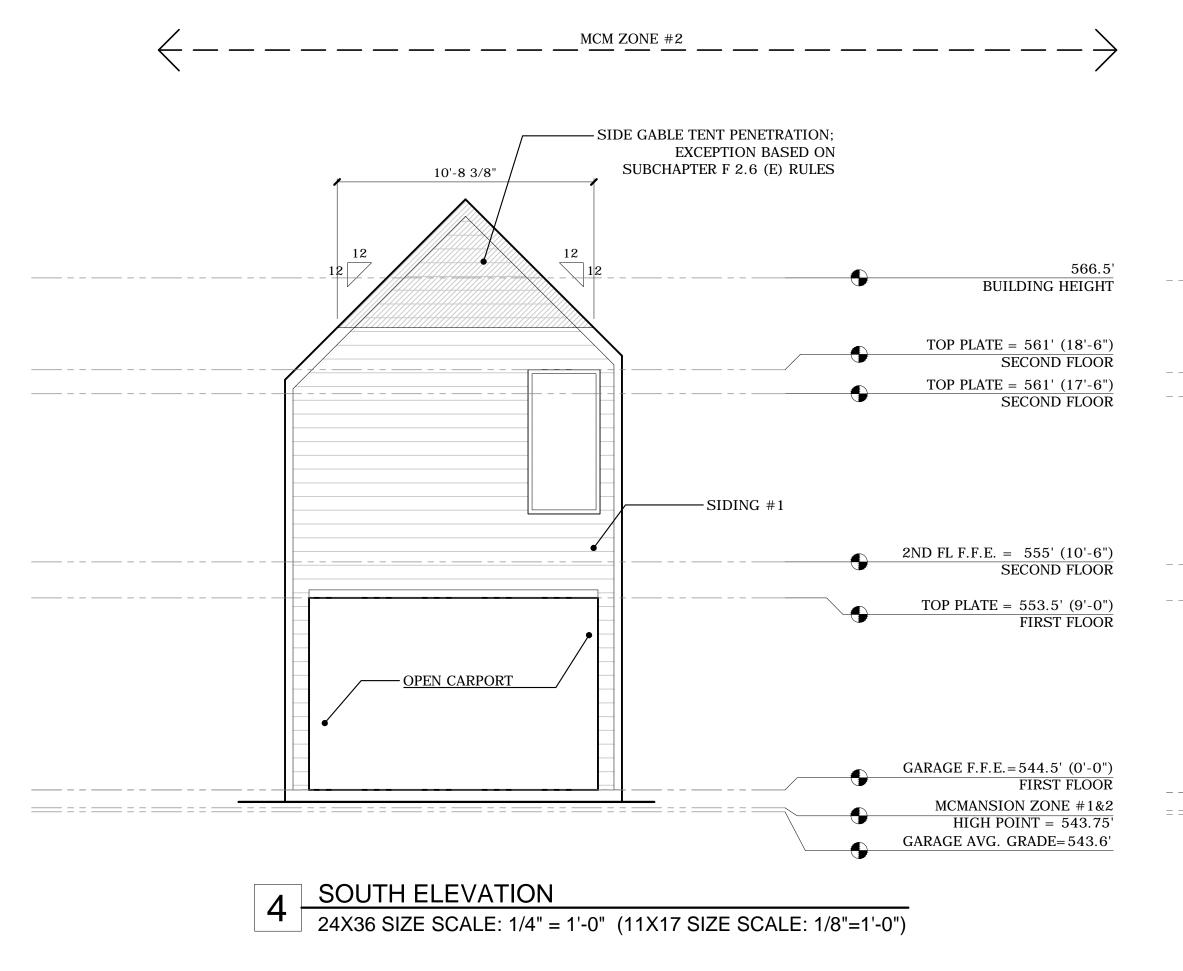


2 EAST ELEVATION
24X36 SIZE SCALE: 1/4" = 1'-0" (11X17 SIZE SCALE: 1/8"=1'-0")

**OPEN CARPORT** 

BLACK SHINGLE ROOFING

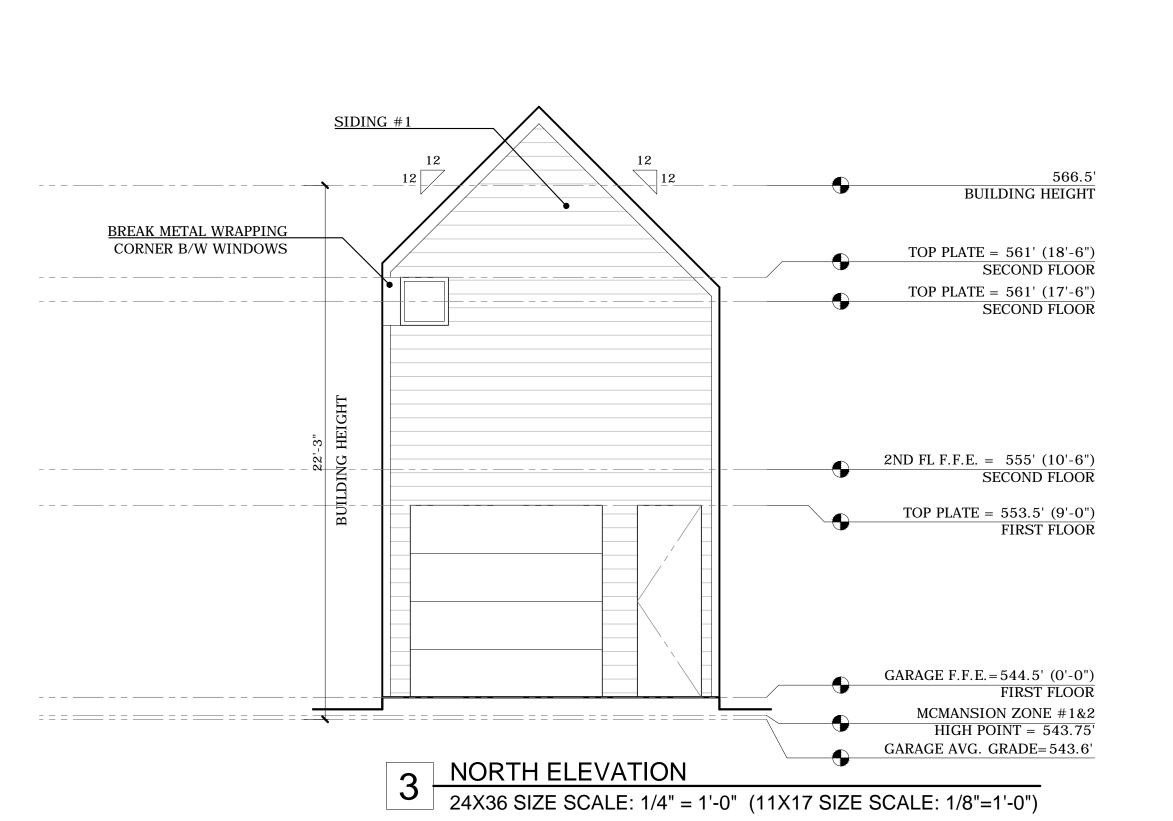

MCM ZONE #2

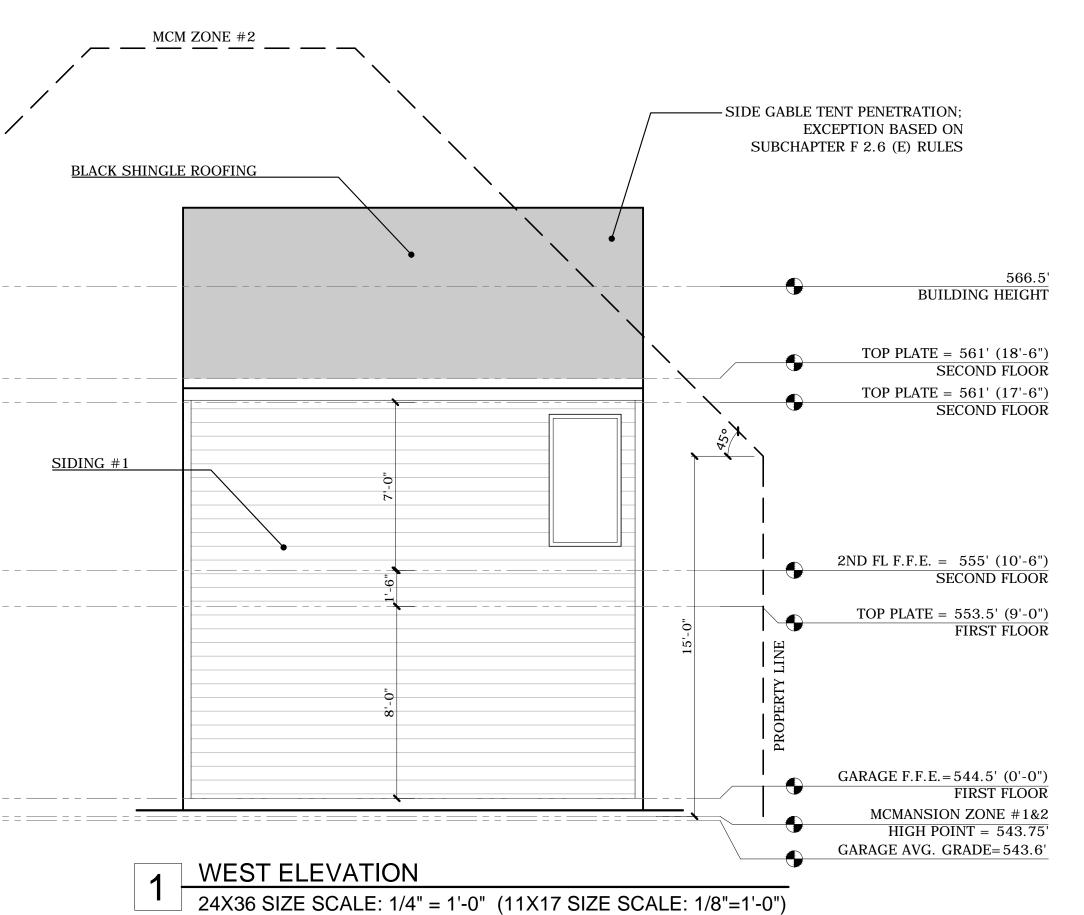

MCM ZONE #2

JOSEPH BUILDERS

BUILDING HEIGHT

SECOND FLOOR

SECOND FLOOR

SECOND FLOOR

FIRST FLOOR

FIRST FLOOR

TOP PLATE = 561' (18'-6")

TOP PLATE = 561' (17'-6")

2ND FL F.F.E. = 555' (10'-6")

TOP PLATE = 553.5' (9'-0")

GARAGE F.F.E. = 544.5' (0'-0")

GARAGE AVG. GRADE=543.6'

MCMANSION ZONE #1&2

HIGH POINT = 543.75'

-BREAK METAL WRAPPING CORNER B/W WINDOWS

—SIDING #1

RD/D
Rodenberg Design Developme

Rodenberg Design Developme Ryan Rodenberg 512.796.5995 rrodenberg@gmail.com

312 THERESA - LOT 5

DRAWN BY: RR

DATE: 3/17/17

CONTACT: RR

JOB #: 17.03

GARAGE ELEVATIONS

A3.2

All rights reserved. All designs, drawings, plans & specifications are the property of RODENBERG DESIGN / DEVELOPMENT, LLP. Purchaser's rights are conditional & limited to a one-time use to construct a single project on the site & use is limited specifically to such property. The use or reproduction of these plans concerning any other construction is strictly prohibited without the written permission of RODENBERG DESIGN / DEVELOPMENT, LLP.



