

JOSEPH BUILDERS

RD/D

Rodenberg Design Development Ryan Rodenberg 512.796.5995 rrodenberg@gmail.com

rodenberg@gmail.com

812 THERESA - LOT 5 AUSTIN, TEXAS 78703

DRAWN BY: RR

RR

CONTACT:

DATE: 3/17/17


JOB #: 17.03


SURVEY

A0.2

1

FULL SIZE SCALE: 1" = 15'
HALF SIZE SCALE: 1" = 30'

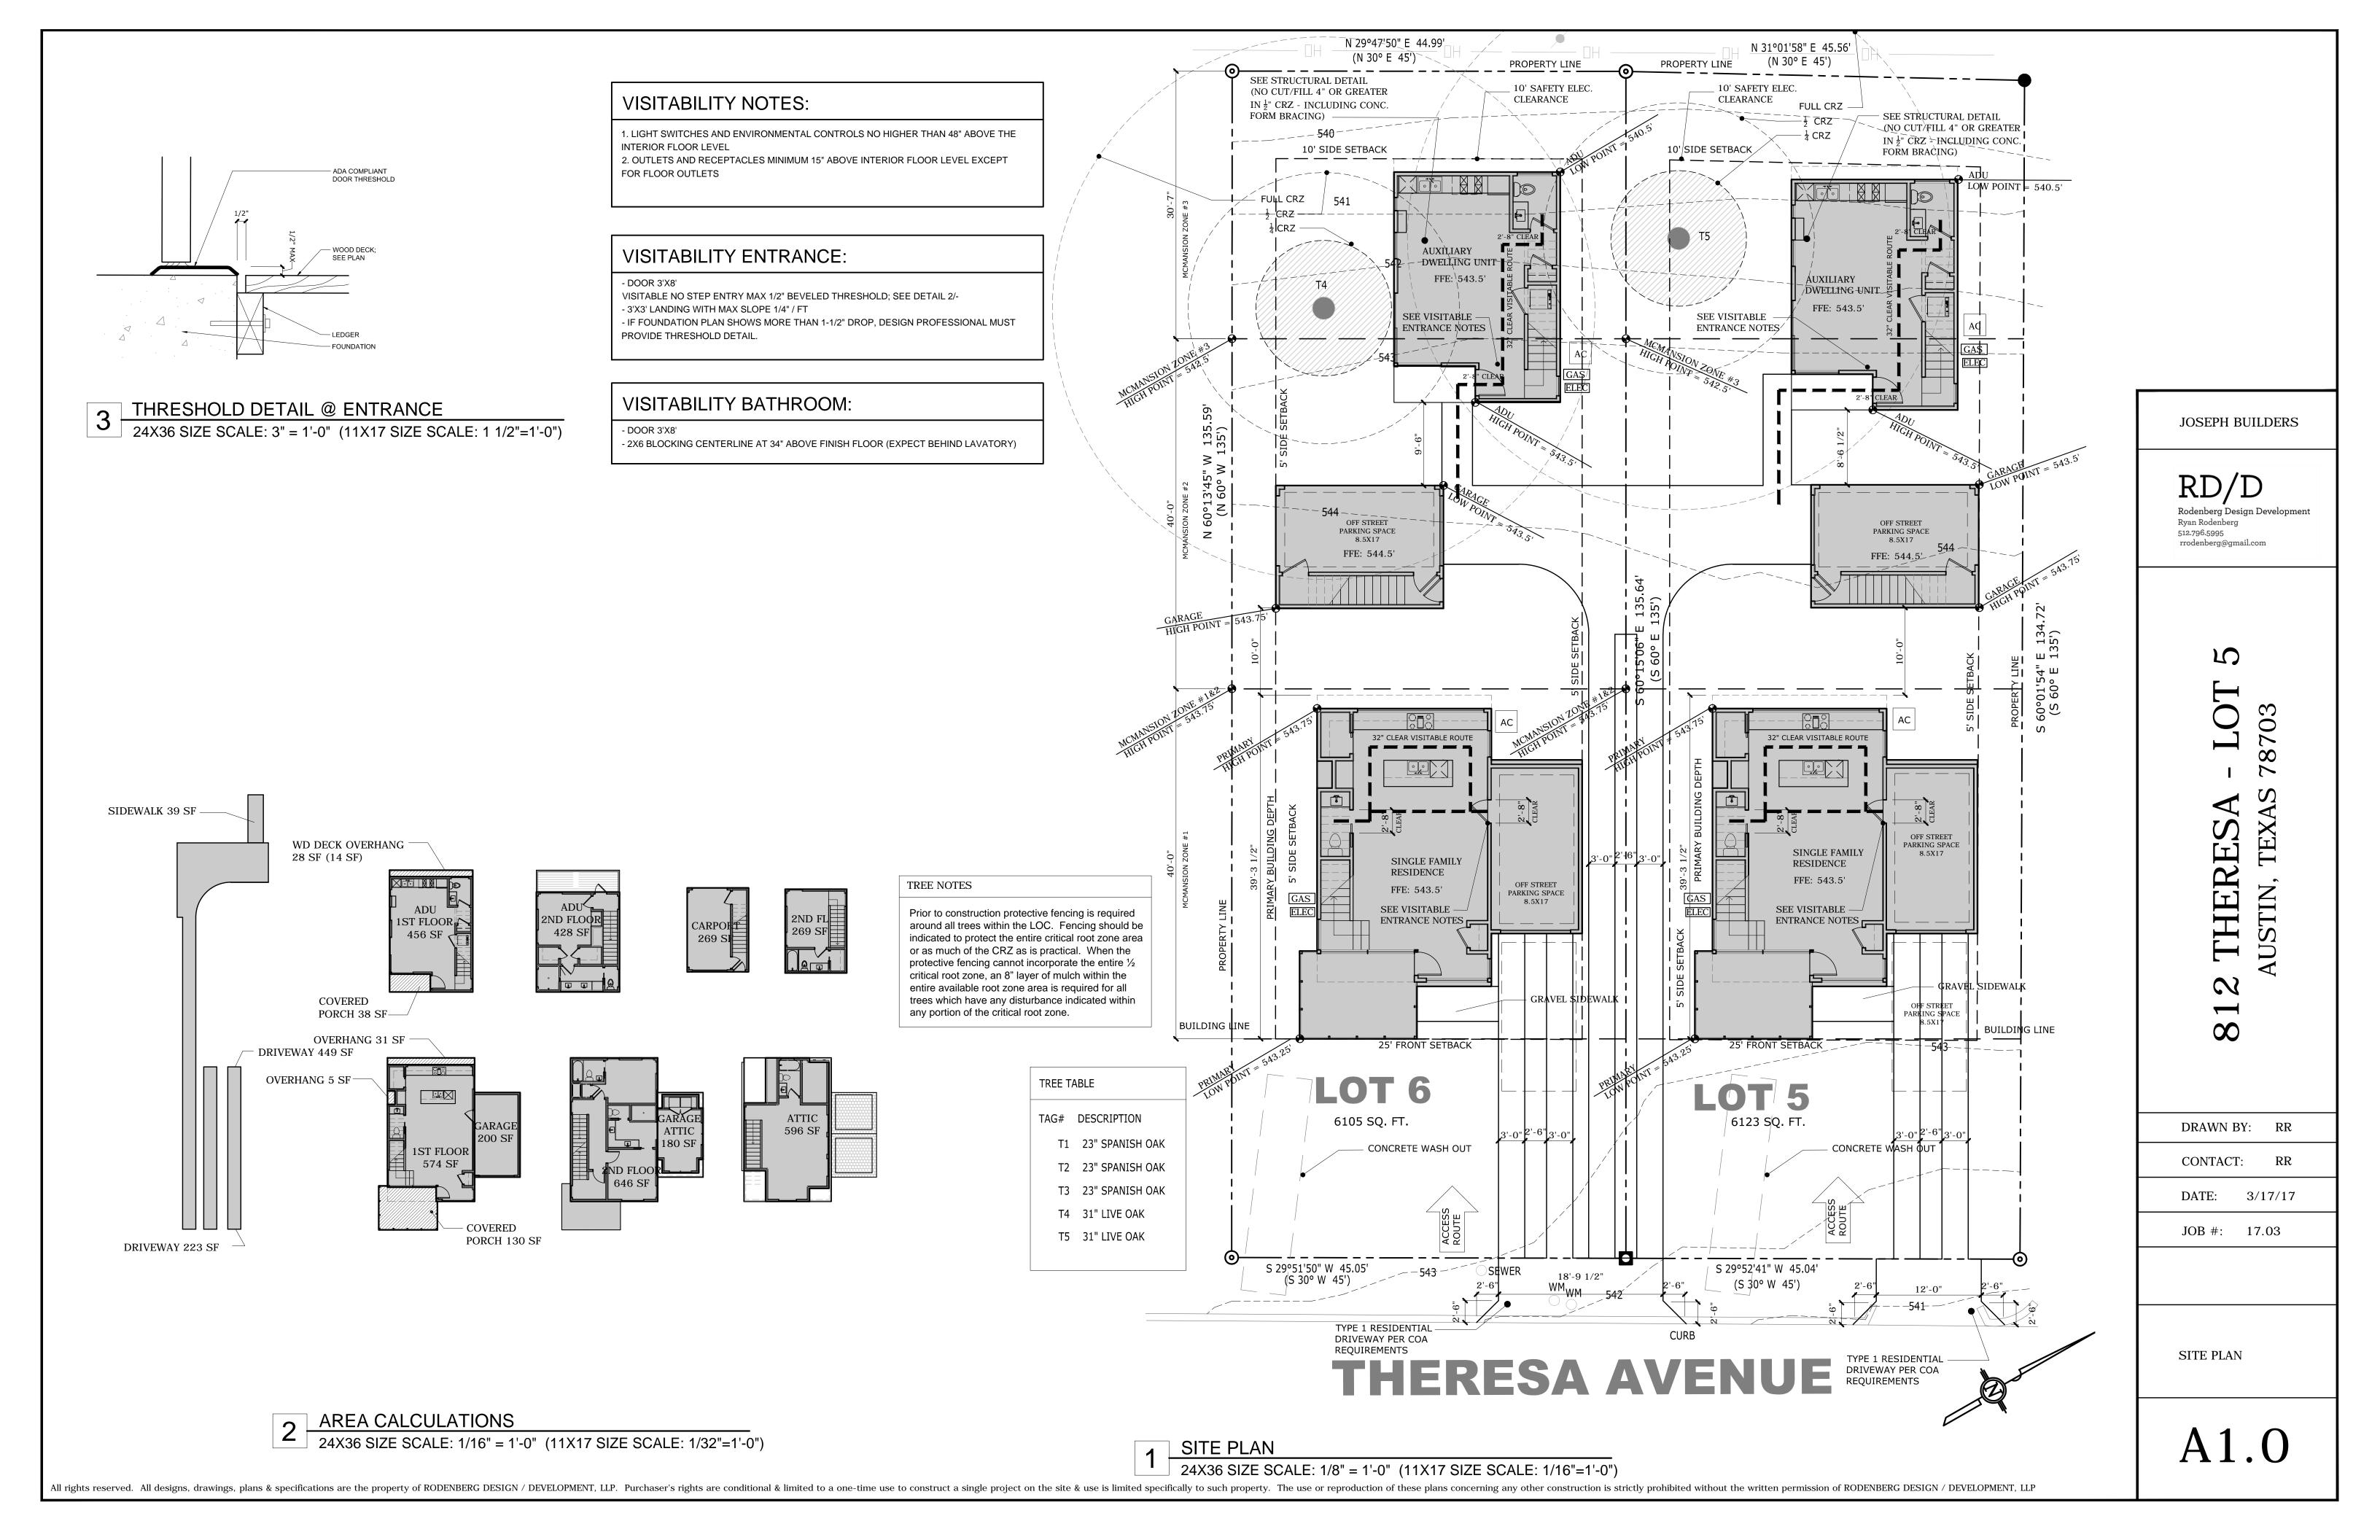

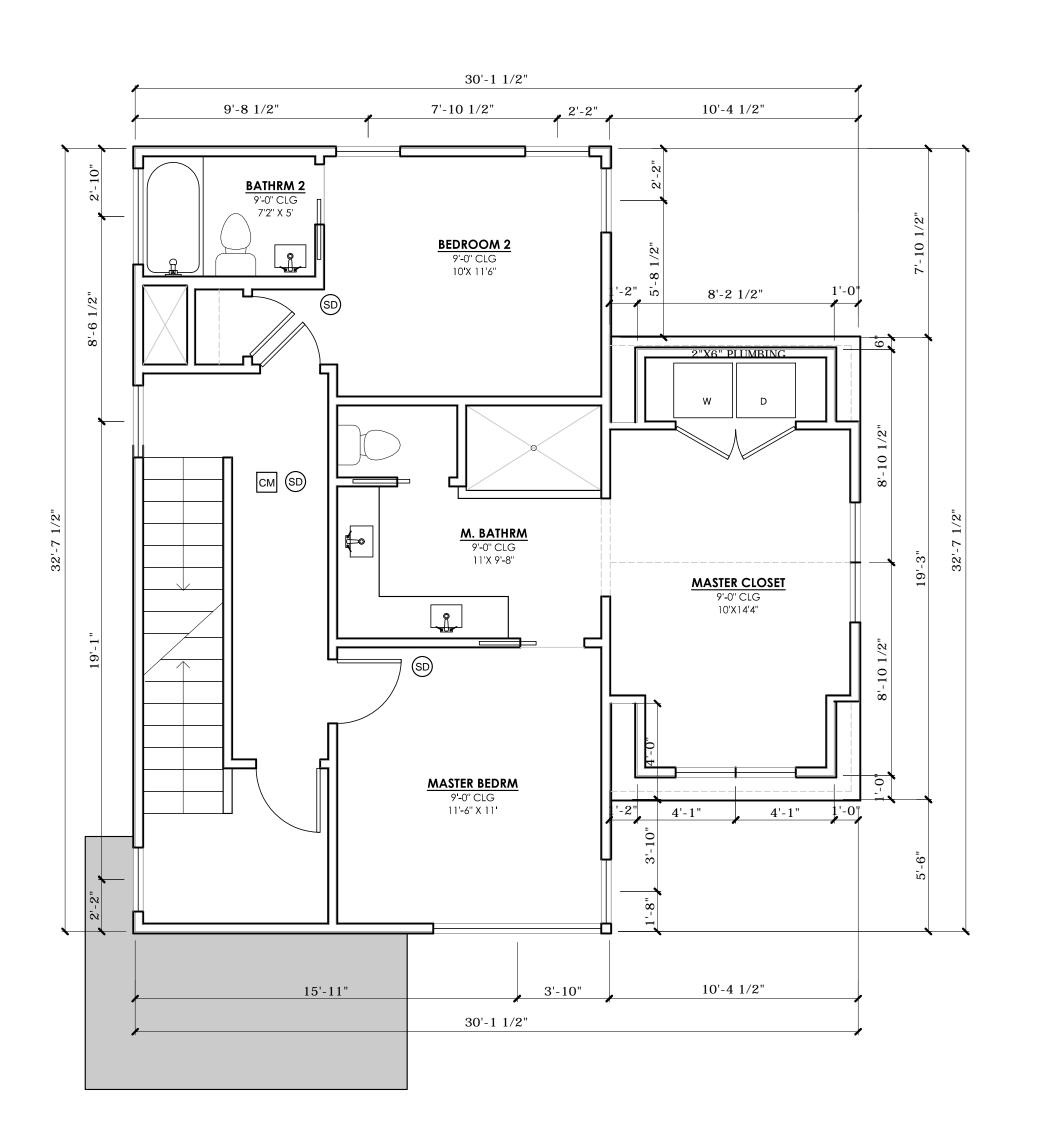

PRIMARY - SECOND FLOOR PLAN

24X36 SIZE SCALE: 1/4" = 1'-0" (11X17 SIZE SCALE: 1/8"=1'-0")

GENERAL NOTES:

- FLOORING:

FIRST FLOOR: SEALED CONCRETE

SECOND FLOOR: $\frac{5}{8}$ " T & G WOOD THROUGHOUT. BATHROOMS, LAUNDRY; TILE: x; PORCELAIN TILE ON HARDIBACKER OVER $\frac{3}{4}$ " T&G

PLYWOOD DECK.

ALL WALLS; 2X4; PLUMBING WALLS; 2X6. INSULATE EXTERIOR WALLS R-19 MIN. FORM INSULATE ROOF, R-38 MIN.

- ALL DOOR HAVE A 96" HEIGHT

NOTES:



SD SMOKE DETECTOR INSTALLED IN ACCORDANCE WITH IRC 2012 R314

CARBON MONOXIDE DETECTOR INSTALLED IN ACCORDANCE WITH IRC 2012 R315

PLAN NOTES:


1. ALL EGRESS WINDOWS AND DOORS TO COMPLY WITH 2012 IRC R310.1, R311.2, R312.2.

2. STAIRS, HANDRAILS, AND GUARDRAILS TO COMPLY WITH 2012 IRC R311.5.1, R311.7, R312.1.

3. FIRST FLOOR OF NEW CONSTRUCTION WITH ANY LIVING SPACE TO COMPLY WITH ALL VISITABILITY STANDARDS UNDER CITY CODE SEC. 25-12-243, R320. VISITABILITY ITEMS ARE REFERENCED ON FLOOR PLANS.

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PRIMARY - FIRST FLOOR PLAN

24X36 SIZE SCALE: 1/4" = 1'-0" (11X17 SIZE SCALE: 1/8"=1'-0")
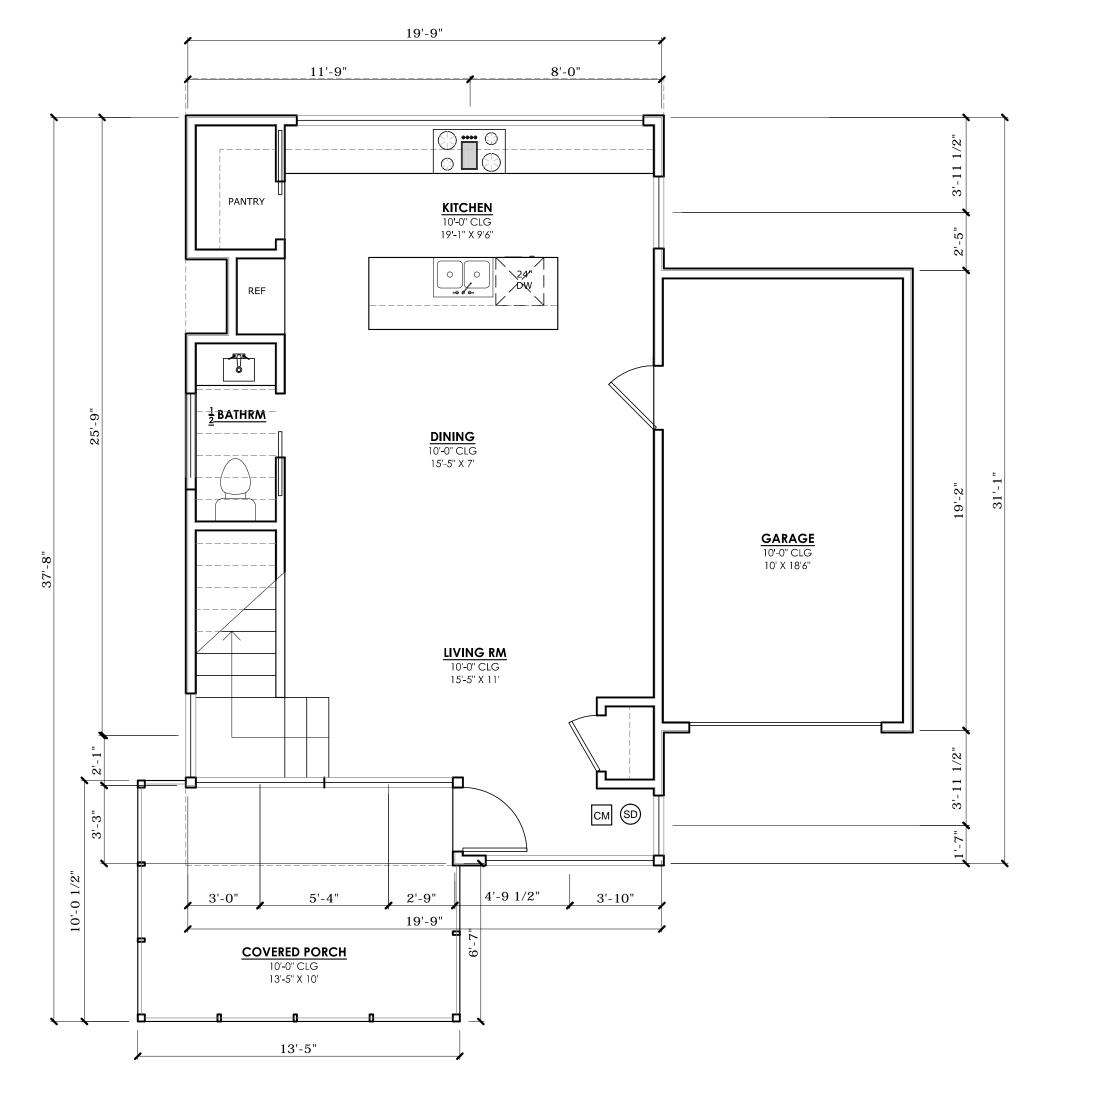
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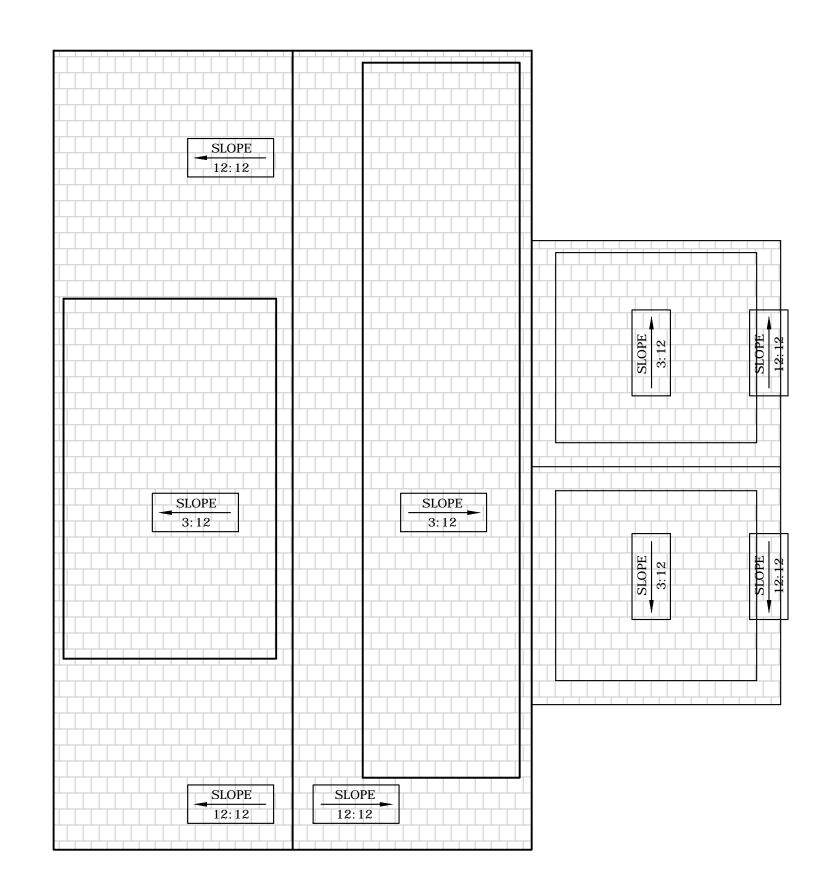
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PRIMARY -FLOOR PLANS

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GENERAL NOTES:

- 1. DIMENSIONS INDICATED ARE HORIZONTAL PLAN DIMENSIONS.
- 2. REFER TO REFLECTED CEILING PLAN FOR EXTENT OF SOFFITS.
- 3. ROOF VENT LOCATIONS ARE NOT SHOWN. COORDINATE WITH OTHER TRADES FOR EXACT LOCATION OF ALL ROOF PENETRATIONS CENTERED IN METAL ROOF PANEL SYMMETRICAL WITH STANDING SEAMS AT 12" O.C., AND COORDINATE WITH RAFTERS AT 16" O.C.
- 4. ROOF ASSEMBLY: METAL ROOF SYSTEM, MBCI "BATTENLOK HS" OR APPROVED EQUAL, MINIMUM 24 GAUGE PERFORMED, GALVALUME, LARGE BATTEN, VERTICAL LEG, CONCEALED FASTENER, STANDING SEAM METAL ROOF SYSTEM, CONTINUOUSLY LOCKED, MECHANICALLY SEAMED ROOF PANEL
- 5. BREATHABLE, HIGH TEMP METAL ROOF UNDERLAYMENT PER MANUFACTURER'S RECOMMENDATIONS TITANIUM UDL 50 OR SIMILAR. PROVIDE 1" UNDER-DECK VENTILATION / AIR SPACE WHEN USING POLYURETHANE FOAM INSULATION.
- 6. ALL ROOF PENETRATIONS, CURBS, FLUES, VENTS, VENT CAPS, HOODS, FAN HOUSINGS, ETC. SHALL BE FINISHED OR PAINTED TO MATCH ROOF
- 7. PROVIDE FLEXIBLE PIPE FLASHINGS UNITS AT ALL PLUMBING, COOKTOP/RANGE, AND DRYER VENT PENETRATIONS THROUGH THE METAL
- 8. ALL HARDWARE IN CONTACT WITH PRESERVATIVE PRESSURE TREATED (PPT) LUMBER SHALL BE STAINLESS STEEL, DOUBLE HOT DIPPED GALVANIZED, OR TRIPLE ZINC (ZMAX), INCLUDING STRUCTURAL METAL ANCHORS, ANGLES OR TIES, BOLTS, NAILS, LAG SCREWS AND SCREWS.



PRIMARY - ROOF PLAN

24X36 SIZE SCALE: 1/4" = 1'-0" (11X17 SIZE SCALE: 1/8"=1'-0")

GENERAL NOTES:

- FLOORING:

FIRST FLOOR: SEALED CONCRETE

SECOND FLOOR: 5" T & G WOOD THROUGHOUT.

BATHROOMS, LAUNDRY; TILE: x; PORCELAIN TILE ON HARDIBACKER OVER 3" T&G

PLYWOOD DECK.

ALL WALLS; 2X4; PLUMBING WALLS; 2X6. INSULATE EXTERIOR WALLS R-19 MIN. FORM INSULATE ROOF, R-38 MIN.

- ALL DOOR HAVE A 96" HEIGHT

NOTES:




SMOKE DETECTOR INSTALLED IN ACCORDANCE WITH IRC 2012 R314



CARBON MONOXIDE DETECTOR INSTALLED IN ACCORDANCE WITH IRC 2012 R315

PLAN NOTES:

- 1. ALL EGRESS WINDOWS AND DOORS TO COMPLY WITH 2012 IRC R310.1, R311.2, R312.2.
- 2. STAIRS, HANDRAILS, AND GUARDRAILS TO COMPLY WITH 2012 IRC R311.5.1, R311.7, R312.1.
- 3. FIRST FLOOR OF NEW CONSTRUCTION WITH ANY LIVING SPACE TO COMPLY WITH ALL VISITABILITY STANDARDS UNDER CITY CODE SEC. 25-12-243, R320. VISITABILITY ITEMS ARE REFERENCED ON FLOOR PLANS.

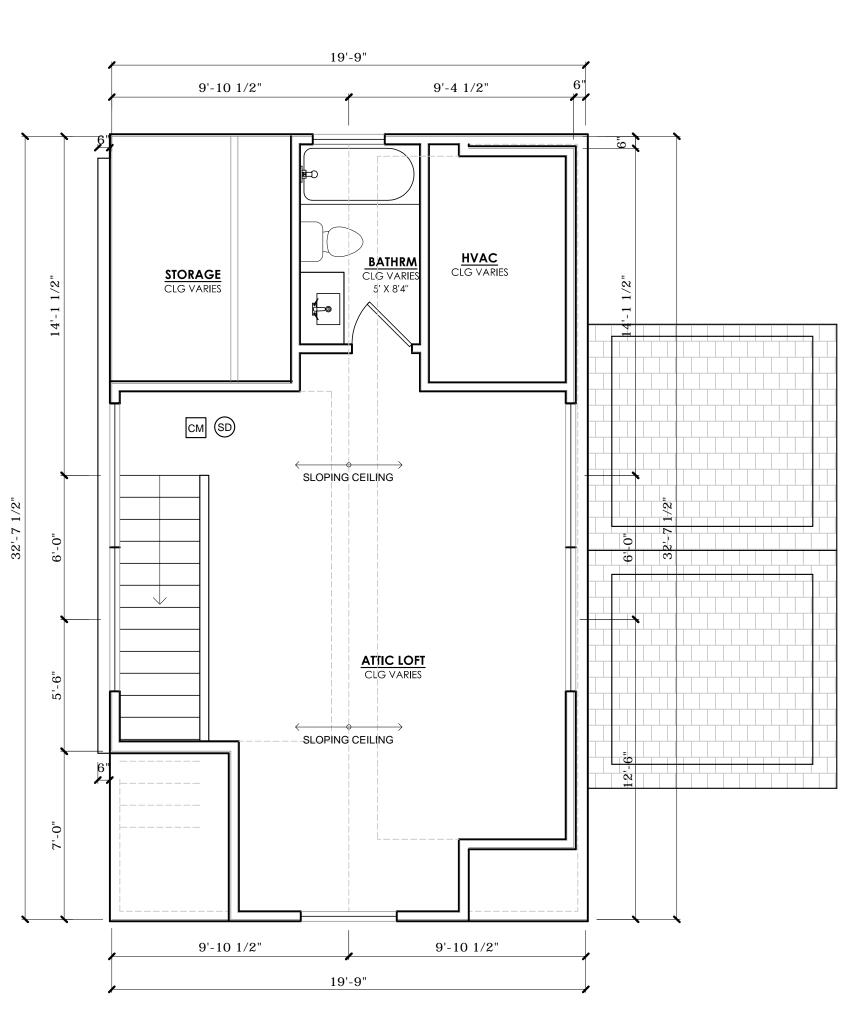

PRIMARY - ATTIC FLOOR PLAN 24X36 SIZE SCALE: 1/4" = 1'-0" (11X17 SIZE SCALE: 1/8"=1'-0") JOSEPH BUILDERS

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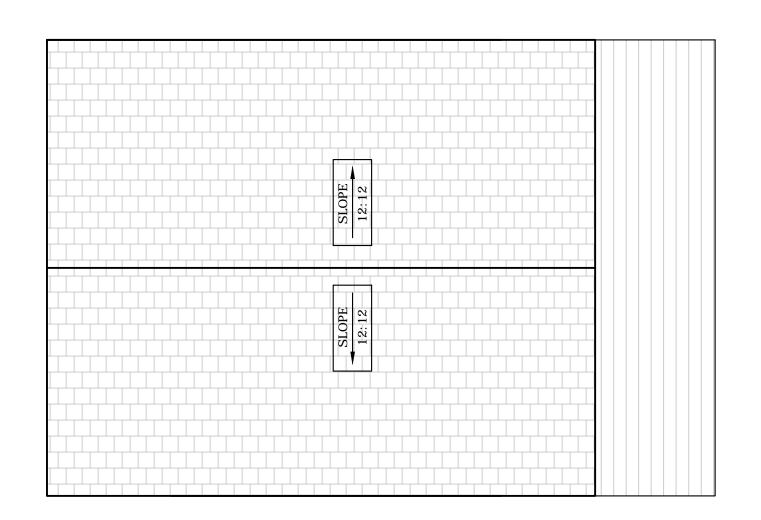
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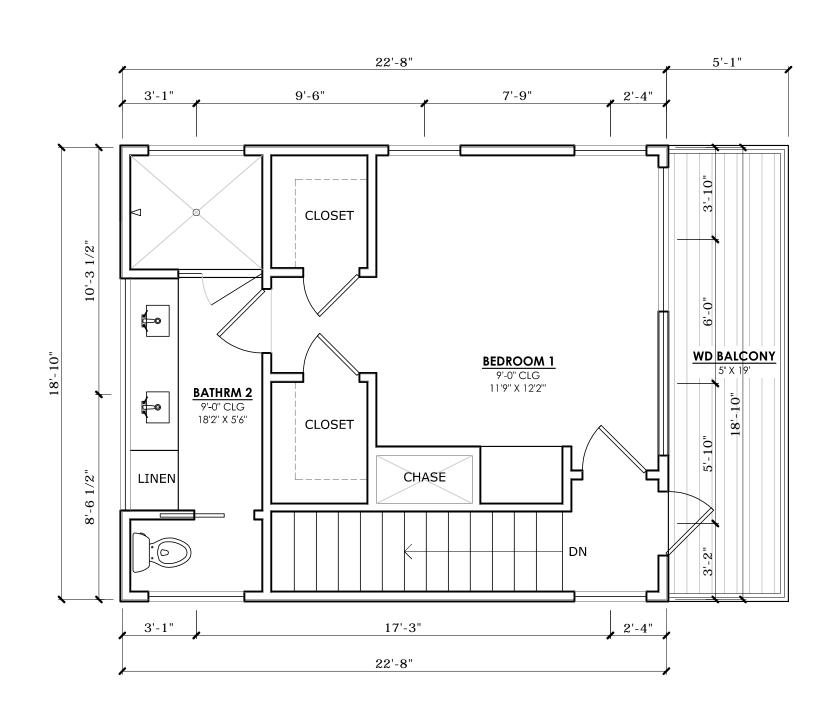
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PRIMARY -FLOOR PLANS

GENERAL NOTES:	PLAN NOTES:	NOTES:
- ALL WALLS; 2X4; LAUNDRY WALLS; 2X6. INSULATE EXTERIOR WALLS R-19 MIN FORM INSULATE ROOF, R-38 MIN.	 ALL EGRESS WINDOWS AND DOORS TO COMPLY WITH 2012 IRC R310.1, R311.2, R312.2. STAIRS, HANDRAILS, AND GUARDRAILS TO COMPLY WITH 2012 IRC R311.5.1, R311.7, R312.1. 	SD SMOKE DETECTOR INSTALLED IN ACCORDANCE WITH IRC 2012 R314
	3. FIRST FLOOR OF NEW CONSTRUCTION WITH ANY LIVING SPACE TO COMPLY WITH ALL VISITABILITY STANDARDS UNDER CITY CODE SEC. 25-12-243, R320. VISITABILITY ITEMS ARE REFERENCED ON FLOOR PLANS.	CARBON MONOXIDE DETECTOR INSTALLED IN ACCORDANCE WITH IRC 2012 R315




6 ADU - ROOF PLAN
24X36 SIZE SCALE: 1/4" = 1'-0" (11X17 SIZE SCALE: 1/8"=1'-0")




ADU - SECOND FLOOR


24X36 SIZE SCALE: 1/4" = 1'-0" (11X17 SIZE SCALE: 1/8"=1'-0")

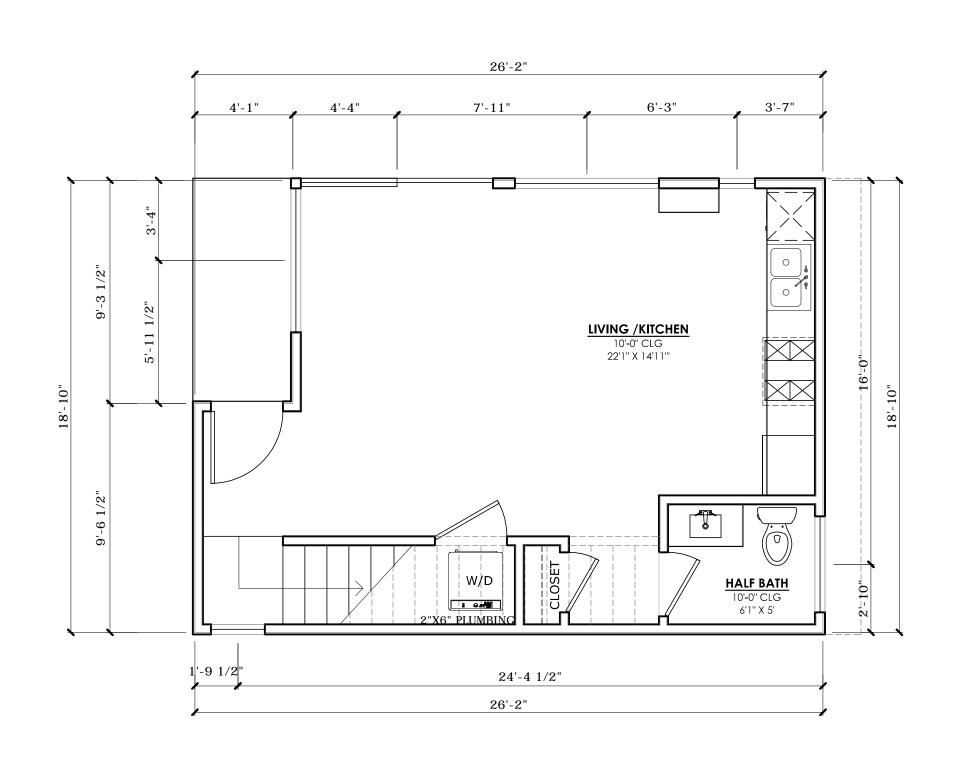


2 ADU - FIRST FLOOR PLAN
24X36 SIZE SCALE: 1/4" = 1'-0" (11X17 SIZE SCALE: 1/8"=1'-0")

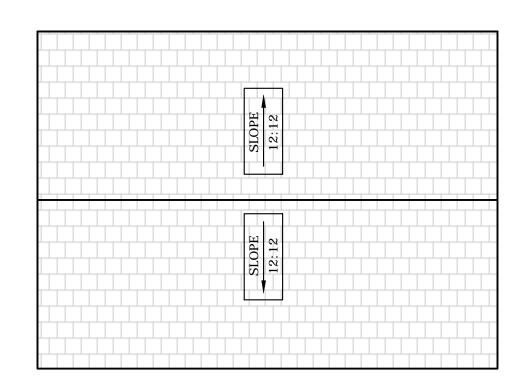

5 CARPORT - ROOF PLAN
24X36 SIZE SCALE: 1/4" = 1'-0" (11X17 SIZE SCALE: 1/8"=1'-0")

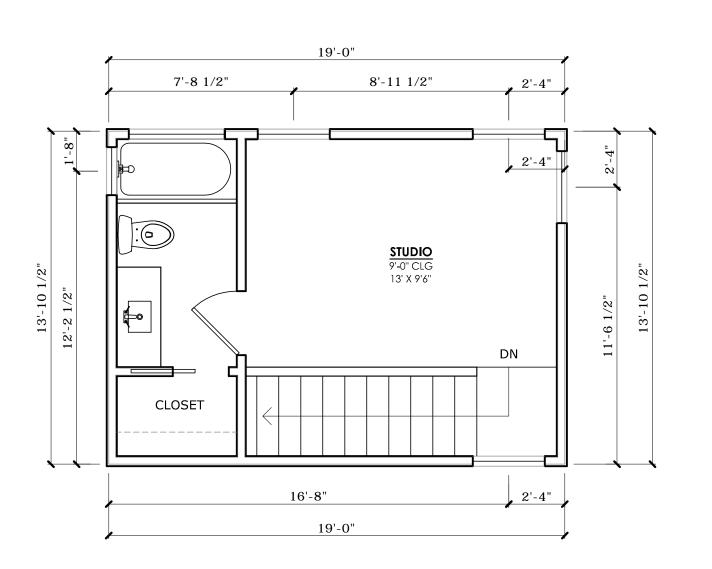

3 CARPORT - SECOND FLOOR
24X36 SIZE SCALE: 1/4" = 1'-0" (11X17 SIZE SCALE: 1/8"=1'-0")

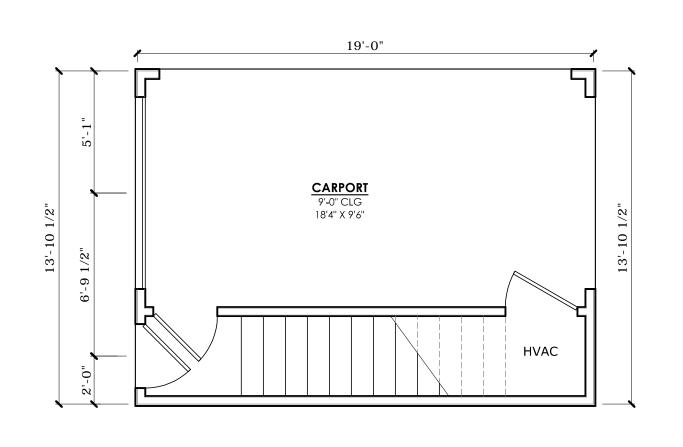

1 CARPORT - FIRST FLOOR PLAN
24X36 SIZE SCALE: 1/4" = 1'-0" (11X17 SIZE SCALE: 1/8"=1'-0")

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ADU -FLOOR PLANS

A2.2

FINISH NOTES:

- ALL SIDING, FASCIA, AND EXTERIOR ELEMENTS TO BE SMOOTH FINISH


SIDING NOTES:

- TYPE 1 SIDING: FIBER CEMENT BOARD AND BATTEN SIDING "HARDIE BOARD" BY JAMES HARDIE. COLOR TO BE SELECTED BY ARCHITECT. SMOOTH FINISH.

- TYPE 2 SIDING: FIBER CEMENT BOARD AND BATTEN SIDING "HARDIE BOARD" BY JAMES HARDIE. COLOR TO BE SELECTED BY ARCHITECT. SMOOTH FINISH. 6" BATTEN SPACING

EXTERIOR PAINT COLORS:

BODY / TRIM WHITE PORCH / TRIM / RAILING WHITE SOFFIT FASCIA WHITE GARAGE DOOR **BLACK**

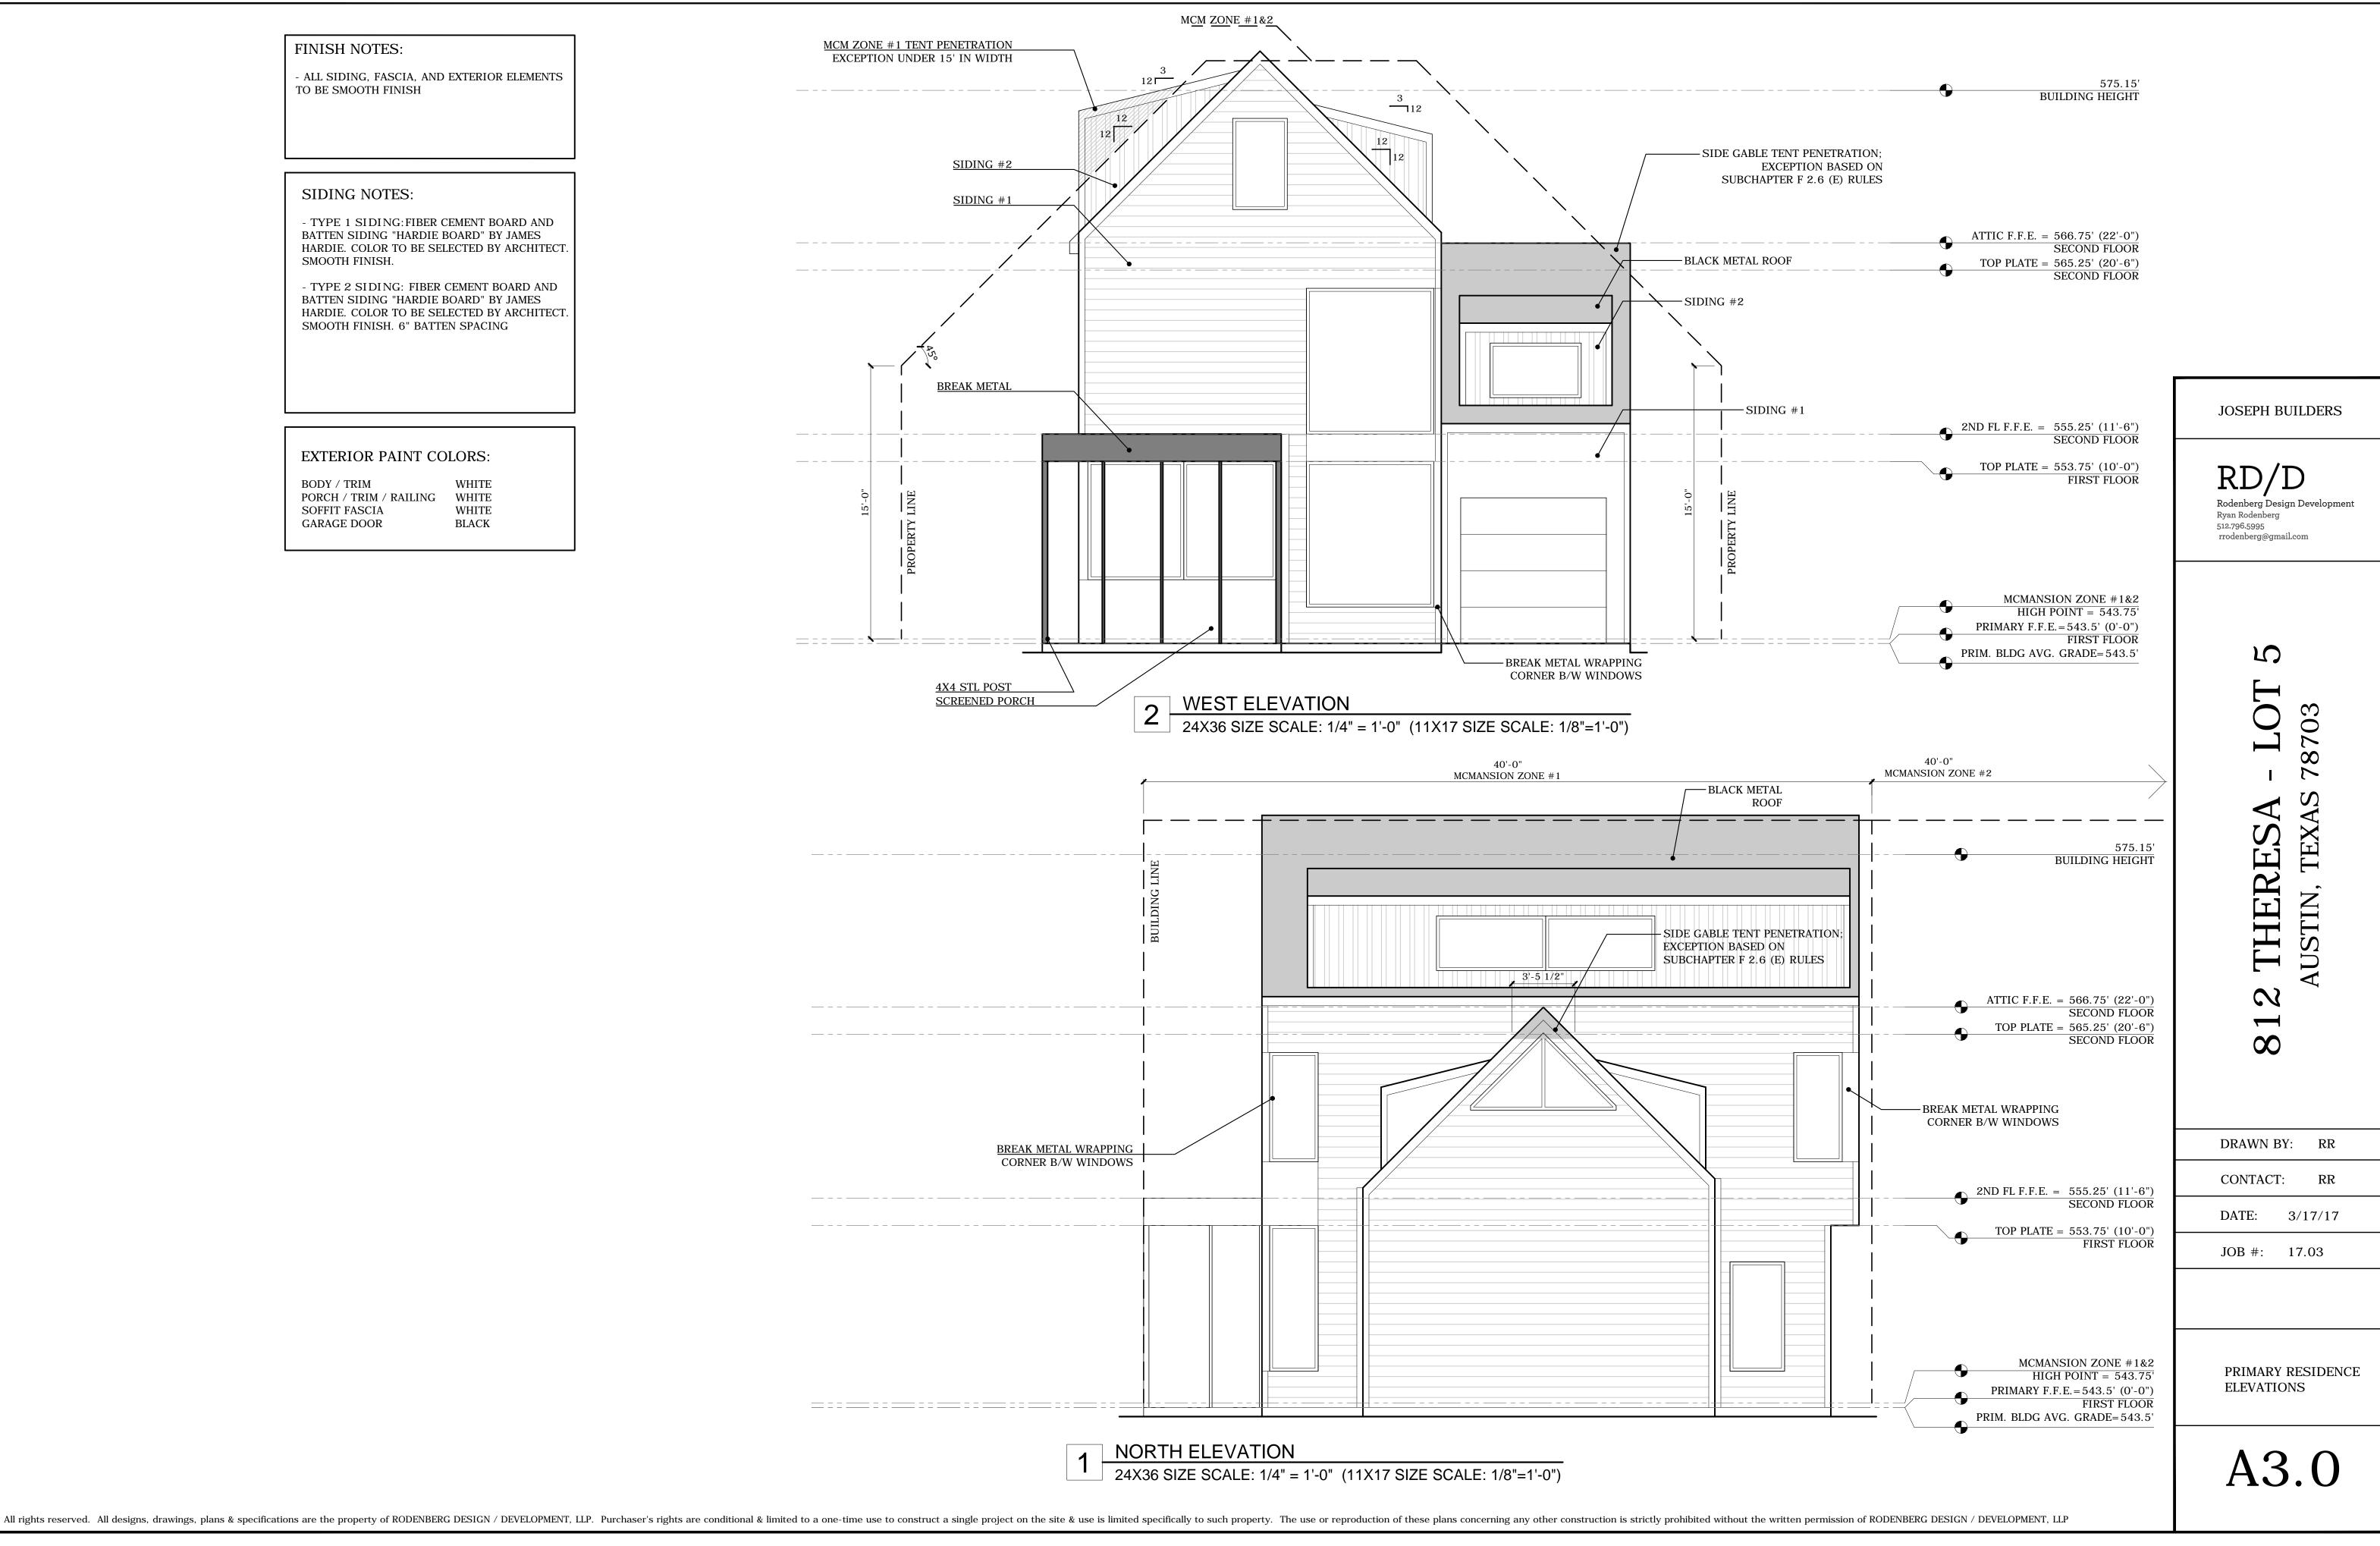

FINISH NOTES:

- ALL SIDING, FASCIA, AND EXTERIOR ELEMENTS TO BE SMOOTH FINISH


SIDING NOTES:


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- TYPE 2 SIDING: FIBER CEMENT BOARD AND BATTEN SIDING "HARDIE BOARD" BY JAMES HARDIE. COLOR TO BE SELECTED BY ARCHITECT. SMOOTH FINISH. 6" BATTEN SPACING

EXTERIOR PAINT COLORS:

BODY / TRIM WHITE
PORCH / TRIM / RAILING WHITE
SOFFIT FASCIA WHITE
GARAGE DOOR BLACK



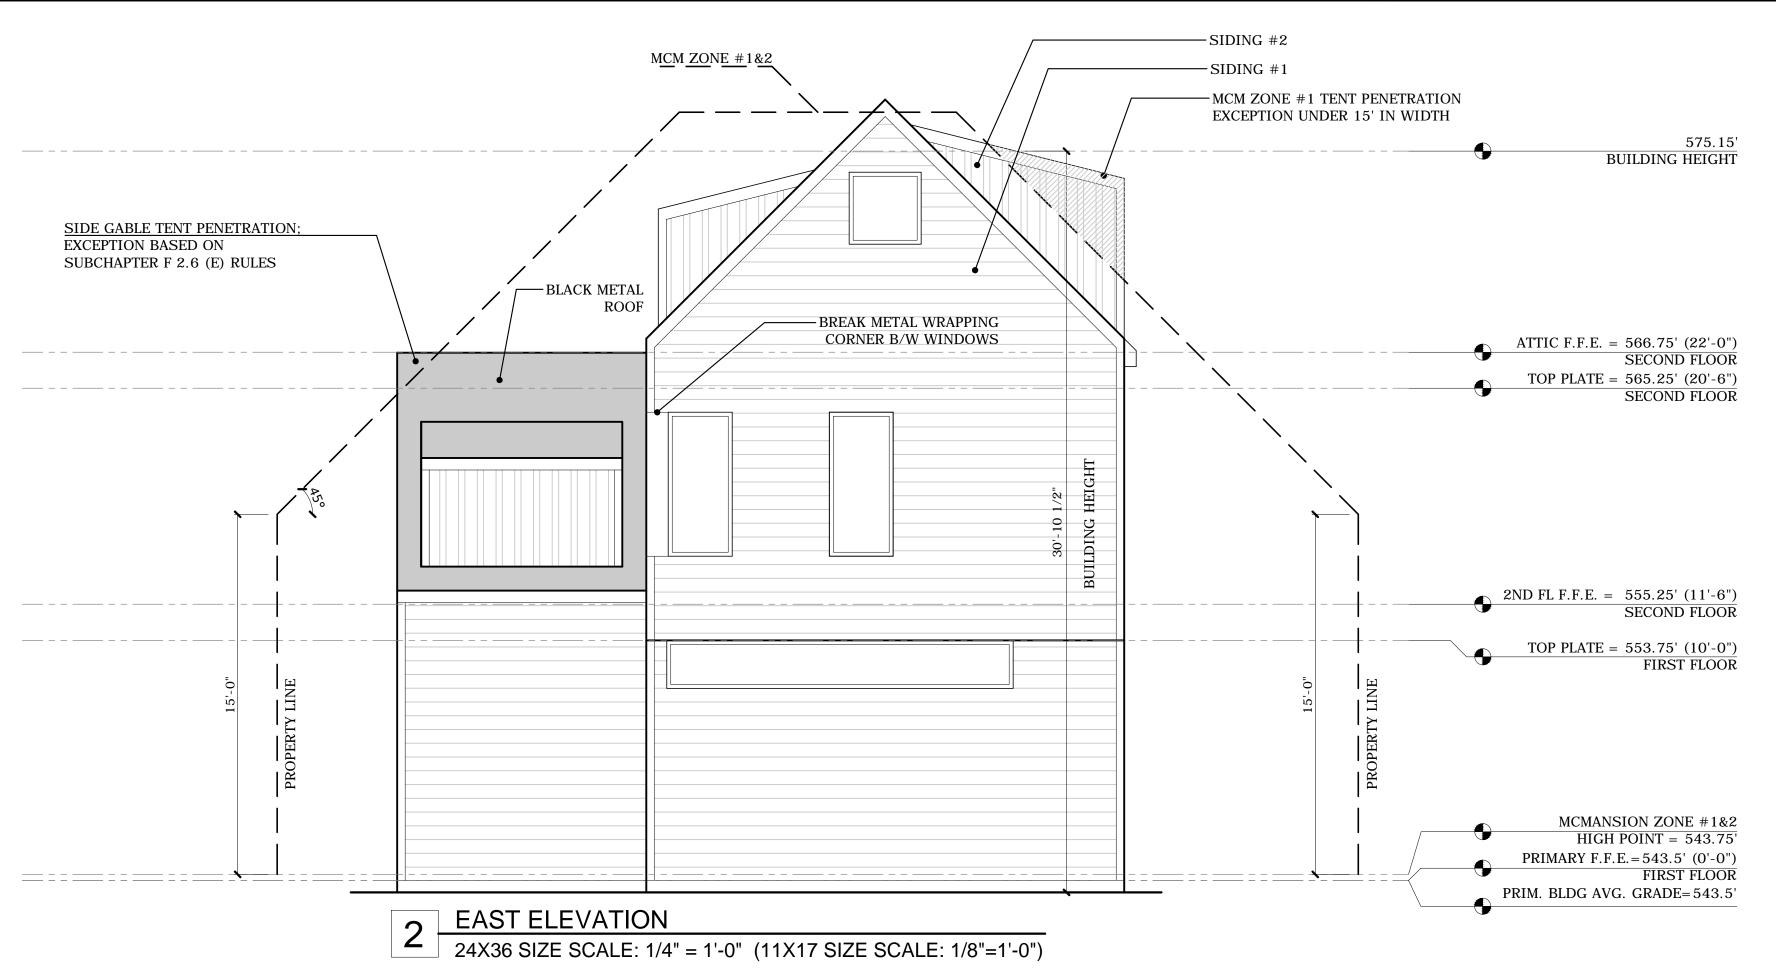

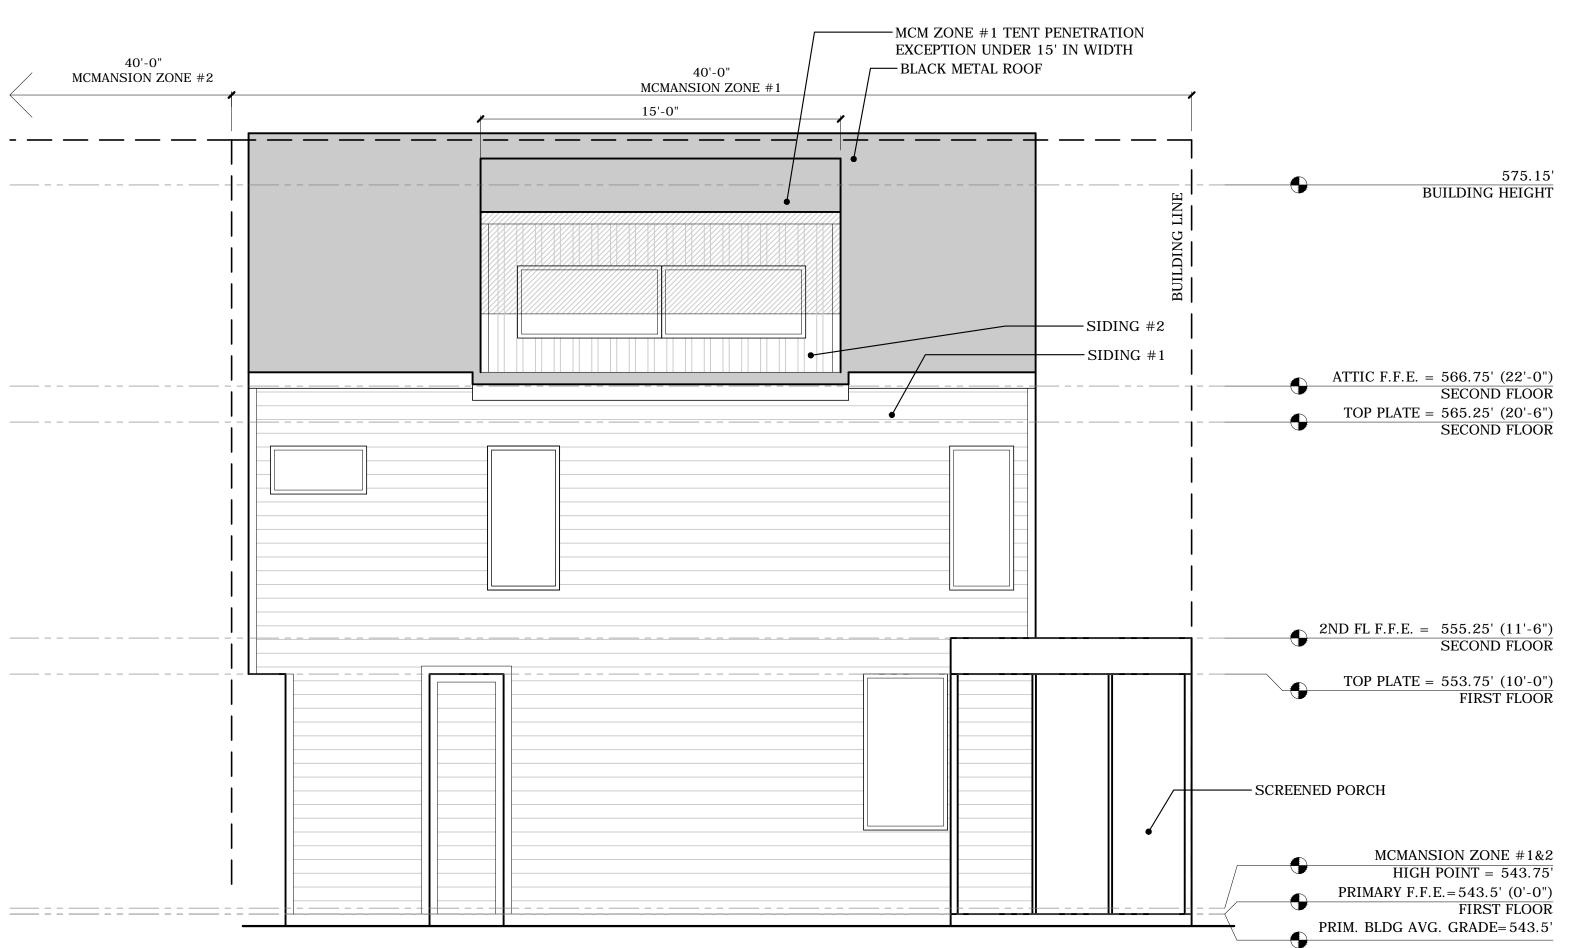1 SOUTH ELEVATION
24X36 SIZE SCALE: 1/4" = 1'-0" (11X17 SIZE SCALE: 1/8"=1'-0")

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PRIMARY RESIDENCE ELEVATIONS

A3.1



- ALL SIDING, FASCIA, AND EXTERIOR ELEMENTS TO BE SMOOTH FINISH


SIDING NOTES:

- TYPE 1 SIDING: FIBER CEMENT BOARD AND BATTEN SIDING "HARDIE BOARD" BY JAMES HARDIE. COLOR TO BE SELECTED BY ARCHITECT SMOOTH FINISH.


- TYPE 2 SIDING: FIBER CEMENT BOARD AND BATTEN SIDING "HARDIE BOARD" BY JAMES HARDIE. COLOR TO BE SELECTED BY ARCHITECT. SMOOTH FINISH. 6" BATTEN SPACING

EXTERIOR PAINT COLORS:

BODY / TRIM WHITE PORCH / TRIM / RAILING WHITE WHITE SOFFIT FASCIA GARAGE DOOR BLACK

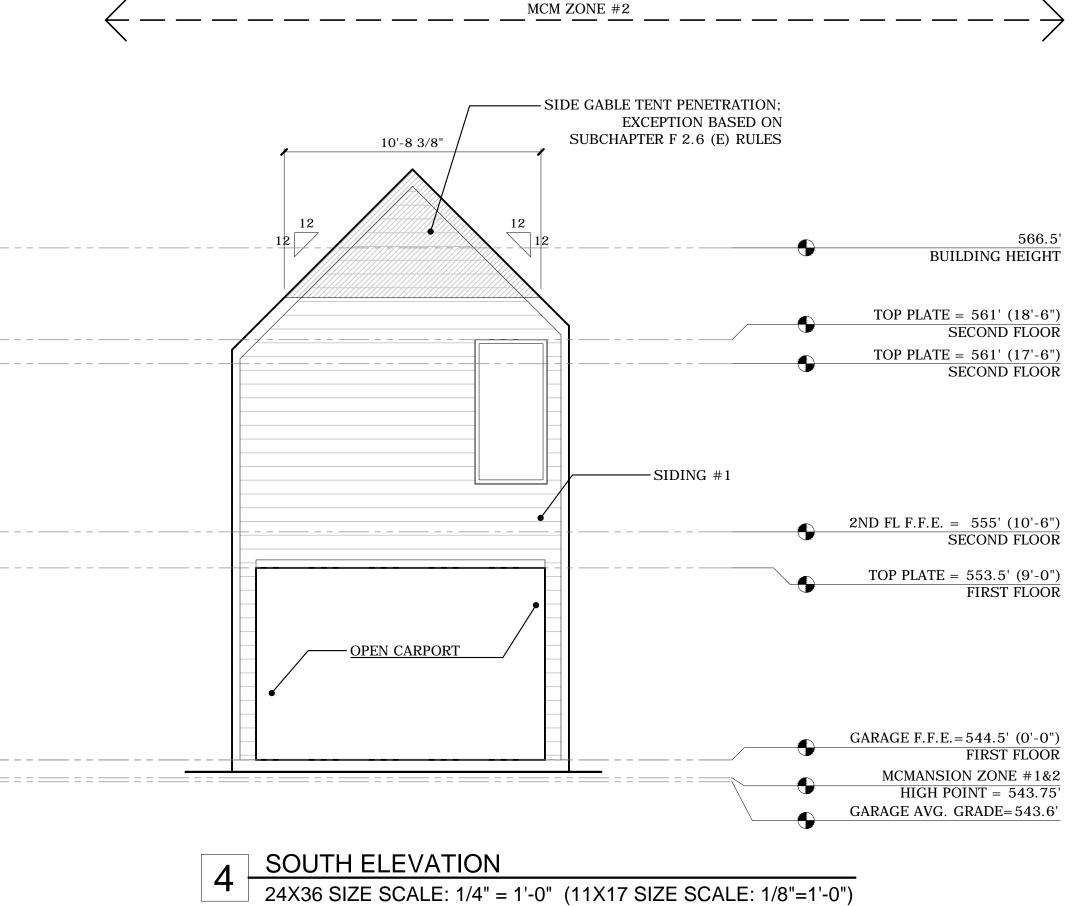



MCM ZONE #2

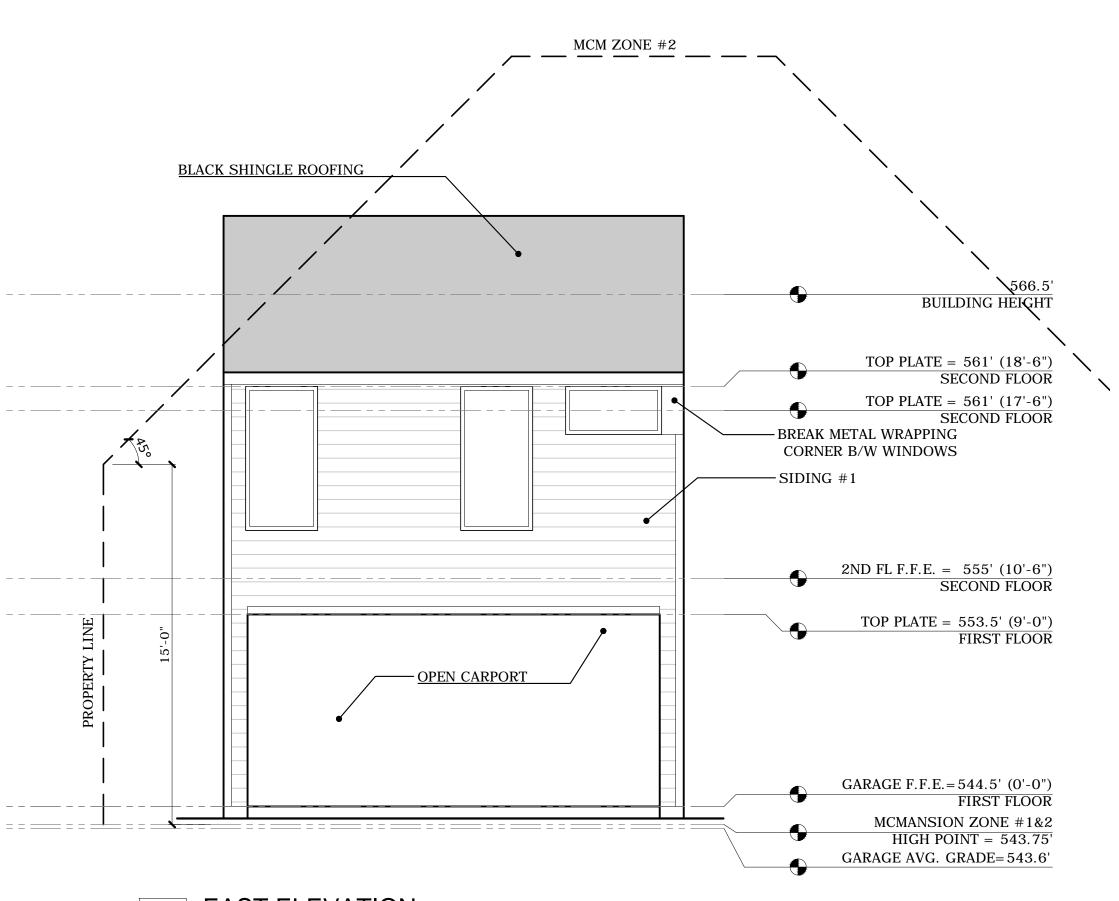

EAST ELEVATION

24X36 SIZE SCALE: 1/4" = 1'-0" (11X17 SIZE SCALE: 1/8"=1'-0")

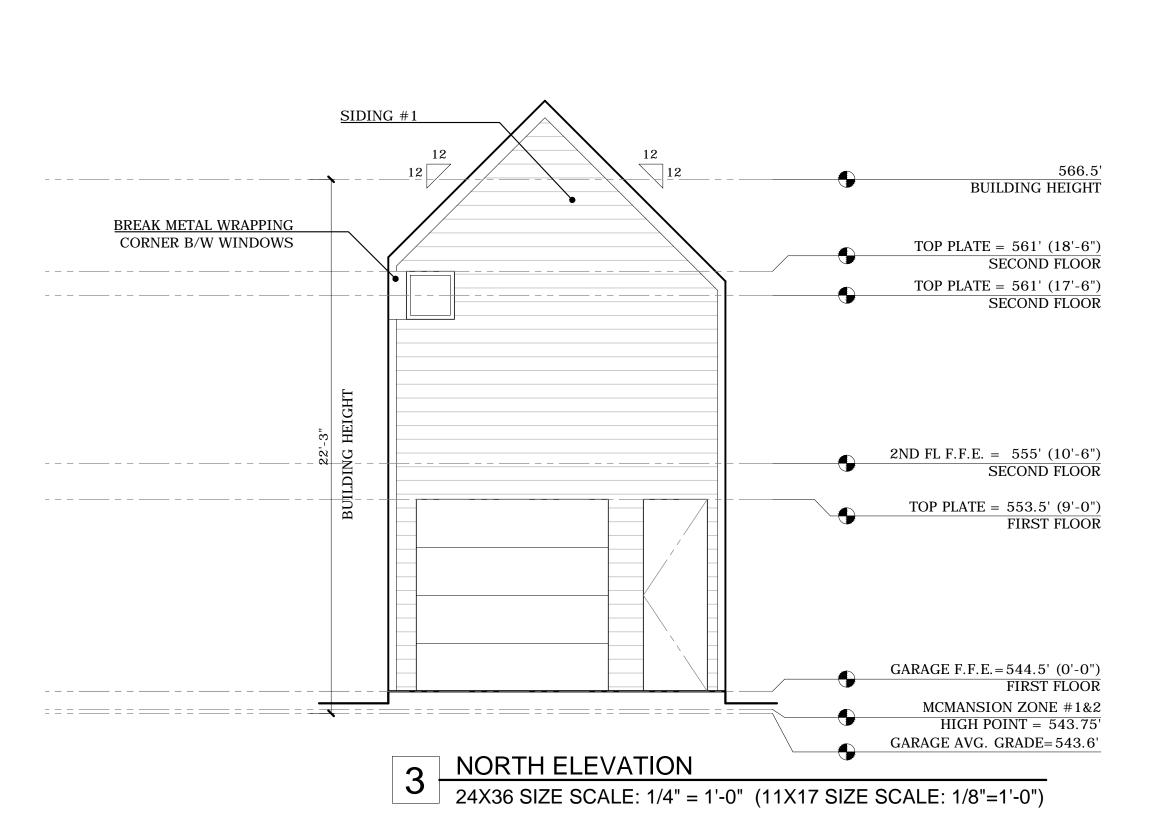

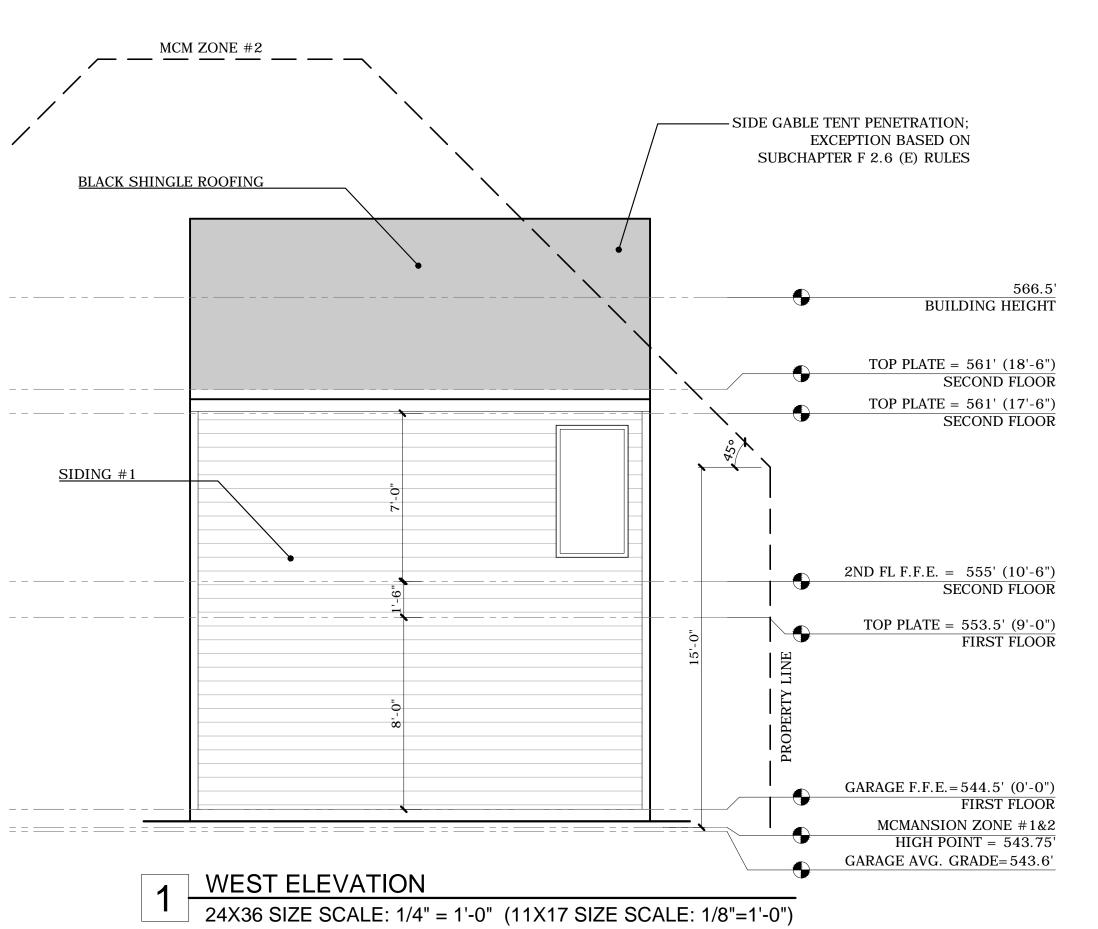

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GARAGE ELEVATIONS

A3.2

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