

ADDITION TO TONER HOUSE

COVER SHEET

G0.00



ADDITION TO TONER HOUSE

2902 OAKMONT BLVD AUSTIN, TX 78703

SHEET INDEX

G0.00	COVER SHEET
G0.10	PROJECT INFORMATION
A0.10	ARCHITECTURAL SITE
A1.01	FLOOR PLAN
A1.02	ROOF PLAN
A1.41	RCP
A2.11	BUILDING ELEVATIONS
A3.11	BUILDING SECTIONS
A5.11	WINDOW DETAILS
A5.12	FOUNDATION DETAILS
A5.13	ROOF DETAILS
A6.11	DOORS & WINDOWS

PROJECT TEAM


Architect of Record

FORGE CRAFT ARCHITECTURE + DESIGN 608 W. Monroe Street Austin, TX 78704 Alex@forgecraftarchitecture.com


Structural Engineer STRUCTURES - Dante Angelini

STRUCTURES - Dante Ange 6926 N. Lamar Llvd. Austin, Texas 78752 (512) 499-0919

VICINITY MAP

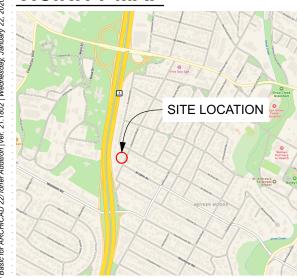

KEY PLAN

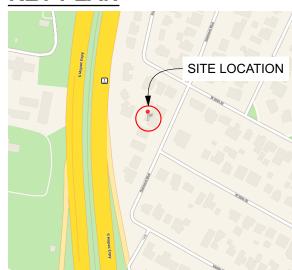

ZONING: SF-3-NP

LEGAL DESCRIPTION: E 150 FT OF LOT 1 BRYKERWOODS ANNEX NO 2 RESUB OF PT LTS 6-10

STANDARDS	REQUIRED / ALLOWED	PROVIDED
LOT AREA:	2,500 SF MIN.	9,427 SF
FLOOR AREA RATIO:	.40 (3,770.0 SF)	.28 (2,670 SF)
BUILDING COVERAGE:	.40 (3,770.0 SF)	.26 (2,457 SF)
IMPERVIOUS COVER	.45 (4,242 SF)	.42 (3,924 SF)
FRONT SETBACK:	25'	25'
SIDE YARD SETBACK:	5'	5'
REAR SETBACK:	10'	10'

SITE DEVELOPMENT INFORMATION

AREA	EXISTING	REMOVED	ADDED	TOTAL
1ST FLR CONDITIONED (MAIN HOUSE)	1,576	0	0	1,576 SF
1ST FLR CONDITIONED (ADDITION)	0	0	614	614 SF
2ND FLR CONDITIONED (MAIN HOUSE)	0	0	0	480 SF
BASEMENT	0	0	0	0 SF
COVERED PARKING	0	0	163	163 SF
COVERED PATIO, DECKS	140	0	60	200 SF
OTHER COVERED	0	0	0	0 SF
UNCOVERED DECKS/OPEN STAIRS	0	0	0	0 SF
DRIVEWAY, IMP. WALKSWAYS, AC PAD	1,295	0	0	1,295 SF

TOTAL COVERED AREA (.26)	2,457 SF
TOTAL IMPERVIOUS COVER ALLOWED (.45)	4,262.4 SF
TOTAL IMPERVIOUS COVER. (.41)	3,924 SF

F.A.R. CALCULATIONS:

AREA	EXISTING	REMOVED	ADDED	TOTAL	
MAIN HOUSE (1ST FLR)	1,576	0	0	1,576 SF	
ADDITION (1ST FLR)	0	0	614	614 SF	
MAIN HOUSE (2ND FLR)	0	0	492	480 SF	
SPACE OVER 15' TALL	0	0	0	0 SF	
GARAGE (DETACHED)	0	0	0	0 SF	
CARPORT	0	0	0	0 SF	
ACCESSORY BUILDINGS	0	0	0	0 SF	

TOTAL F.A.R. ALLOWED (.40)	3,770.0 SF
TOTAL ACTUAL F.A.R. (.28)	2.670 SF

PARKING:

LAND USE	REQUIRED	PROVIDED
MAIN HOUSE	2	2

TOTAL PARKING REQUIRED	2
TÓTAL PARKING PROVIDED	2



Scott Ginder - Texas Architect Registration # 21234

1.20.20

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REV DATE DESCRIPTION


ISSUE:
PERMIT SET

DATE:
01/22/20
PROJECT NUMBER:
2018
SHEET TITLE:
PROJECT

G0.10

INFORMATION

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ARCHITECTUR

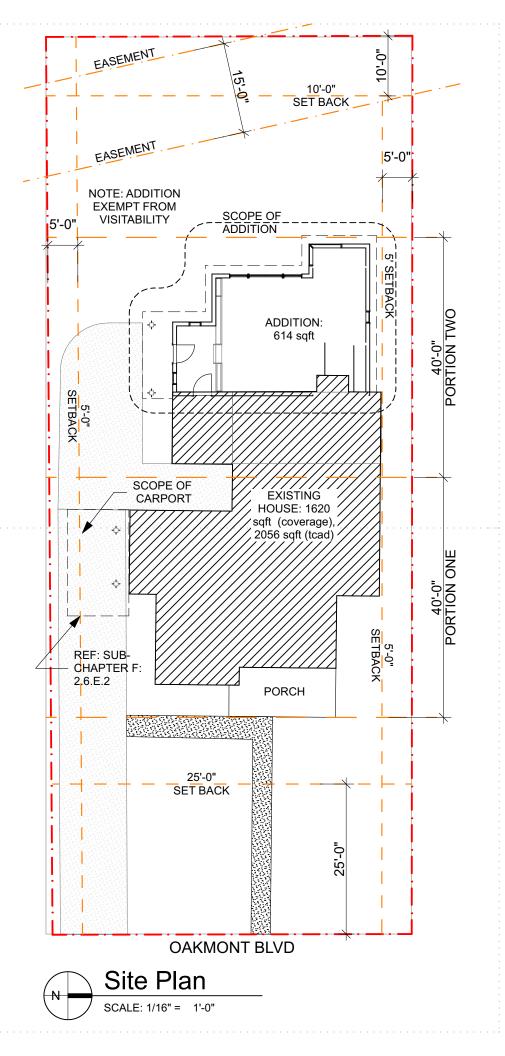
AL SITE

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ROOF PLAN GENERAL NOTES:

- ROOF ELEVATIONS ARE SET FROM A DATUM OF 0.00" = SCUPPER DRAINAGE PLANE = 52° 2 $3/4^{\circ}$ (+/-). OVERFLOW SCUPPERS SHALL HAVE OVERFLOW DRAINAGE PLANE @ +2.00".
- A BASE LAYER OF 4 INCHES RIGID POLYISOCYANURATE SHALL BE APPLIED OVER ENTIRE SURFACE OF ROOF TO ACHIEVE A MINIMUM R-22. IECC 2012 AND ASHRAE 90.1 (2010) BOTH REQUIRE R-20 CI OR AGGREGATE R-38 IF INSULATING ATTIC SPACES. PROVIDE ADDITIONAL 6 INCHES R-19 GLASS FIBER BATT INSULATION IN ATTIC CAVITY. AVERAGE R-VALUE FROM TAPERED INSULATION OVER BASE LAYER OF RIGID POLYISO SHOULD PLACE AGGREGATE R-VALUE OF ENTIRE ROOF ASSEMBLY OVER R-49.
- POLYISO RIGID INSULATION SHALL BE INSTALLED IN LAYERS NOT EXCEEDING 2 INCHES IN DEPTH. INITIAL 2 INCH BASE LAYER SHALL BE MECHANICALLY FASTENED TO ROOF DECK UNDERLAYMENT AS WARRANTIED BY MANUFACTURER. SUBSEQUENT LAYERS SHALL BE FULLY ADHERED.
- ALL ROOF COMPONENTS SHALL BE INSTALLED ACCORDING TO MANUFACTURER'S INSTRUCTIONS AND WARRANTY. CONTRACTOR SHALL INFORM ARCHITECT OF ANY POTENTIALLY NON-COMPATIBLE COMPONENTS AND INSTALLATION CONFLICTS.
- ALL ROOF PENETRATIONS SHALL BE SURROUNDED BY PROPERLY FLASHED AND WATERPROOFED CURB EXCEPT PROPRIETARY PIPE PENETRATIONS WHICH SHALL BE INSTALLED ACCORDING TO MANUFACTURER'S WARRANTIED METHODS AND WITH COMPATIBLE MATERIALS.
- ALL ROOF EQUIPMENT SHALL BE SUPPORTED ON CURBS AND/OR ISOLATORS AS WARRANTIED BY MANUFACTURER.
- DEAD LOADS AND LIVE LOADS ASSOCIATED WITH ALL ROOF EQUIPMENT SHALL BE EVALUATED FOR STRUCTURAL LOADING AND SUPPORT DETAILING.
- ANY SECONDARY SUPPORT STRUCTURE BEARING ON ROOF ASSEMBLY SHALL BE INSTALLED SO AS NOT TO DAMAGE OR DISRUPT IN ANY WAY INSULATING AND WATERPROOFING ENVELOPE PERFORMANCE OF ROOF
- 10. PROVIDE COMPATIBLE ROOF MATS WHERE REQUIRED. ATTACH TO ROOF ASSEMBLY AS WARRANTIED BY ROOF MANUFACTURER. PROVIDE MINIMUM 6 INCH GAPS BETWEEN INDIVIDUAL ROOF MAT PIECES TO ENSURE APPROPRIATE DRAINAGE.
- ROOFING WITH SLOPE LESS THAN 2 INCHES IN 12 TO MEET ONE OF THE FOLLOWING OPTIONS IN COMPLIANCE WITH IECC SECTION 402.2.1.1:
 - THREE-YEAR-AGED SOLAR REFLECTANCE OF 0.55 AND THREE-YEAR AGED THERMAL EMITTANCE OF 0.75 INITIAL SOLAR REFLECTANCE OF 0.70 AND INITIAL THERMAL EMITTANCE OF 0.75 THREE-YEAR-AGED SOLAR REFLECTANCE INDEX OF 64 INITIAL SOLAR REFLECTANCE INDEX OF 64





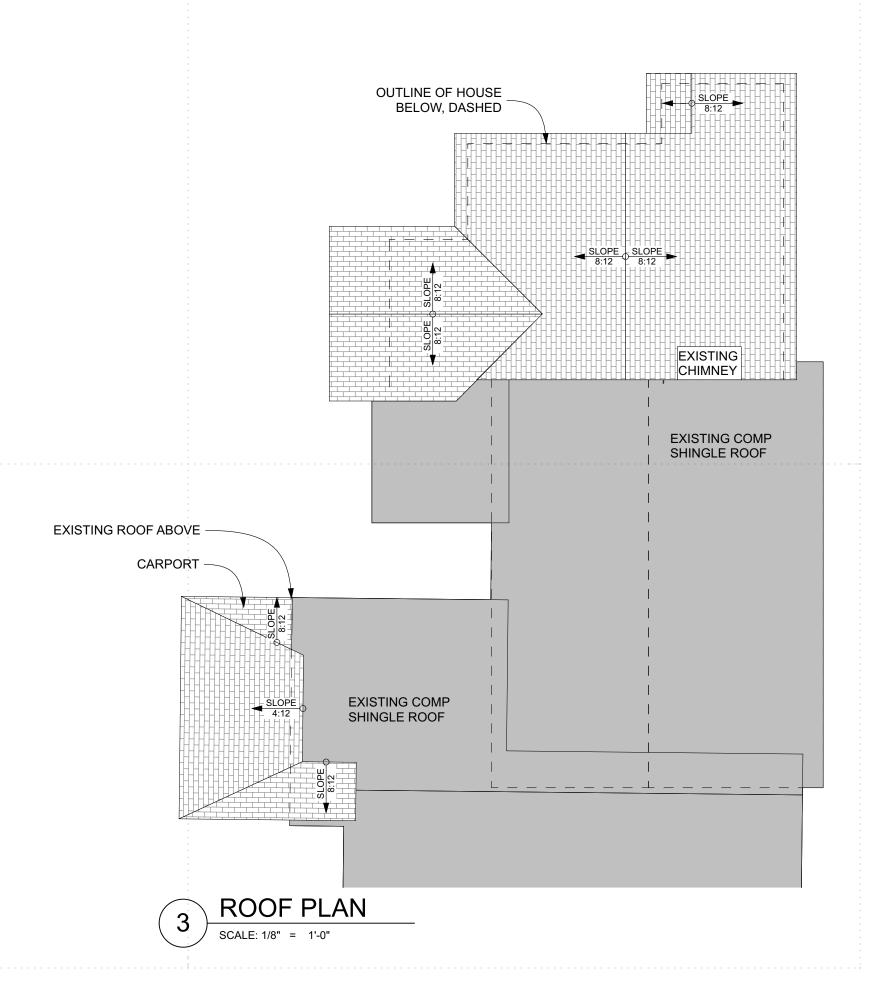

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1.20.20


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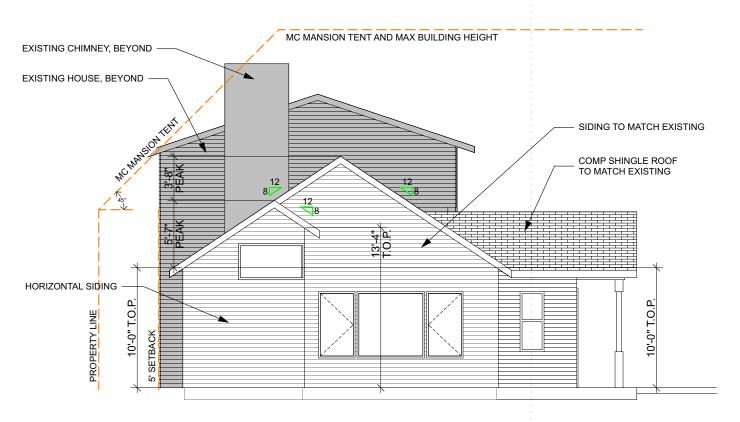
PERMIT SET 01/22/20 PROJECT NUMBER: SHEET TITLE: **ROOF PLAN**

EXISTING CHIMNEY




NORTH ELEVATION

SCALE: 1/8" = 1'-0"

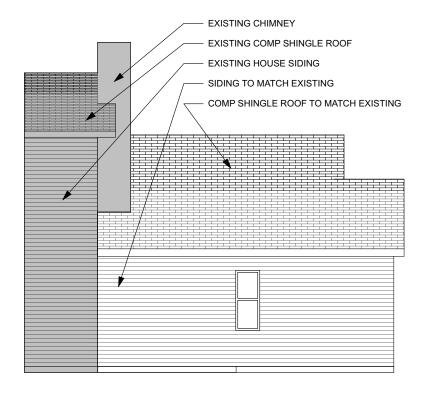

3 WEST ELEVATION

SCALE: 1/8" = 1'-0"

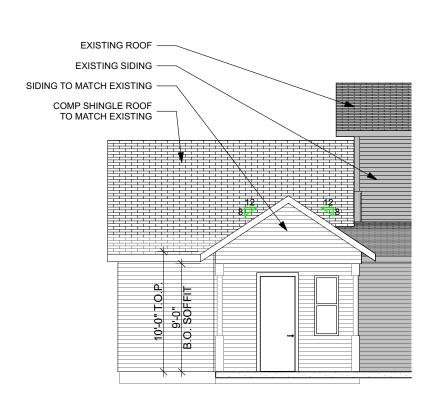

SOUTH ELEVATION

SCALE: 1/8" = 1'-0"





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BUILDING

A2.1

ELEVATIONS

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