

## SITE PLAN GENERAL NOTES

- 1. All spot elevations to be verified in field prior to construction. Notify MHOA of any discrepancies. Benchmark to be verified with architect prior to construction.
- Do not scale the drawings. If a specific dimension is not given,
- contact MHOA for clarification. GC is responsible for protecting and repairing additional damage 4. arising during both demolition phase and new construction phase on existing partitions, finishes, and building elements that are to remain.
- Tree protection fencing is required for all existing trees 19 inches in diameter (60 inches in circumference) within the limits of 5. construction. Fencing should protect the entire critical root zone (CRZ) area. Fencing is required to be chain-link mesh at a minimum height of five feet. A 6-inch layer of mulch within the entire available root zone area is required for trees which have any disturbance indicated within any portion of the critical root zone. Refer to General Requirements for additional information 6. associated with, but not limited to: submittals, shop drawings, samples, cutting and patching, coordination and staging, protection


## SITE PLAN KEYNOTES

of work.





ease tor	Mitigat	ion Provide
/	Legend	
/		New Impervious Flatwork
		New Acc. Path Impervious
_		New Parking Impervious
		Repaired Parking Impervious

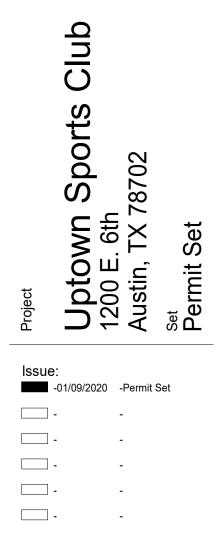

Drawing Title

Site Plan Sheet



Existing door opening, covered in ptd. plywood

# Existing wood window frame, covered in ptd. plywood -

Existing wood door and transom, covered in ptd. plywood

Existing double-hung wood window frame, covered in ptd. plywood

Existing wood door and transom, covered in ptd. stucco 一

Existing wood window above, typ.



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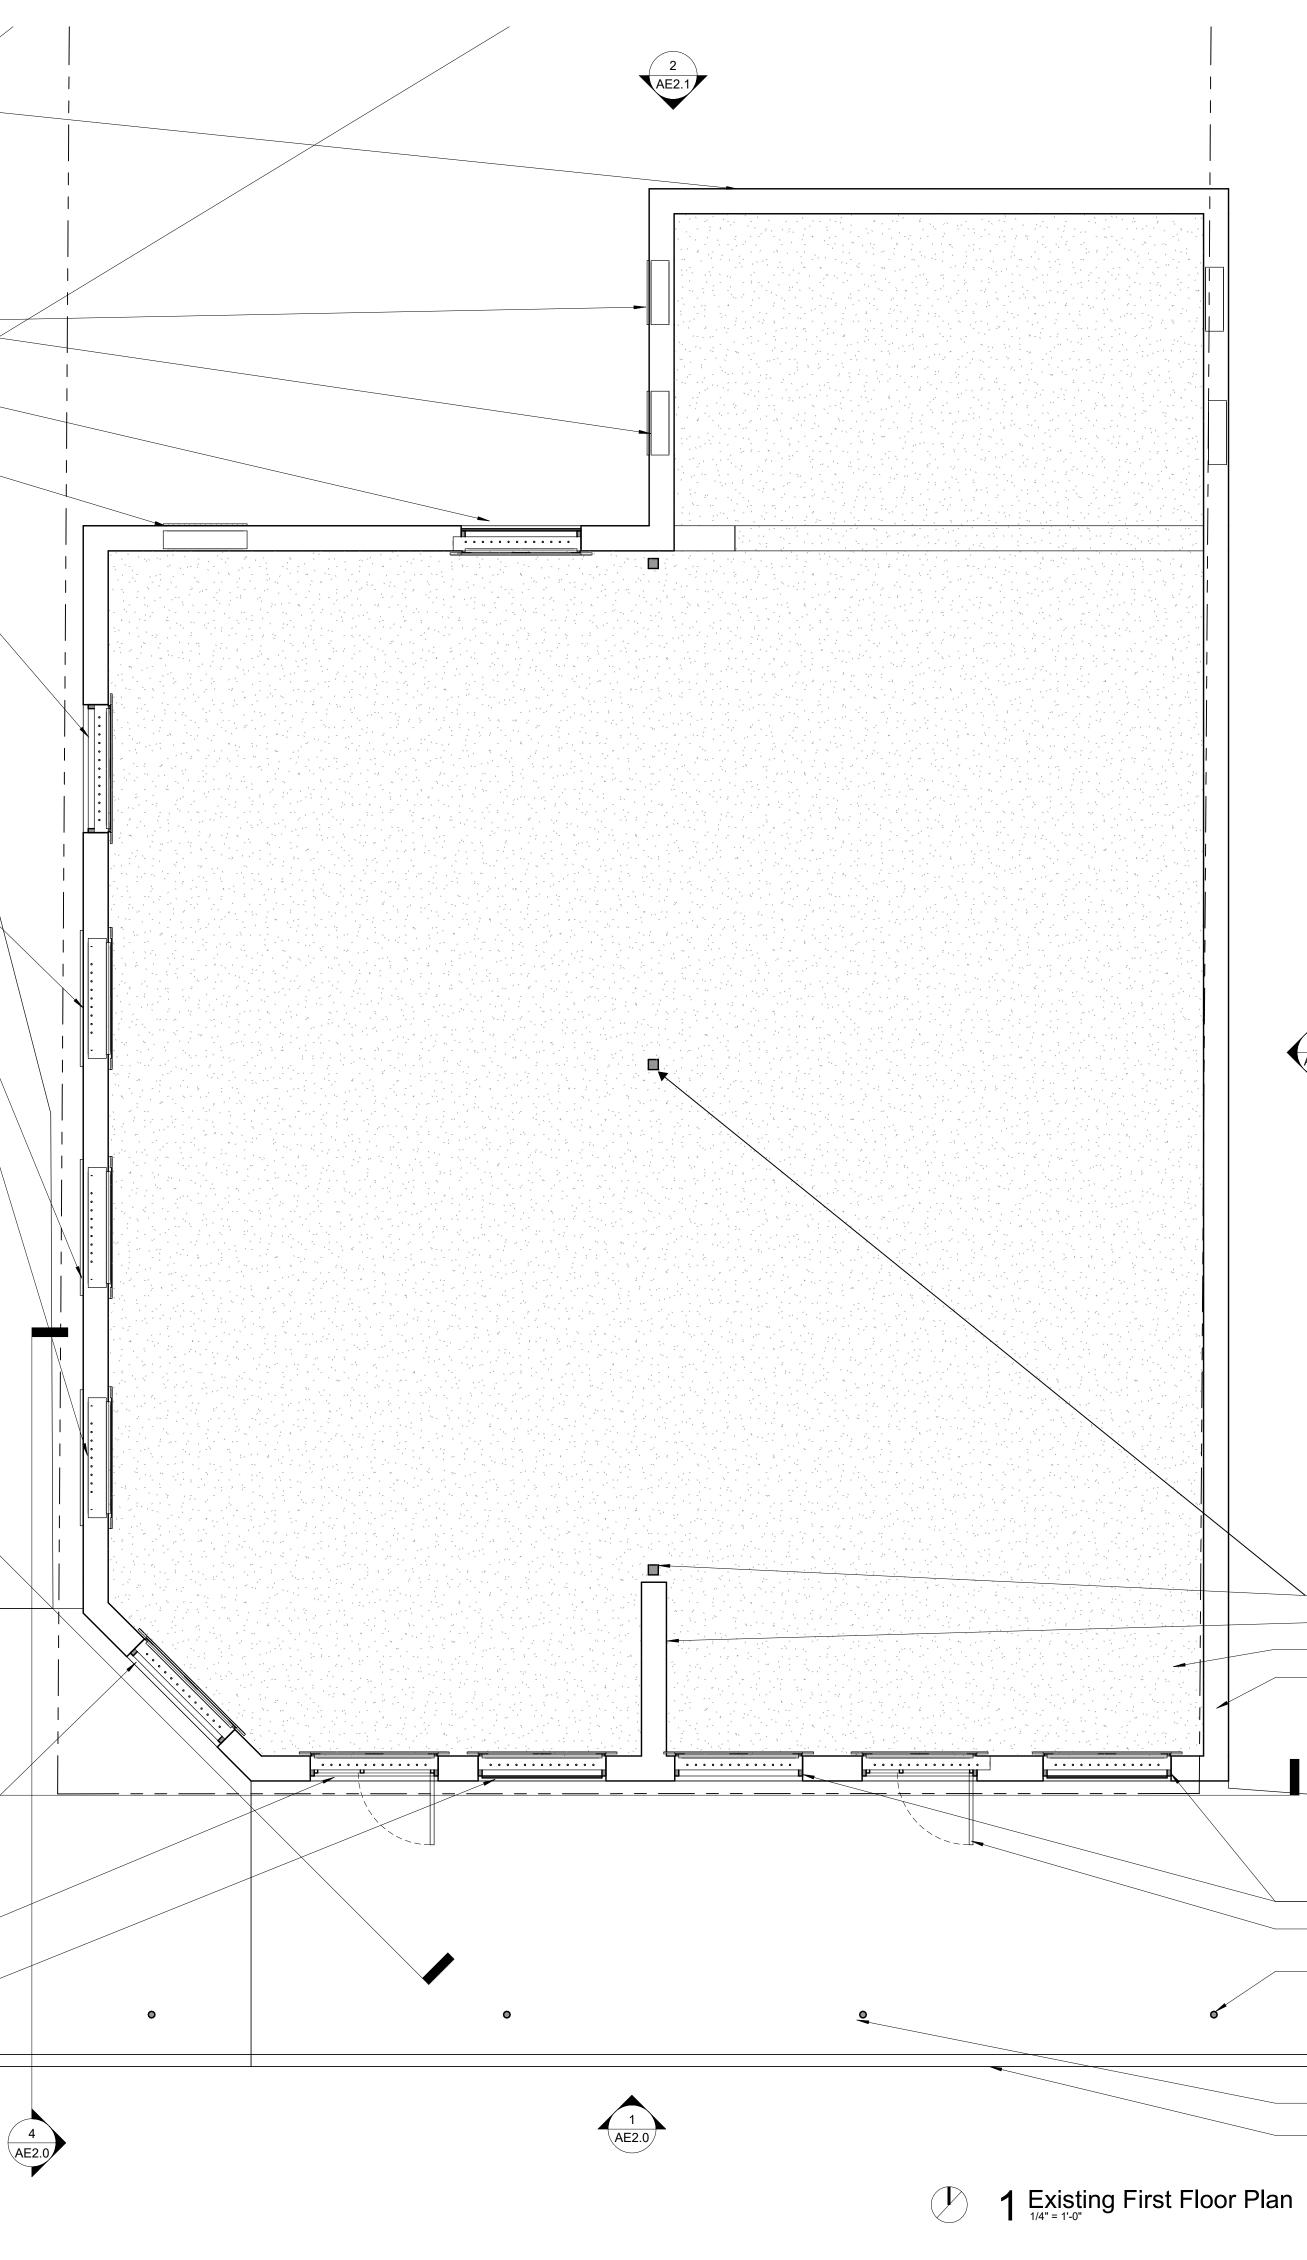
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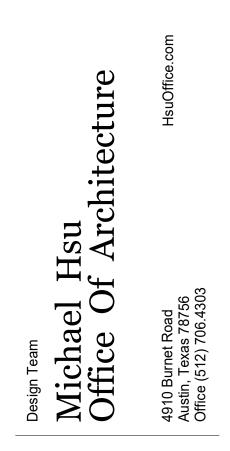
AE2.1

Existing wood door and transom, covered in ptd. plywood


Existing aluminum storefront in existing wood door frame with transom

Existing wood storefront and transom, covered in ptd. plywood







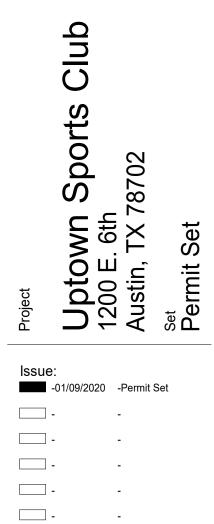


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Drawing Title




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- Existing wood door, frame and transom Existing aluminum storefront in existing wood door frame with transom - Existing ptd. iron canopy columns, typ.

Existing ptd. wood signage marquee above, typ. Existing concrete curb

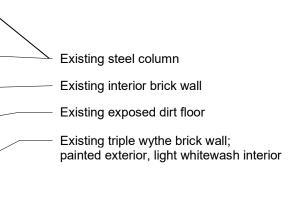

## **DEMOLITION GENERAL NOTES**

- 1. The dimensions on this sheet are to face of stud and/or masonry, centerline of column/beam, and face of awning, unless noted otherwise
- GC to field verify all dimensions prior to demolition to verify extent 2. of demo to accommodate new work. If a discrepancy or unforeseen condition is identified, please notify MHOA immediately.
- Do not scale the drawings. If a specific dimension is not given, contact MHOA for clarification. 3.
- GC is responsible for protecting and repairing additional damage arising during both demolition phase and new construction phase 4. on existing partitions, finishes, and building elements that are to remain. Items noted to be salvaged are to be returned to the owner unless
- 5. otherwise noted. Tree protection fencing is required for all existing trees 19 inches in 6
- diameter (60 inches in circumference) within the limits of construction. Fencing should protect the entire critical root zone (CRZ) area. Fencing is required to be chain-link mesh at a minimum height of five feet. A 6-inch layer of mulch within the entire available root zone area is required for trees which have any
- disturbance indicated within any portion of the critical root zone. Refer to General Requirements for additional information associated with, but not limited to: submittals, shop drawings, samples, cutting and patching, coordination and staging, protection of work.

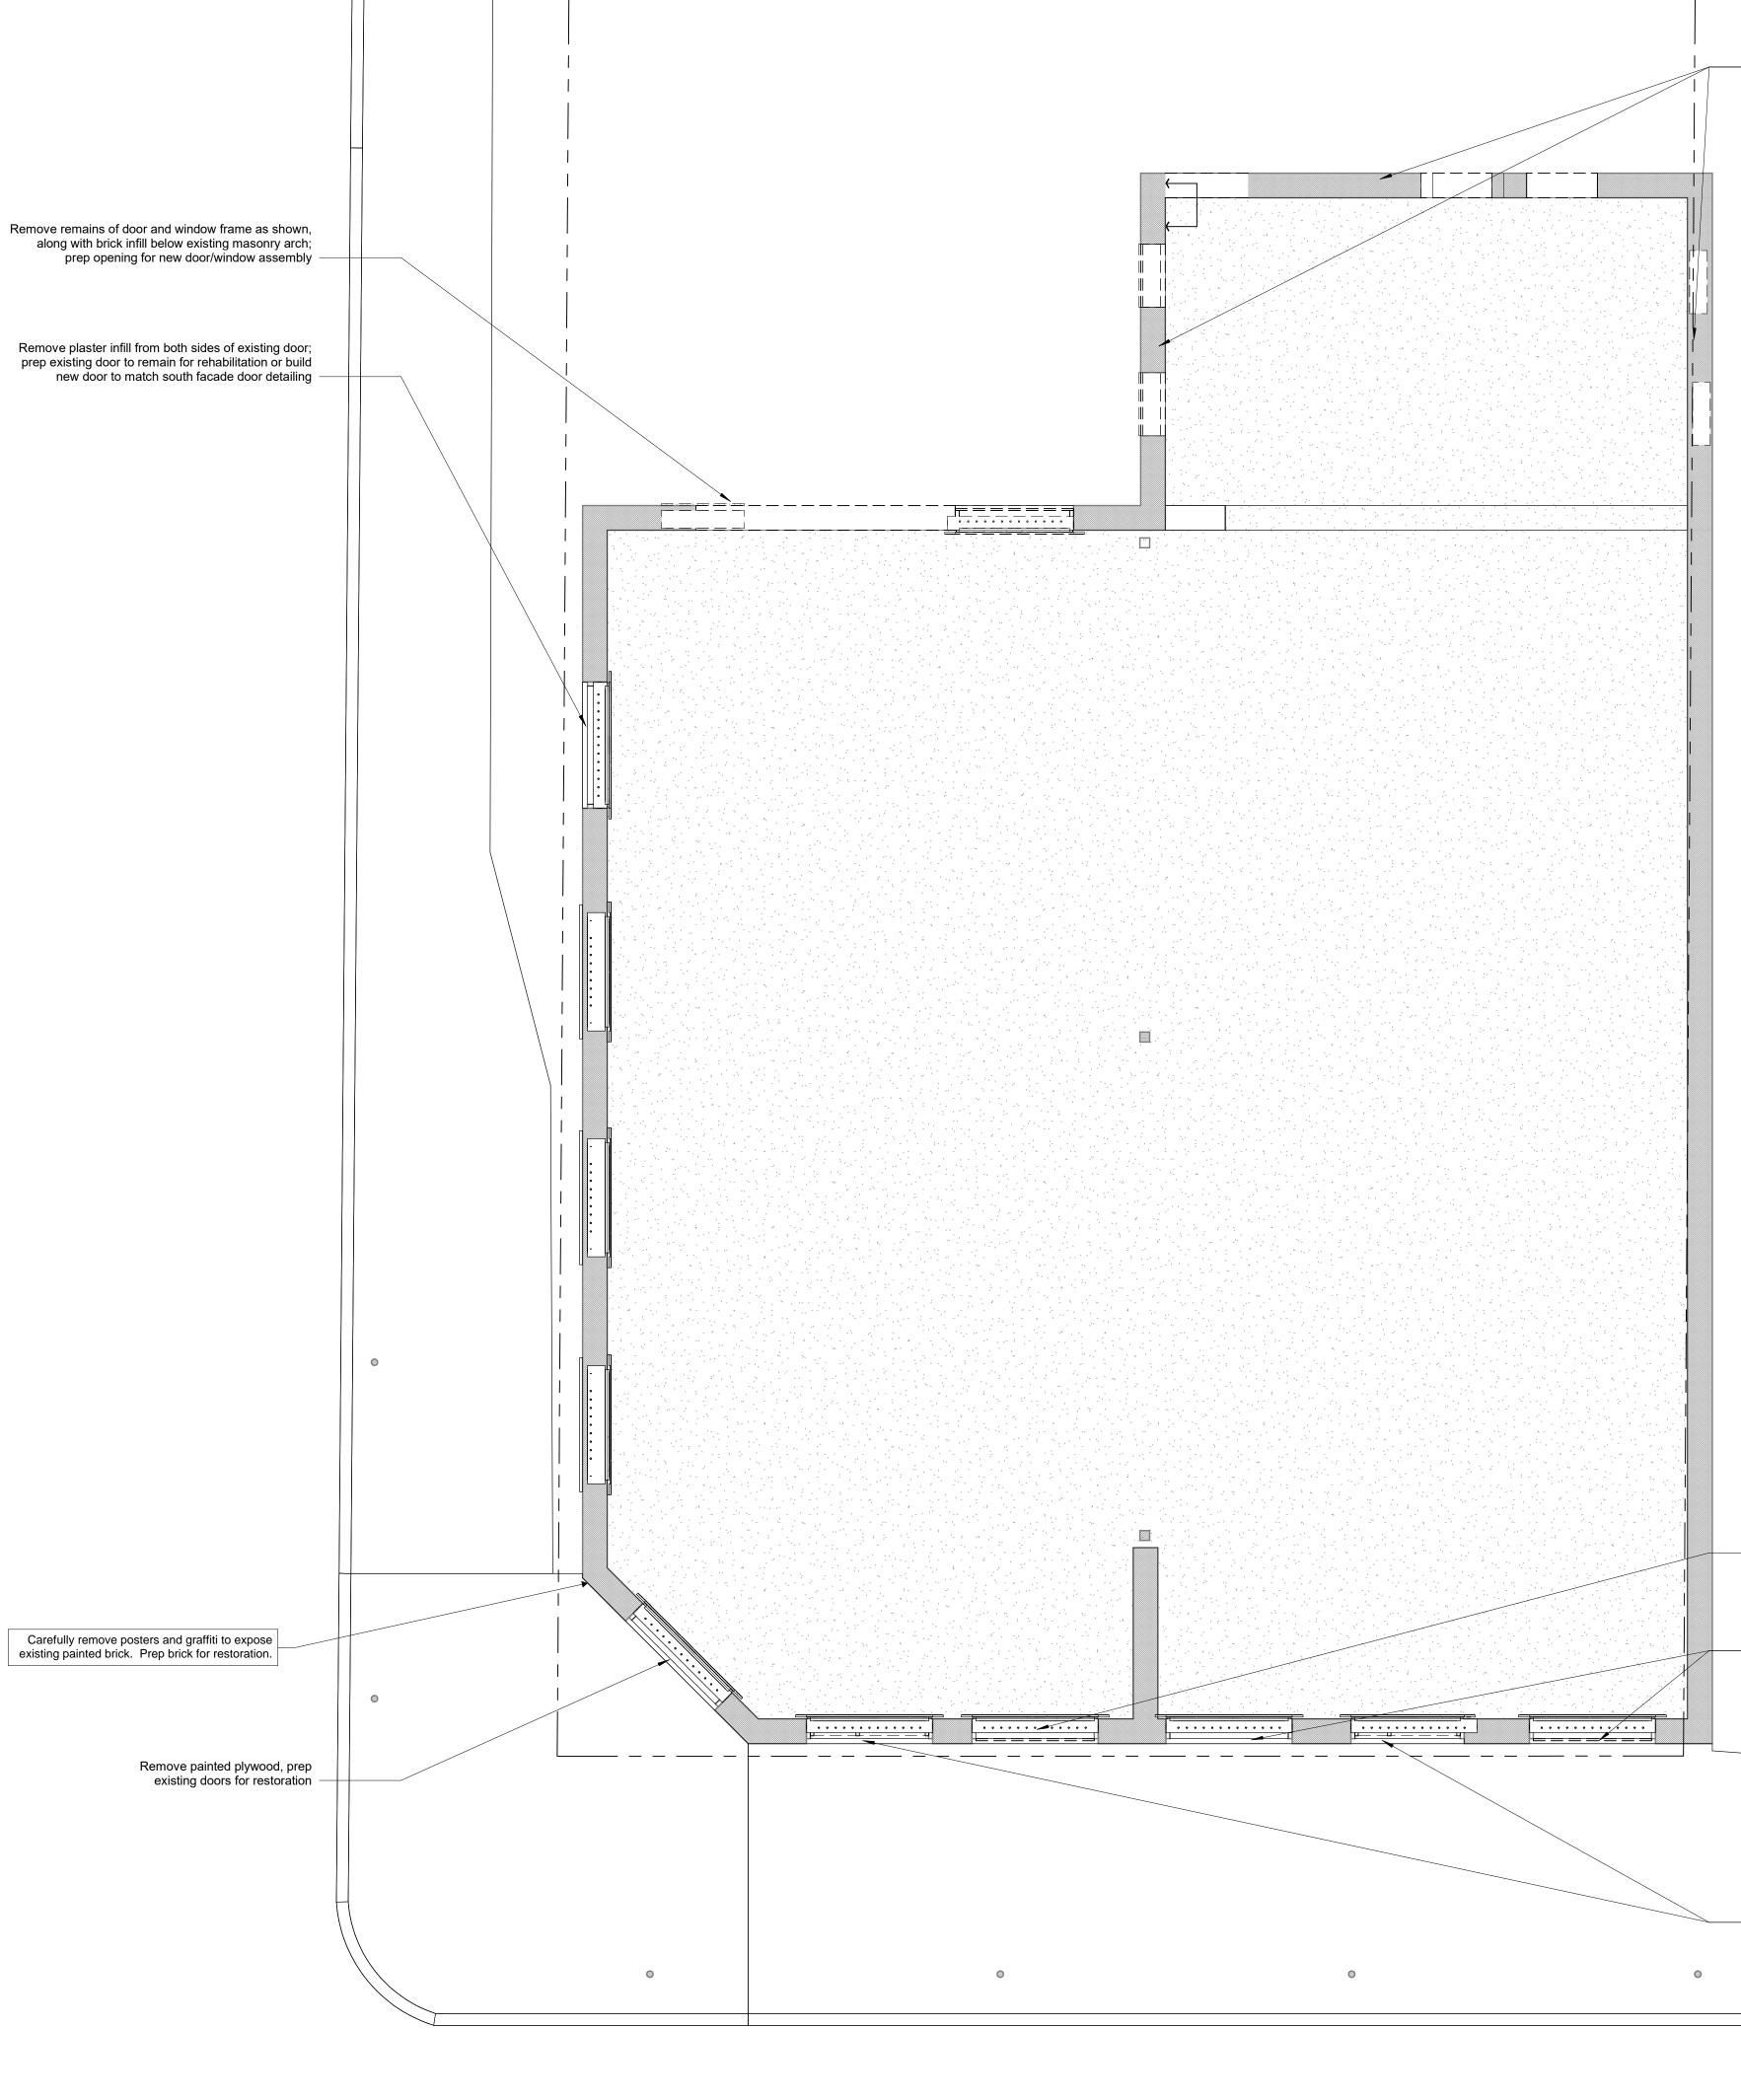
## **DEMOLITION KEYNOTES**

7.







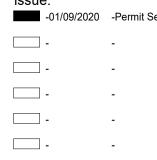

Drawing Title






Remove wood storefront window, prep existing wood frame to receive new reproduction wood doors

Remove painted plywood, prep existing doors for restoration

Remove Aluminum Storefront, prep existing wood frame to receive new reproduction wood doors

1 First Floor Demo Plan

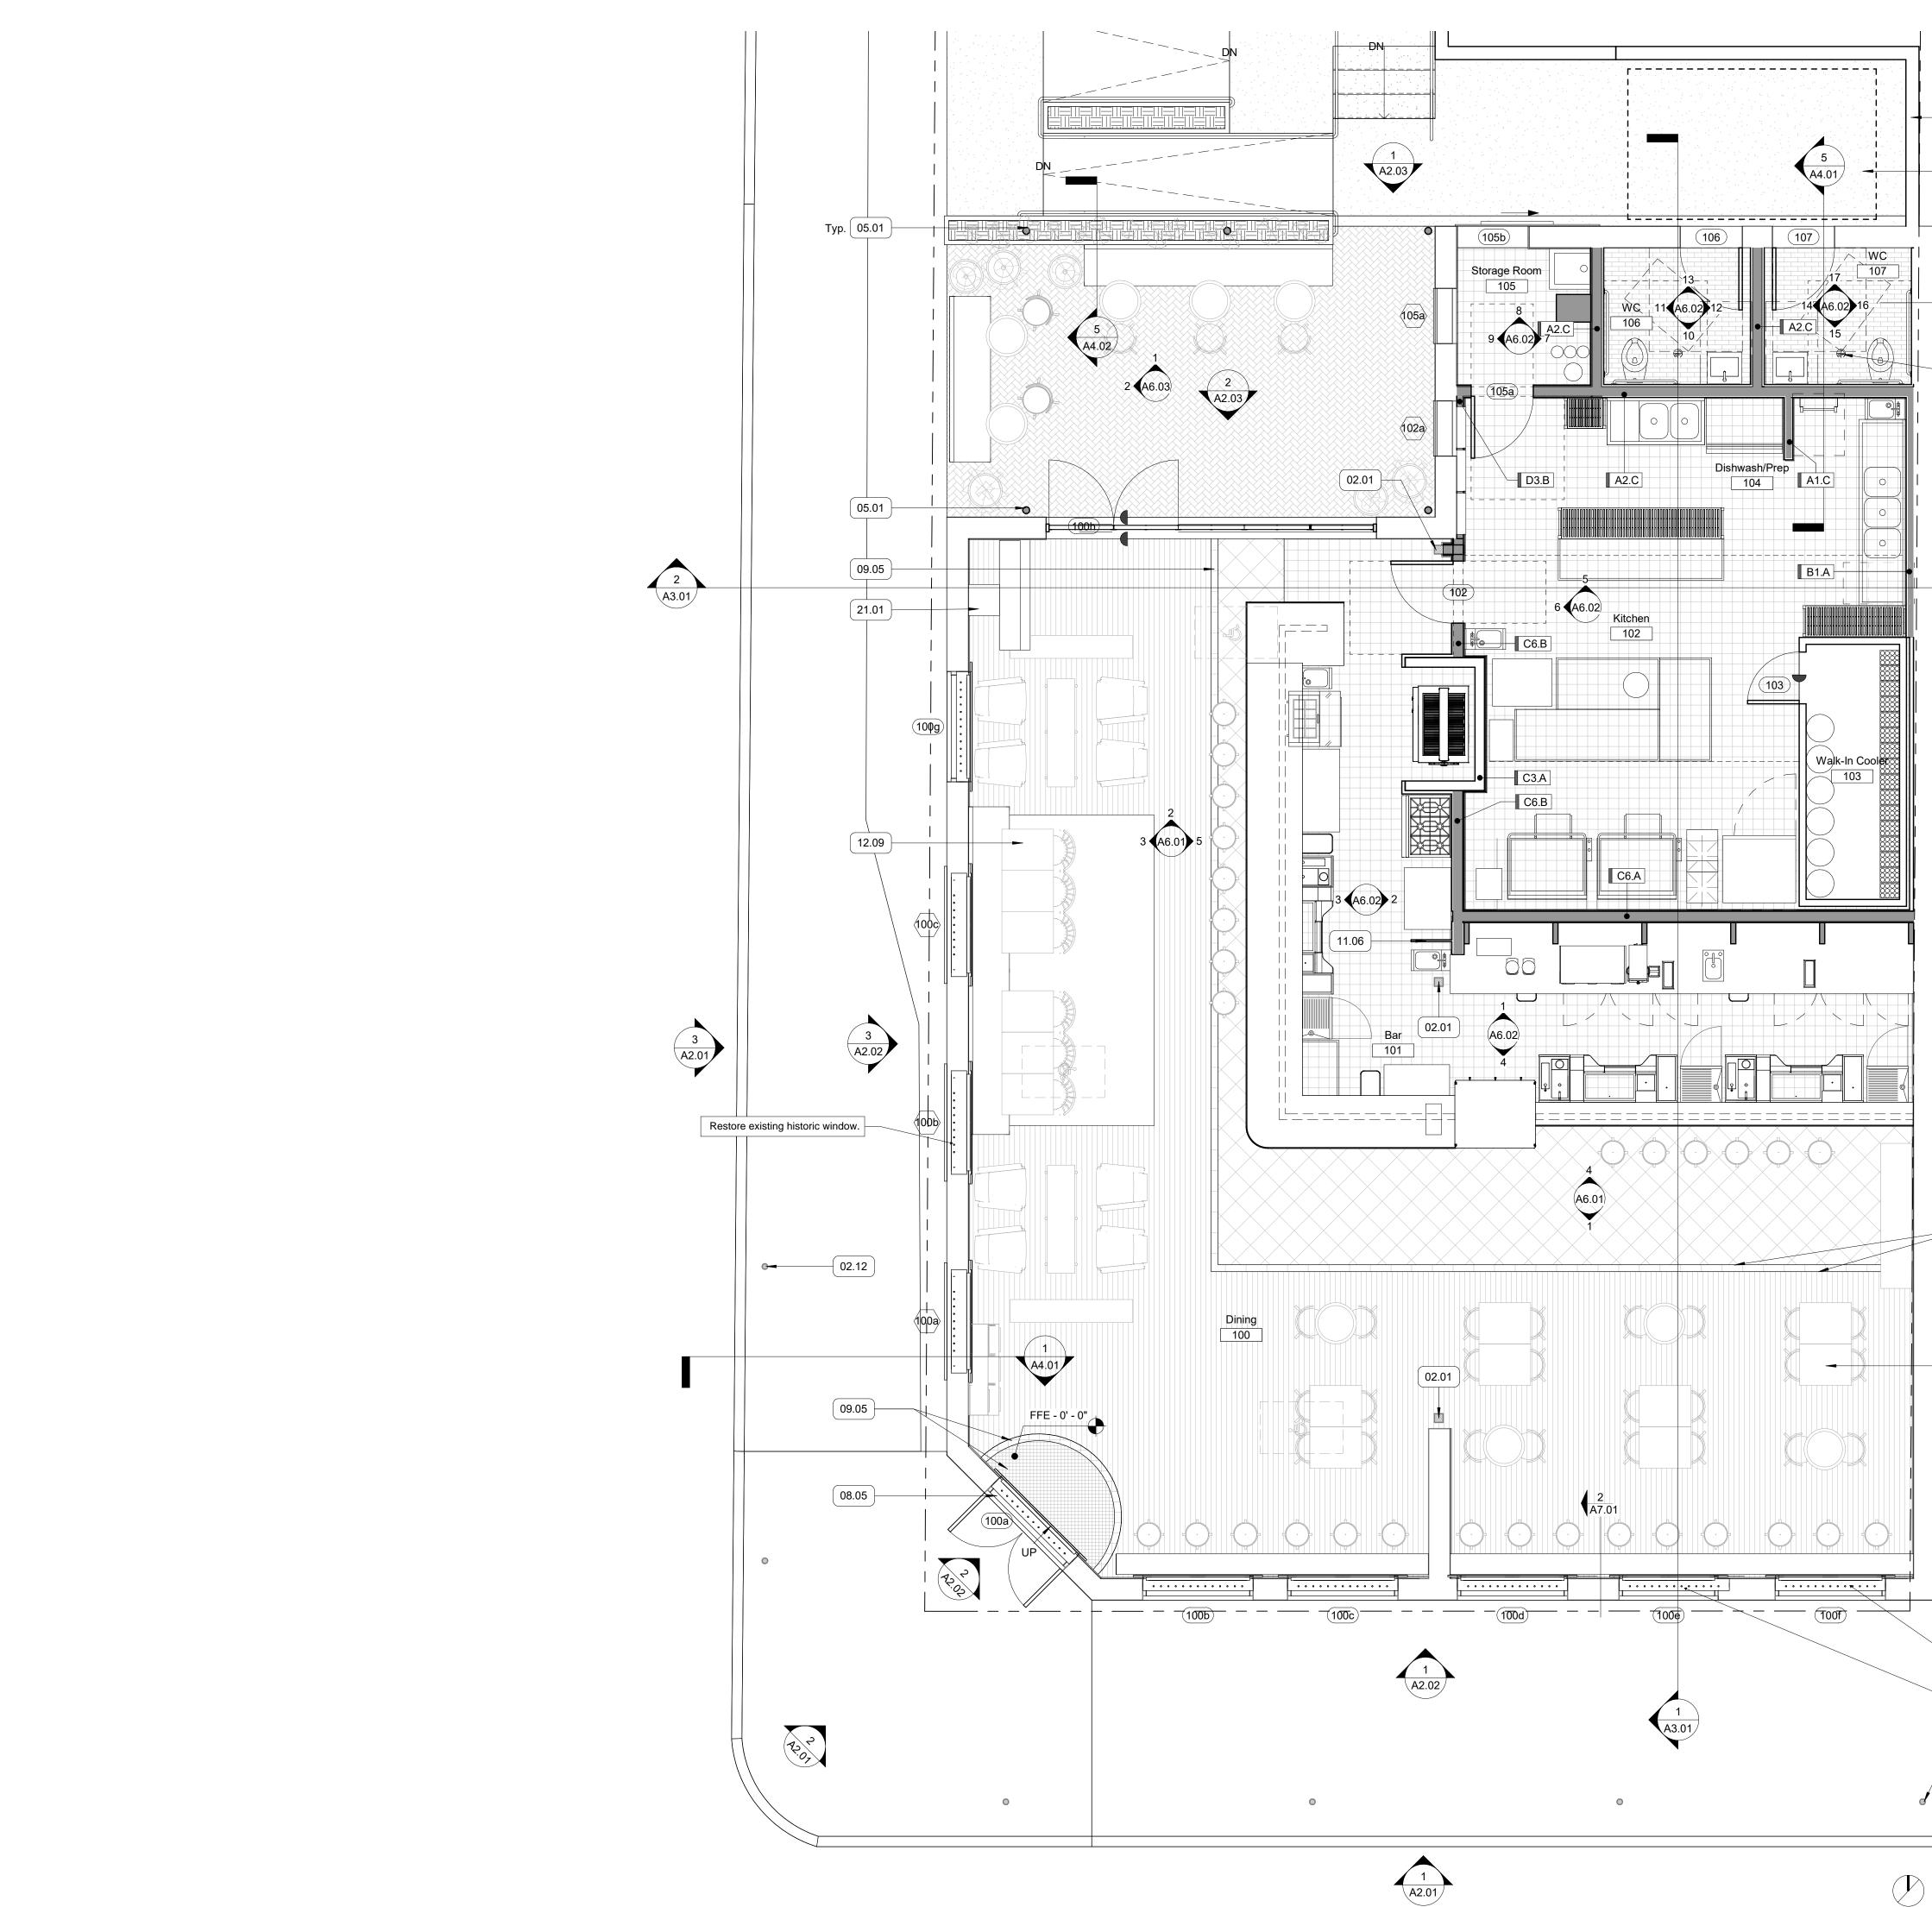

- 31.03

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of work.

1. The dimensions on this sheet are to face of stud and/or masonry,

FLOOR PLAN GENERAL NOTES

centerline of column/beam, and face of awning, unless noted otherwise.GC to field verify all dimensions prior to construction and/or

installation of any equipment, accessories, etc. If a discrepancy is identified, please notify MHOA immediately.GC to verify final locations for fire extinguishers with fire marshal

- and architect prior to installation. Refer to appropriate sheet and/or schedule for additional
- information/detail regarding items shown herein. Do not scale the drawings. If a specific dimension is not given,
- contact MHOA for clarification.
- GC is responsible for protecting and repairing additional damage arising during both demolition phase and new construction phase on existing partitions, finishes, and building elements that are to remain

remain. GC to provide portable fire extinguishers per International Fire Code Section 906 and/or local fire code and coordinate a final review of counts and locations with the local fire marshal/inspector. Refer to General Requirements for additional information associated with, but not limited to: submittals, shop drawings,

samples, cutting and patching, coordination and staging, protection


## FLOOR PLAN KEYNOTES

- 02.01 Existing steel column to remain, paint per Finish Schedule.02.12 Existing exterior steel column. Finish in PT-3.1, refer to Finish
- Schedule. 05.01 New steel column, refer to Structural.
- 08.05 Rebuild existing door to comply with egress requirements. See Door Schedule.
- 09.05 1/2" max. transition between flooring materials per TAS.
- 11.06 Stainless hood end panel per hood selection. Refer to MEP.
- 12.09 Furniture shown for reference only, provided by Owner. NIC.21.01 Fire riser, refer to MEP.
- 22.02 Grease Trap, refer to Civil and MEP.
- 31.03 Retaining wall, per Civil.



Consultant




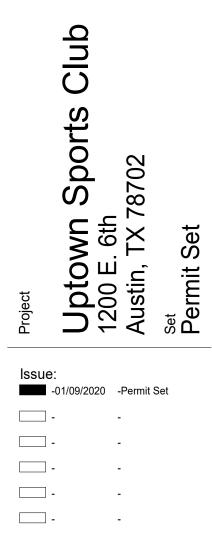

Drawing Title

First Floor Annotation Plan

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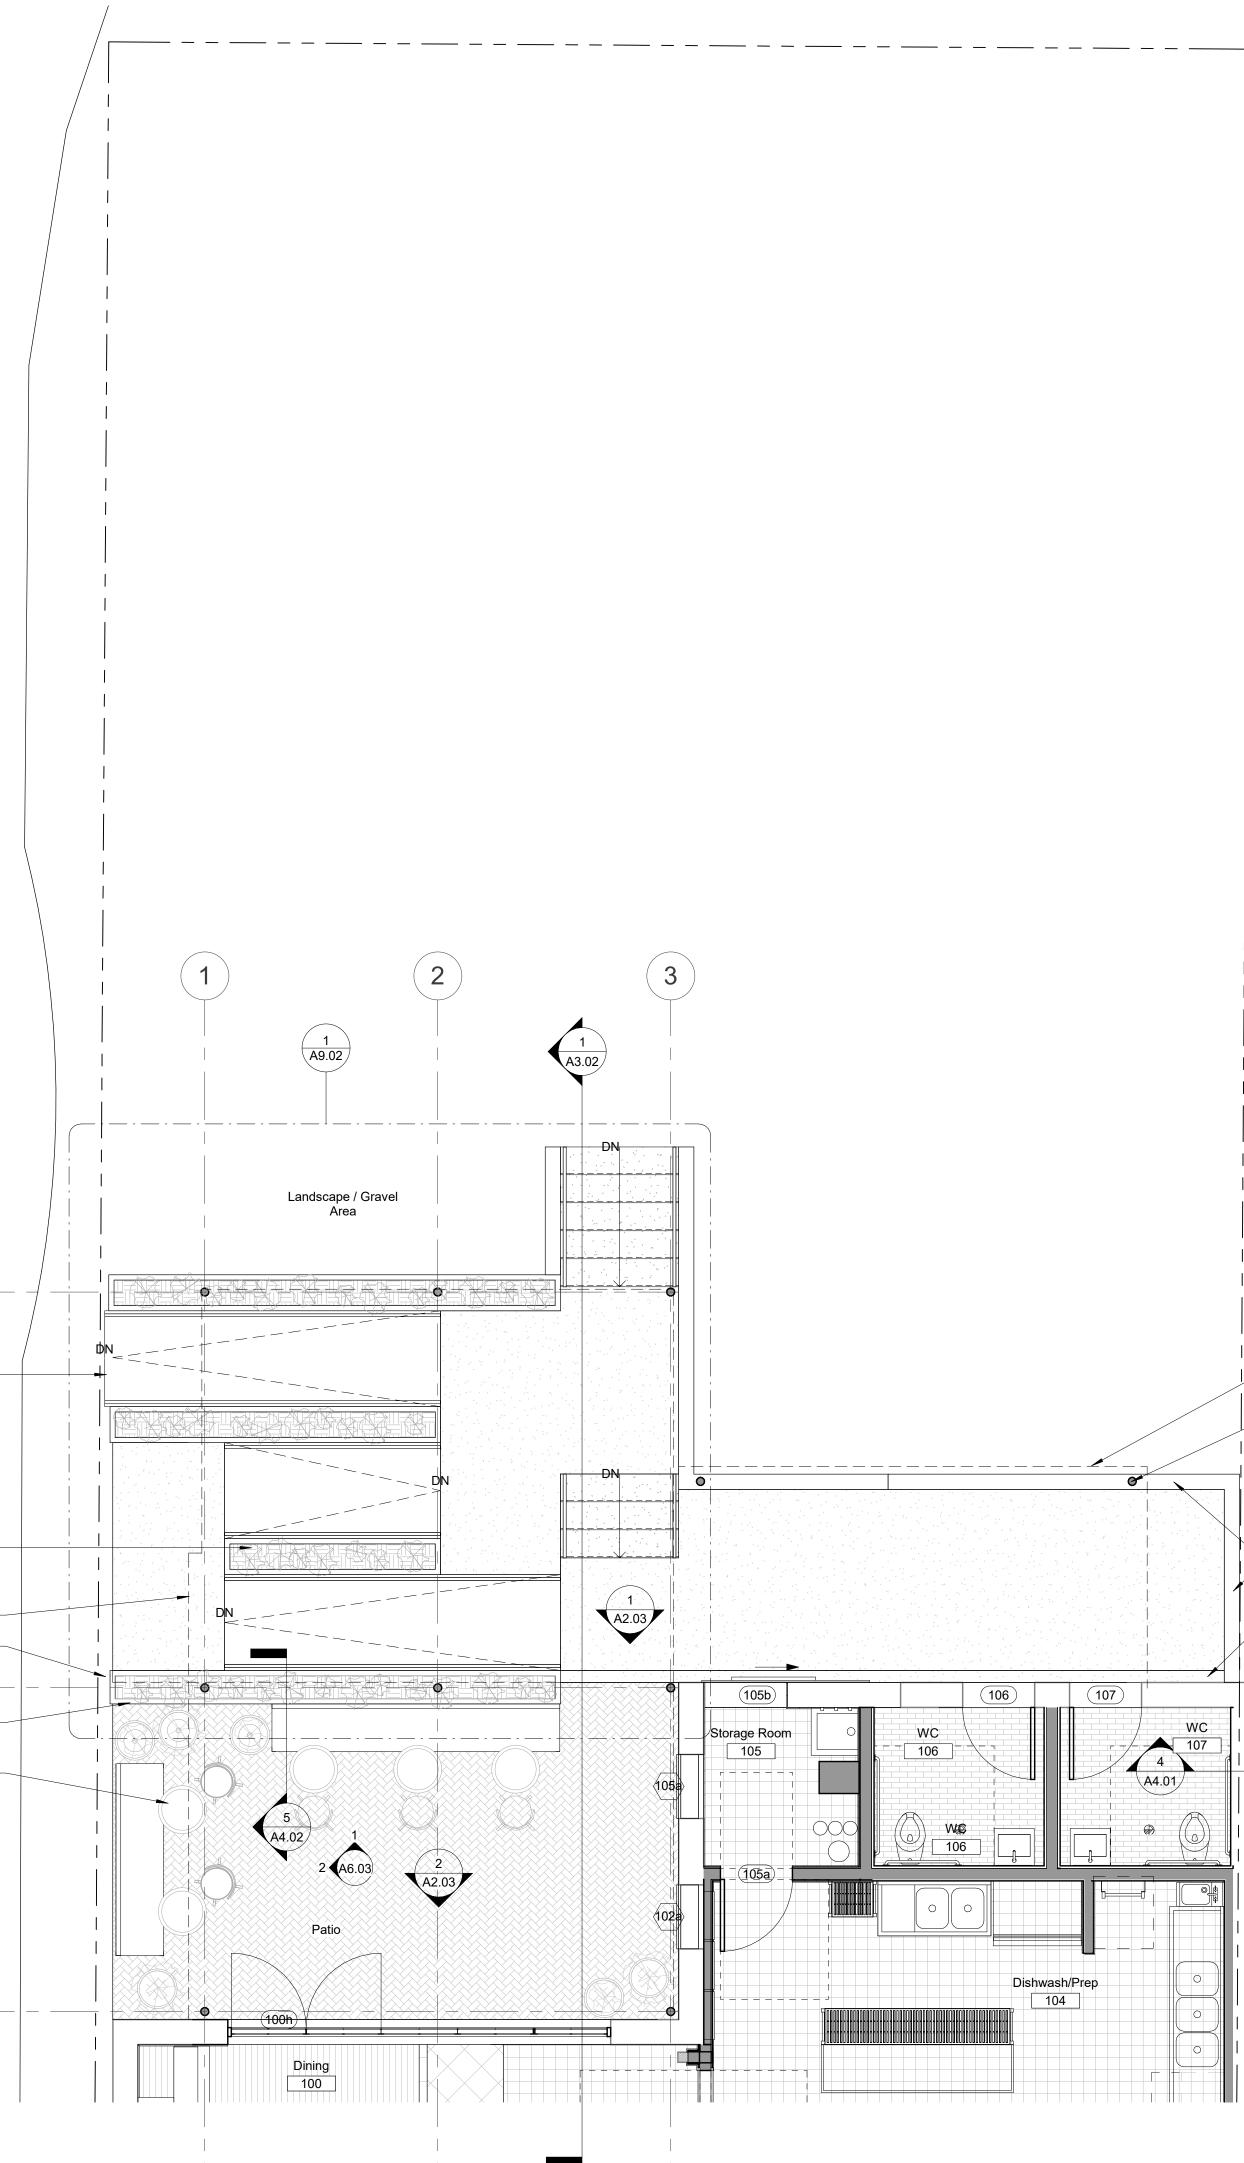
- 09.05

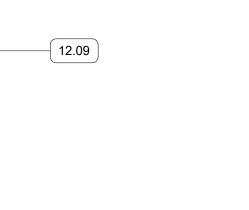Restore existing historic door and transom.
Build new reproduction door to match historic materials and detailing.
 02.12 Typ.



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	(C)	32.10
	B — –	32.01 00.04 22.10 32.09 12.01
	(A)	



**1** Patio Floor Plan  $\frac{1}{1/4" = 1'-0"}$ 




- 1. The dimensions on this sheet are to face of stud and/or masonry, centerline of column/beam, and face of awning, unless noted
- otherwise. 2. GC to field verify all dimensions prior to construction and/or
- installation of any equipment, accessories, etc. If a discrepancy is identified, please notify MHOA immediately. 3. GC to verify final locations for fire extinguishers with fire marshal and architect prior to installation.
- Refer to appropriate sheet and/or schedule for additional 4.
- information/detail regarding items shown herein. Do not scale the drawings. If a specific dimension is not given, 5.
- contact MHOA for clarification. 6.
- GC is responsible for protecting and repairing additional damage arising during both demolition phase and new construction phase on existing partitions, finishes, and building elements that are to remain.
- 7. GC to provide portable fire extinguishers per International Fire Code Section 906 and/or local fire code and coordinate a final review of counts and locations with the local fire marshal/inspector. 8. Refer to General Requirements for additional information associated with, but not limited to: submittals, shop drawings, samples, cutting and patching, coordination and staging, protection

## FLOOR PLAN KEYNOTES

00.04 Line of roof above.

of work.

- 05.01 New steel column, refer to Structural.
- 12.01 Furniture by Owner. NIC. 22.09 Trench drain w/ ADA compliant cover per MEP.
- 22.10 Trench drain outlet, refer to Civil and MEP.
- 31.03 Retaining wall, per Civil.
- 32.01 Plantings, refer to Landscape Architect. 32.09 Stucco planter box, refer to Landscape.
- 32.10 Align ramp with existing sidewalk at R.O.W. Refer to Civil.

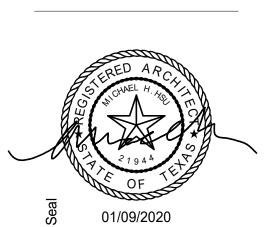



Drawing Title

Patio Annotation Plan Sheet

00.04

05.01


- 31.03

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# **ELEVATION & SECTION GENERAL NOTES**

Contractor (GC) to field verify all dimensions prior to construction and/or installation of any equipment, accessories, etc. If a discrepancy is identified, notify MHOA immediately. Elevations and building sections are shown for reference only.

Refer to Building Plans, Wall Sections and Window Elevations for additional information. Do not scale the drawings. If a specific dimension is not given,

contact MHOA for clarification. Refer to General Requirements for additional information

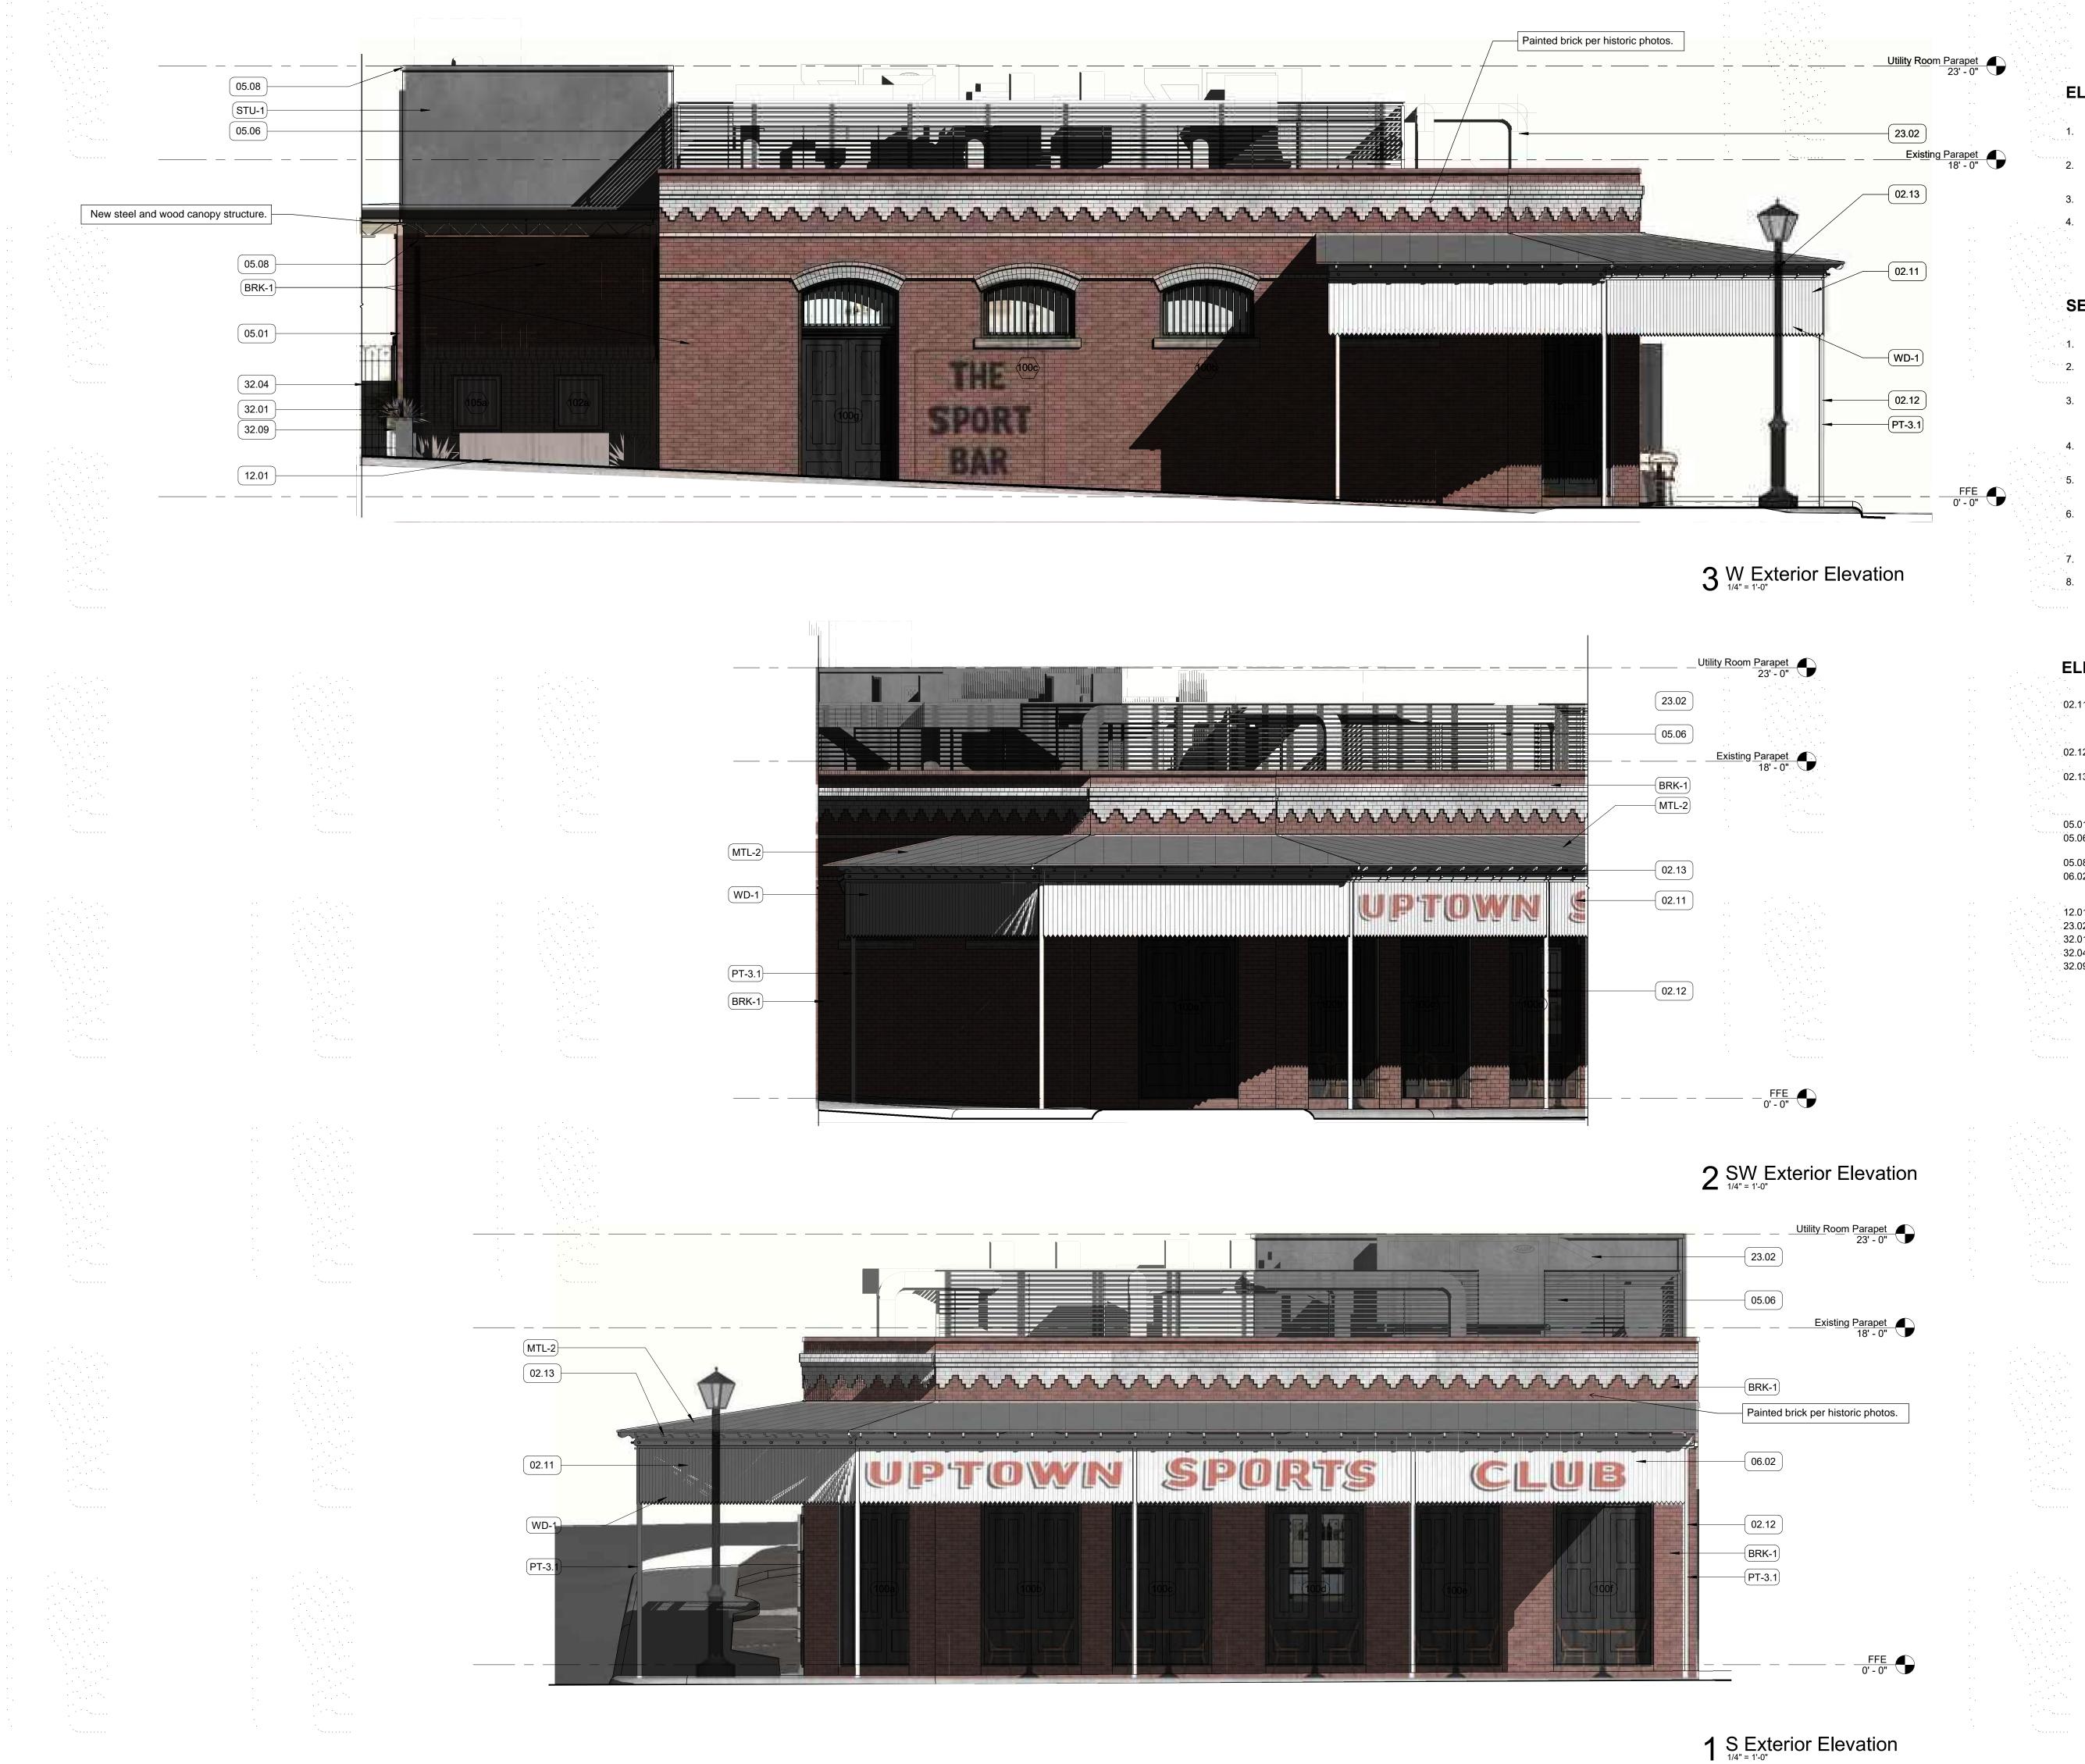associated with, but not limited to: submittals, shop drawings, samples, cutting and patching, coordination and staging, protection of work.

# SECRETARY OF INTERIOR GENERAL NOTES

Clean masonry only when necessary to halt deterioration or remove heavy soiling with the gentlest method possible Avoid using a cleaning or paint-removal method that involves water or liquid chemical solutions when there is any possibility or freezing temperatures.

Remove damaged or deteriorated paint only to the next sound layer using the gentlest method possible prior to repainting or refinishing surfaces using compatible paint or other coating systems.

Avoid removing paint that is firmly adhered to masonry and/or wood surfaces unless the building was upainted historically and the paint can be removed without damaging the surface. Avoid stripping paint or other coatings to reveal bare wood, thereby exposing historically-coated surfaces to the effects of accelerated weathering.

Apply compatible paint coating systems to historically-painted masonry following proper surface preparation. Repaint historicallypainted features with colors appropriate to the historic character or the building.

When repointing mortar, avoid removing non-deteriorated mortar from sound joints. Refer to The Secretary of the Interior's Standards for the

Treatment of Historic Properties: https://www.nps.gov/tps/standards/treatment-guidelines-2017.pdf

# **ELEVATION & SECTION KEYNOTES**

02.11 Existing wood sign band structure. Restore to match existing where needed. Finish in PT-1.1/PT1.2, refer to Finish Schedule and historic photos. Refer to Secretary of Interior notes for restoration and cleaning guidelines.

02.12 Existing exterior steel column. Finish in PT-3.1, refer to Finish Schedule.

02.13 Existing wood rafter w/ decorative end. Restore to match existing where needed. Finish in PT-1.1, refer to Finish Schedule. Refer to Secretary of Interior notes for restoration and cleaning guidelines.

05.01 New steel column, refer to Structural.

05.06 Steel 42" guardrail at existing parapet. See exterior details. Submit shop drawings for Architect approval. 05.08 New prefinished metal parapet cap. Finish TBD by Architect.

06.02 Restore wood canopy structure to match existing. Finish in PT-2, refer to Finish Schedule. See Secretary of Interior notes for restoration guidelines.

12.01 Furniture by Owner. NIC. 23.02 Mechanical Equipment per MEP. 32.01 Plantings, refer to Landscape Architect.


32.04 Retaining wall, refer to Civil. 32.09 Stucco planter box, refer to Landscape.






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Exterior Elevations Sheet A2.01 Copyright © 2019 Michael Hsu Office of

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## **ELEVATION & SECTION GENERAL NOTES**
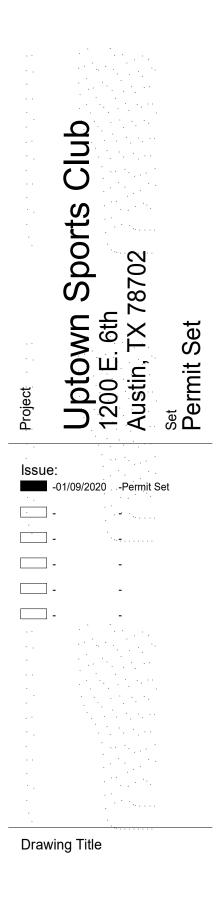
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- from sound joints. Refer to The Secretary of the Interior's Standards for the

Treatment of Historic Properties: https://www.nps.gov/tps/standards/treatment-guidelines-2017.pdf

### **ELEVATION & SECTION KEYNOTES**

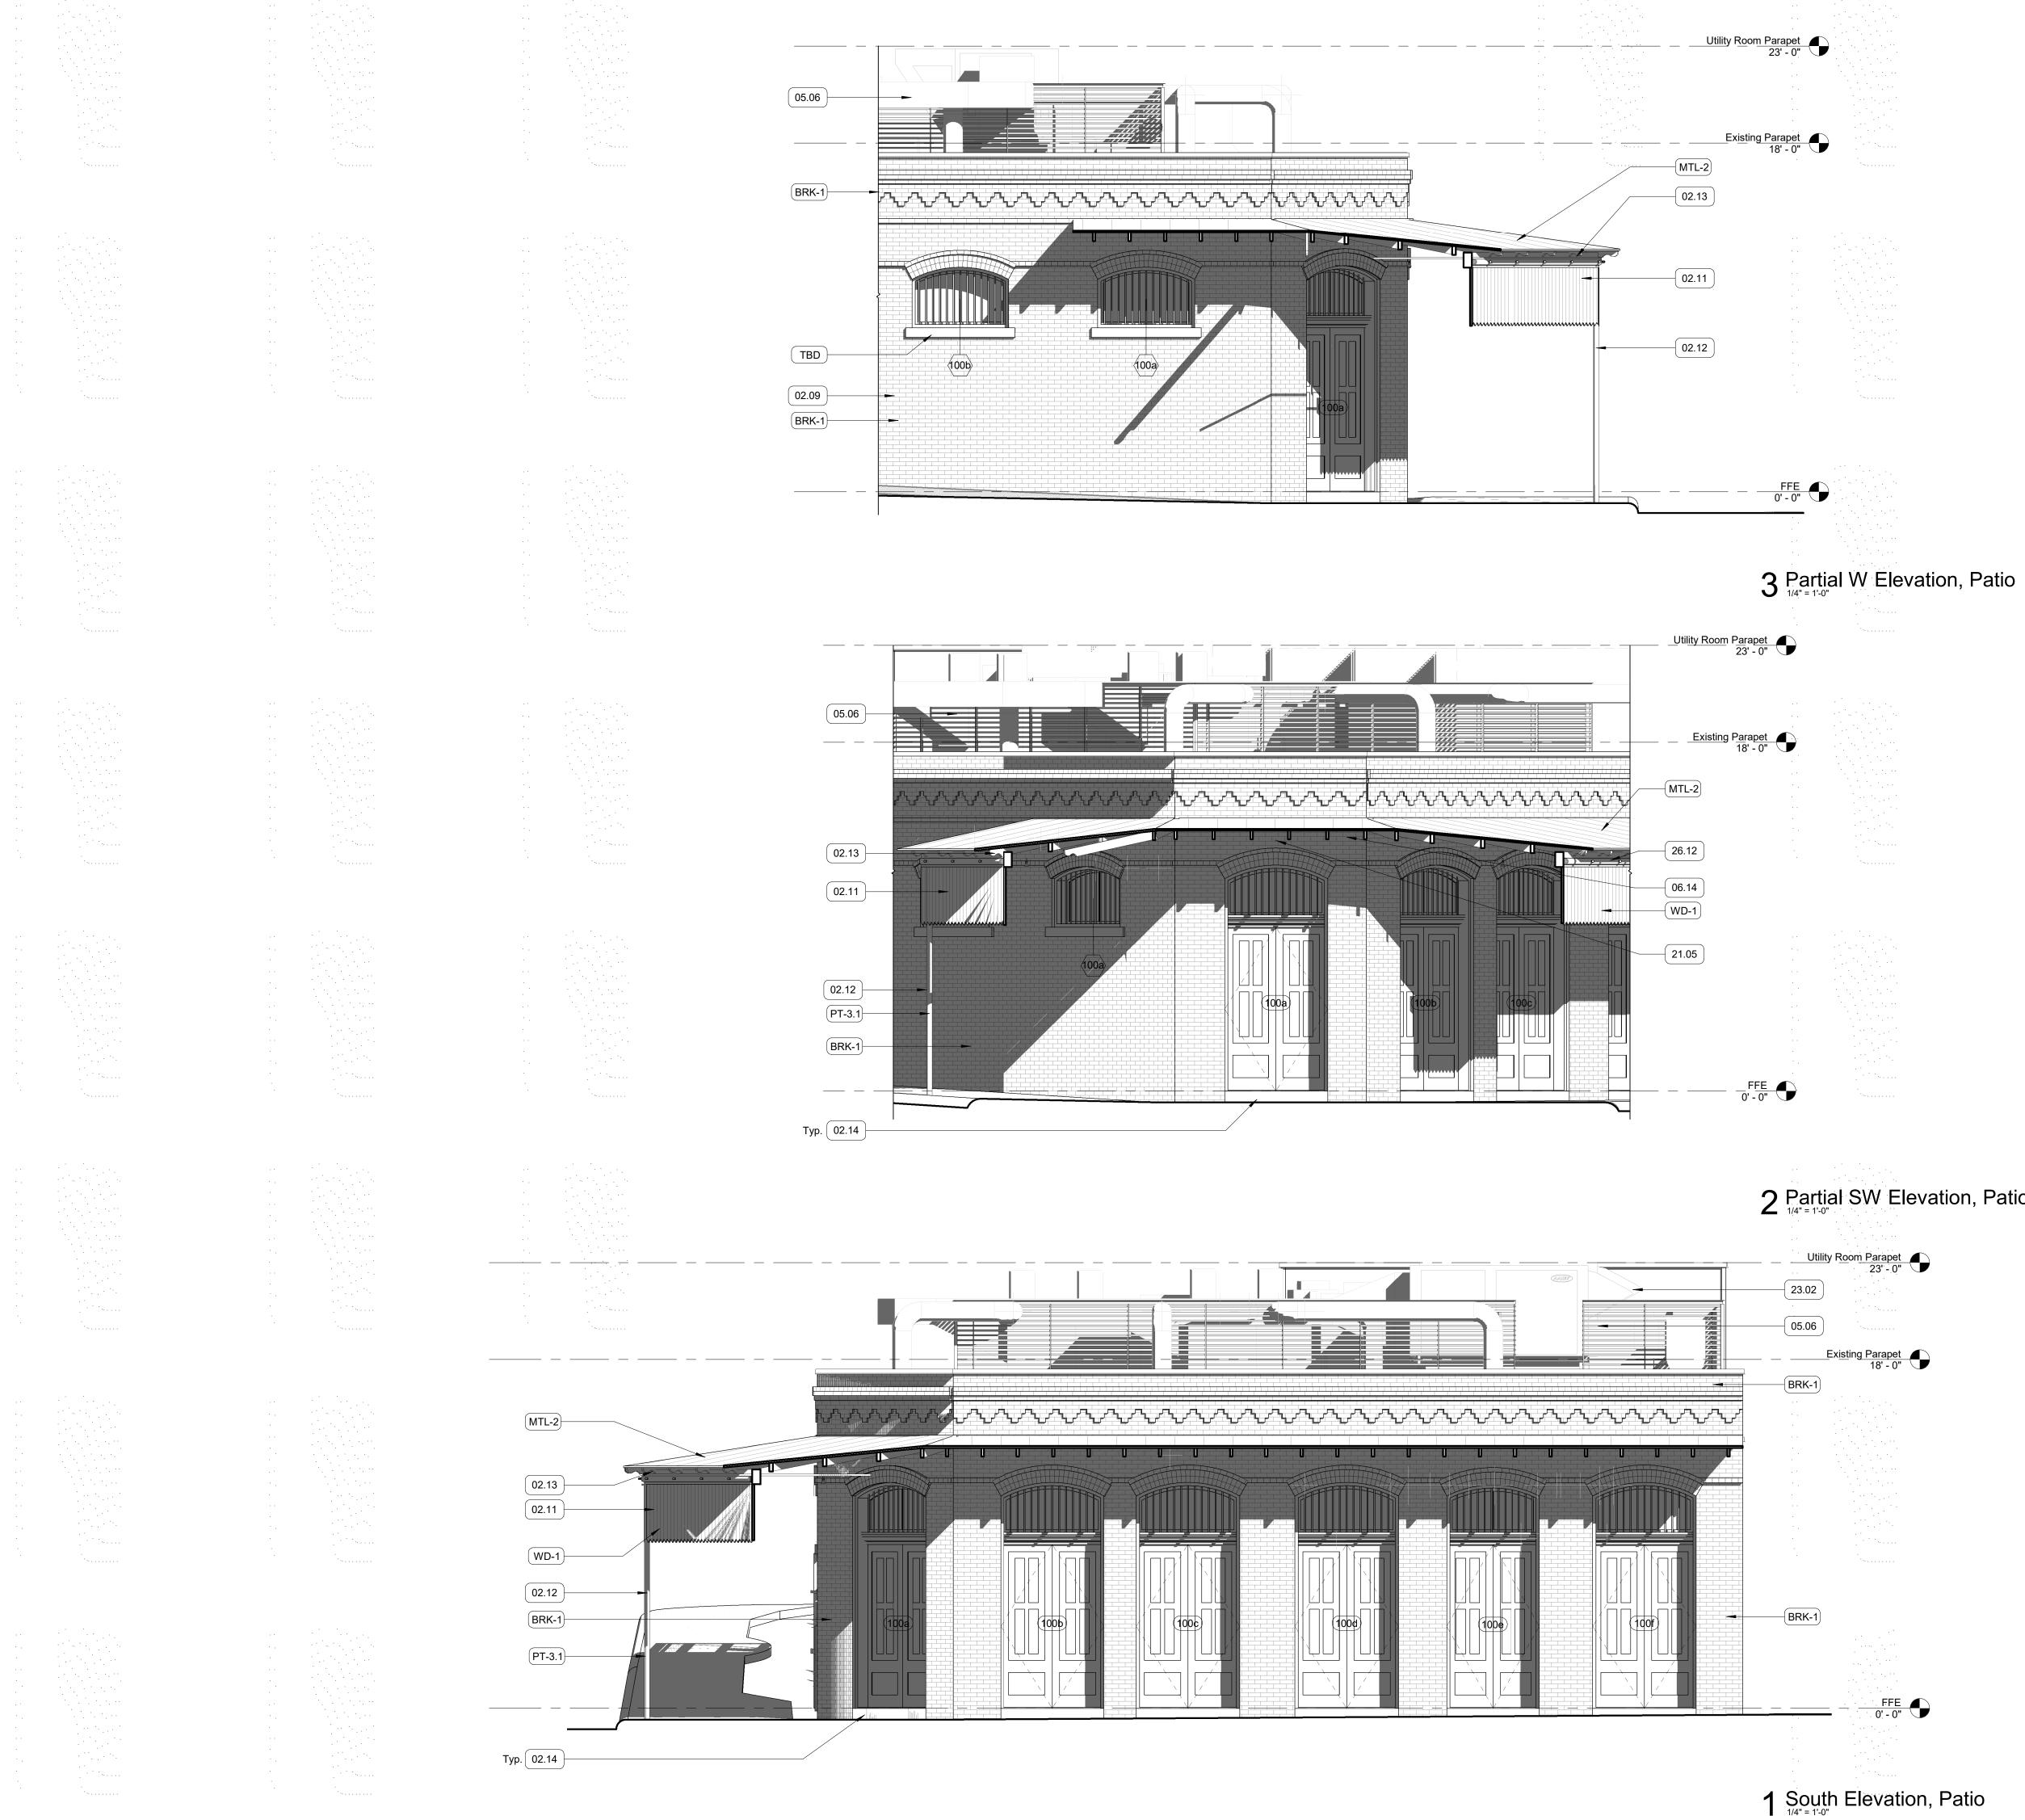02.09 Existing brick. Finish in PT-2.1/PT-2.2. Refer to Finish Schedule and historic photos. Refer to Secretary of Interior notes for restoration and cleaning guidelines.

02.11 Existing wood sign band structure. Restore to match existing where needed. Finish in PT-1.1/PT1.2, refer to Finish Schedule and historic photos. Refer to Secretary of Interior notes for restoration and cleaning guidelines.

02.12 Existing exterior steel column. Finish in PT-3.1, refer to Finish Schedule.

02.13 Existing wood rafter w/ decorative end. Restore to match existing where needed. Finish in PT-1.1, refer to Finish Schedule. Refer to Secretary of Interior notes for restoration and cleaning guidelines.

02.14 Existing limestone sill to remain as is, STN-1. Refer to Secretary of Interior notes for restoration and cleaning guidelines. 05.06 Steel 42" guardrail at existing parapet. See exterior details.


Submit shop drawings for Architect approval. 06.14 New ledger to match existing, refer to Structural. Finish in PT-2, refer to Finish Schedule. 21.05 Sidewall sprinkler head, refer to MEP

23.02 Mechanical Equipment per MEP. 26.12 Restore existing marquee lights to service.


		20.12	Receive existing marquee	iigiito t	5 001 1100.
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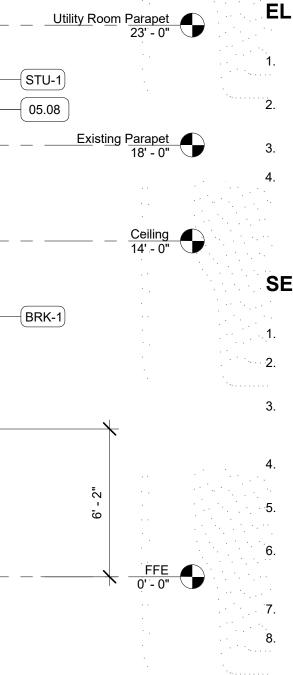
Drawing Title



Architecture

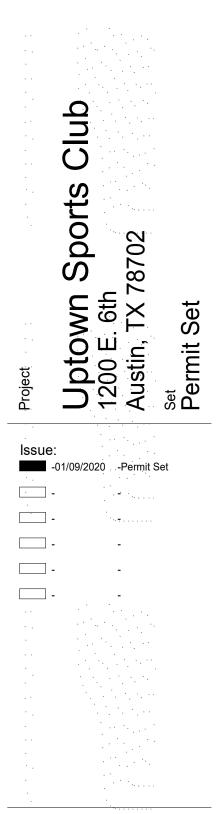

1 North Exterior Elevation

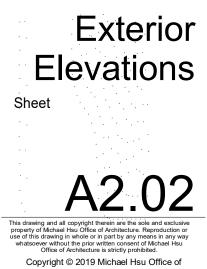

Utility Room Parapet 23' - 0"

Existing Parapet 18' - 0"

# **ELEVATION & SECTION GENERAL NOTES**

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### **ELEVATION & SECTION KEYNOTES**

02.09 Existing brick. Finish in PT-2.1/PT-2.2. Refer to Finish Schedule

and historic photos. Refer to Secretary of Interior notes for restoration and cleaning guidelines. 02.11 Existing wood sign band structure. Restore to match existing

where needed. Finish in PT-1.1/PT1.2, refer to Finish Schedule and historic photos. Refer to Secretary of Interior notes for restoration and cleaning guidelines.

02.12 Existing exterior steel column. Finish in PT-3.1, refer to Finish Schedule.

05.01 New steel column, refer to Structural. 05.06 Steel 42" guardrail at existing parapet. See exterior details. Submit shop drawings for Architect approval.

05.08 New prefinished metal parapet cap. Finish TBD by Architect. 05.14 Replace metal standing seam roof to match historic description. Refer to Secretary of Interior notes for restoration guidelines.

07.02 Existing scupper to remain. Rebuild and connect to new downspout. 08.09 Custom storefront per Window Schedule. See Door & Window

Details.

12.01 Furniture by Owner. NIC. 23.02 Mechanical Equipment per MEP.


23.08 Roof-mounted mechanical ductwork per MEP. Equipment is to be painted, color TBD.


26.12 Restore existing marquee lights to service.

26.16 Radiant heater per Fixture Schedule.


32.01 Plantings, refer to Landscape Architect. 32.04 Retaining wall, refer to Civil.

32.09 Stucco planter box, refer to Landscape.

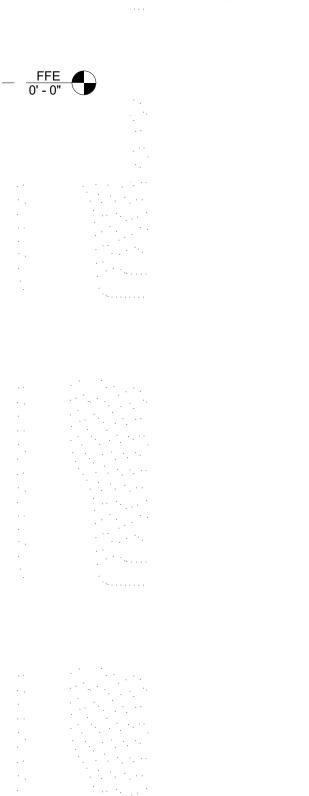

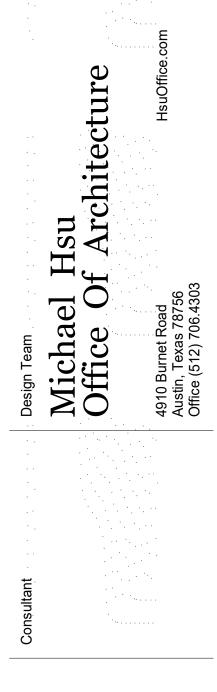



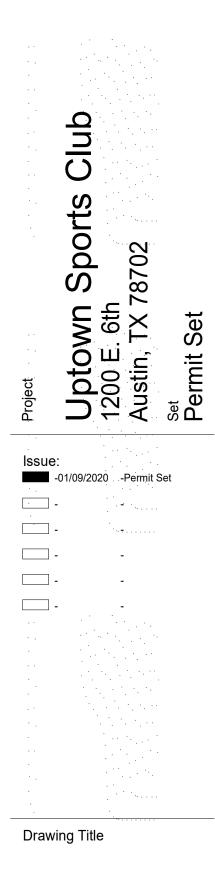


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Architecture



S Elevation at E 6th St

Intersection at E 6th St x Waller

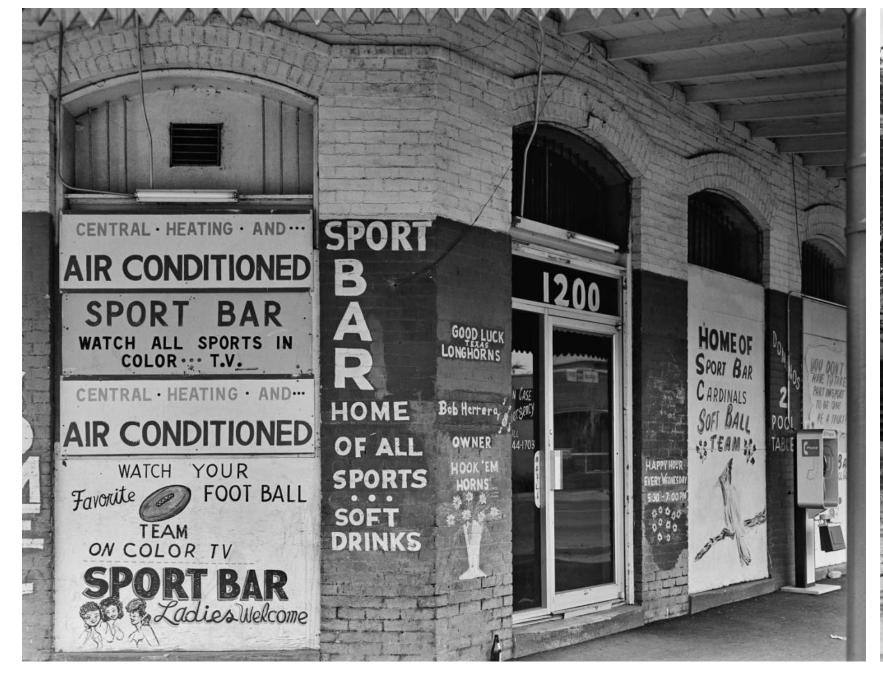

Storefront Added

Mural along Waller

Interior, Butcher Shop






Backyard Addition

Painted Brick Detail

# Photographs - Existing Conditions



W Elevation at Waller

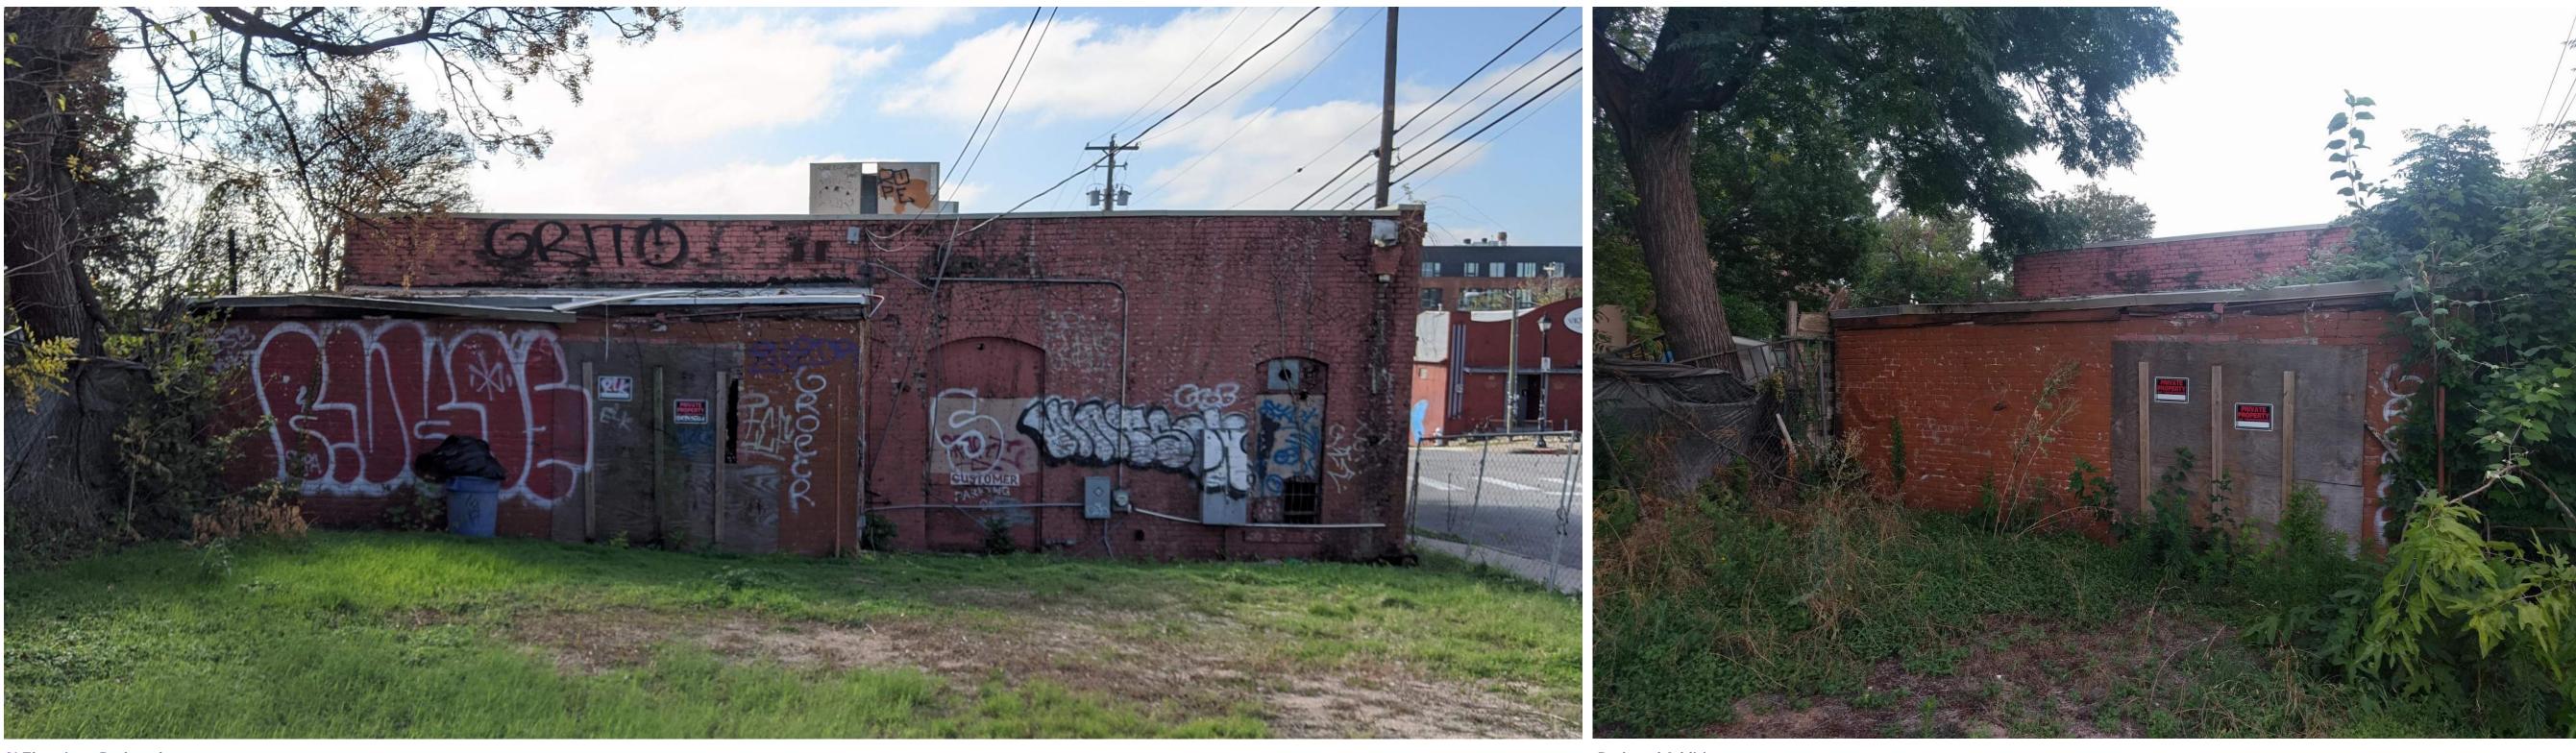

N Elevation - Backyard

S Elevation at E 6th St

Backyard Addition



Existing Door to be Restored, Typ.

Existing Door to be Replaced to Match Historic Photos



Interior View of Doors & Entry

Sidewalk at Waller

Interior View of Former Archway

Existing Wood Awning to be Restored