



Project: Littlefield Building Address: 106 E 6th Street 90 Day Removal Plan for Awnings

ENGINEERING & SURVEYING						
Proposed Schedule Duration					Week of:	
ID	Task	Duration	Start Date	End Date	6-Oct 13-Oct 20-Oct 27-Oct	3-Nov 10-Nov 17-Nov
1	Acquire ROW Permit	7 weeks	Mon 10/07/20	Wed 11/20/20		
2	Demolition Preparation	3 weeks	Mon 10/28/20	Sat 11/16/20	—	
3	Job Duration	5 days	Wed 11/13/20	Mon 11/18/20		
4	Mobilize and Protect Work Area	1 day	Wed 11/13/20	Wed 11/13/20		
5	Set Lane Closure and Barrier Devices	1 day	Wed 11/13/20	Wed 11/13/20		
6	Set Crane	1 day	Wed 11/13/20	Wed 11/13/20		
7	Detach and Remove Awnings	4 days	Wed 11/13/20	Sun 11/17/20		
8	Load and Haul Awnings	4 days	Wed 11/13/20	Sun 11/17/20		
9	Demobilize Crane	1 day	Mon 11/18/20	Mon 11/18/20		
10	Remove Lane Closure Barrier Devices	1 day	Mon 11/18/20	Mon 11/18/20		
11	Open Lanes to Traffic	1 day	Mon 11/18/20	Mon 11/18/20		
** Dates listed above are for reference only in order to show a ninety (90) day removal plan.						

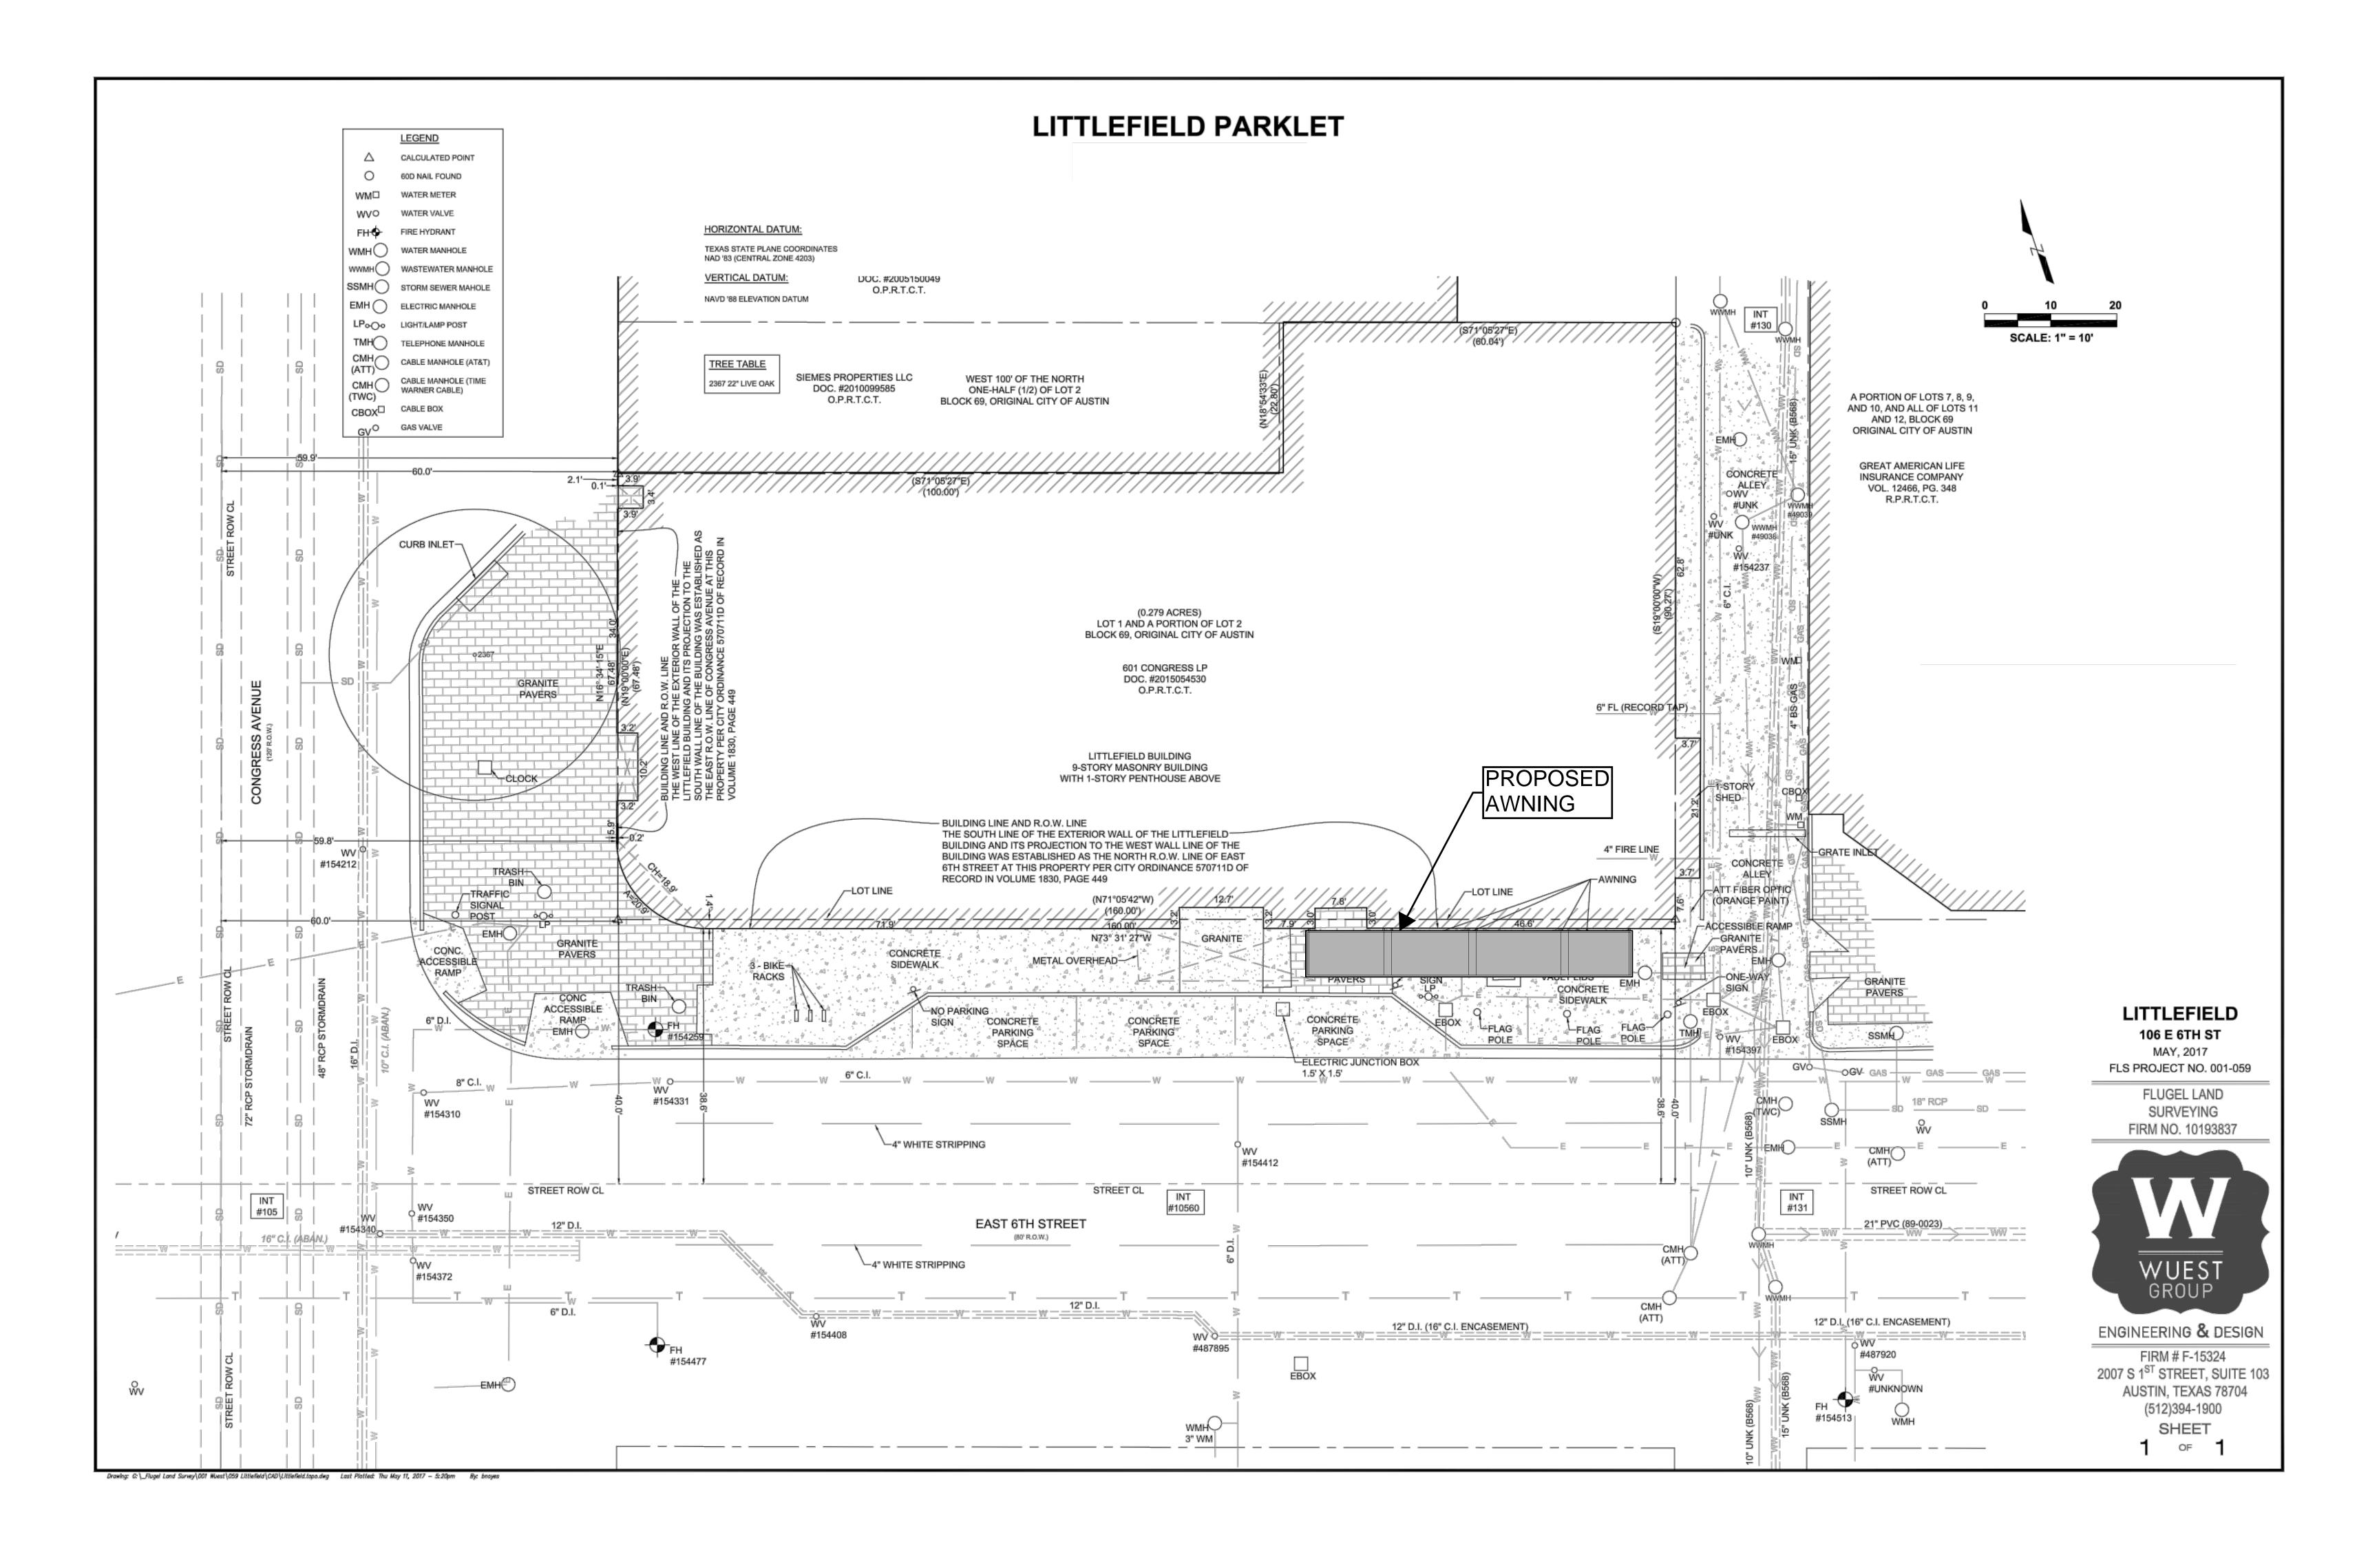

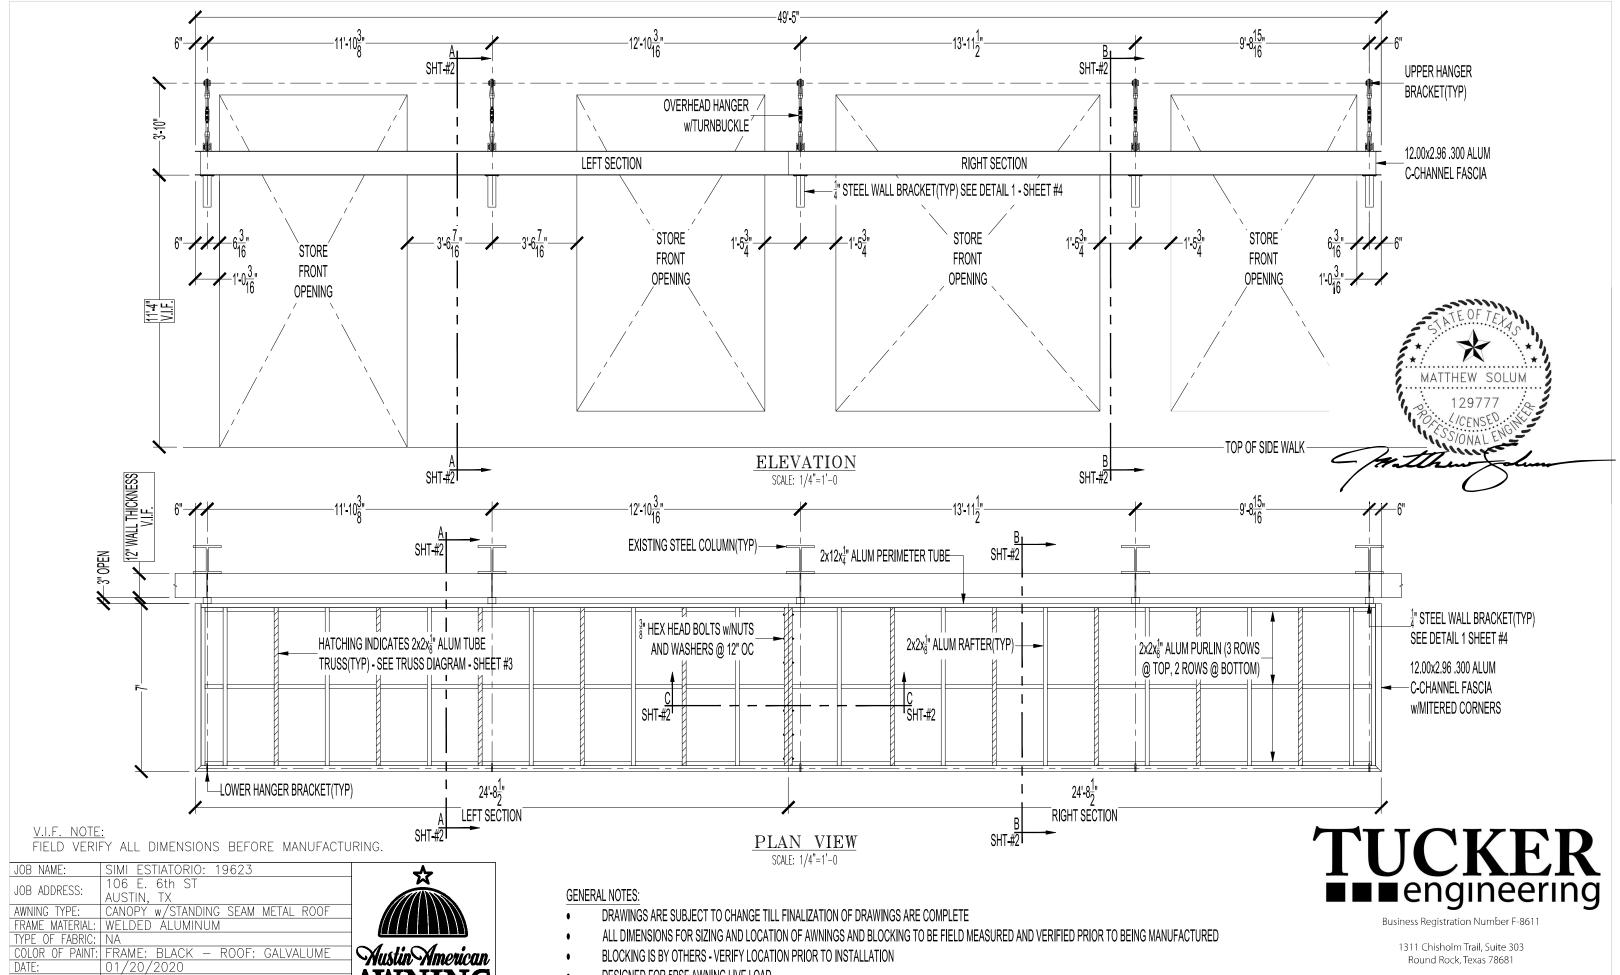

EET #: #1 of 4

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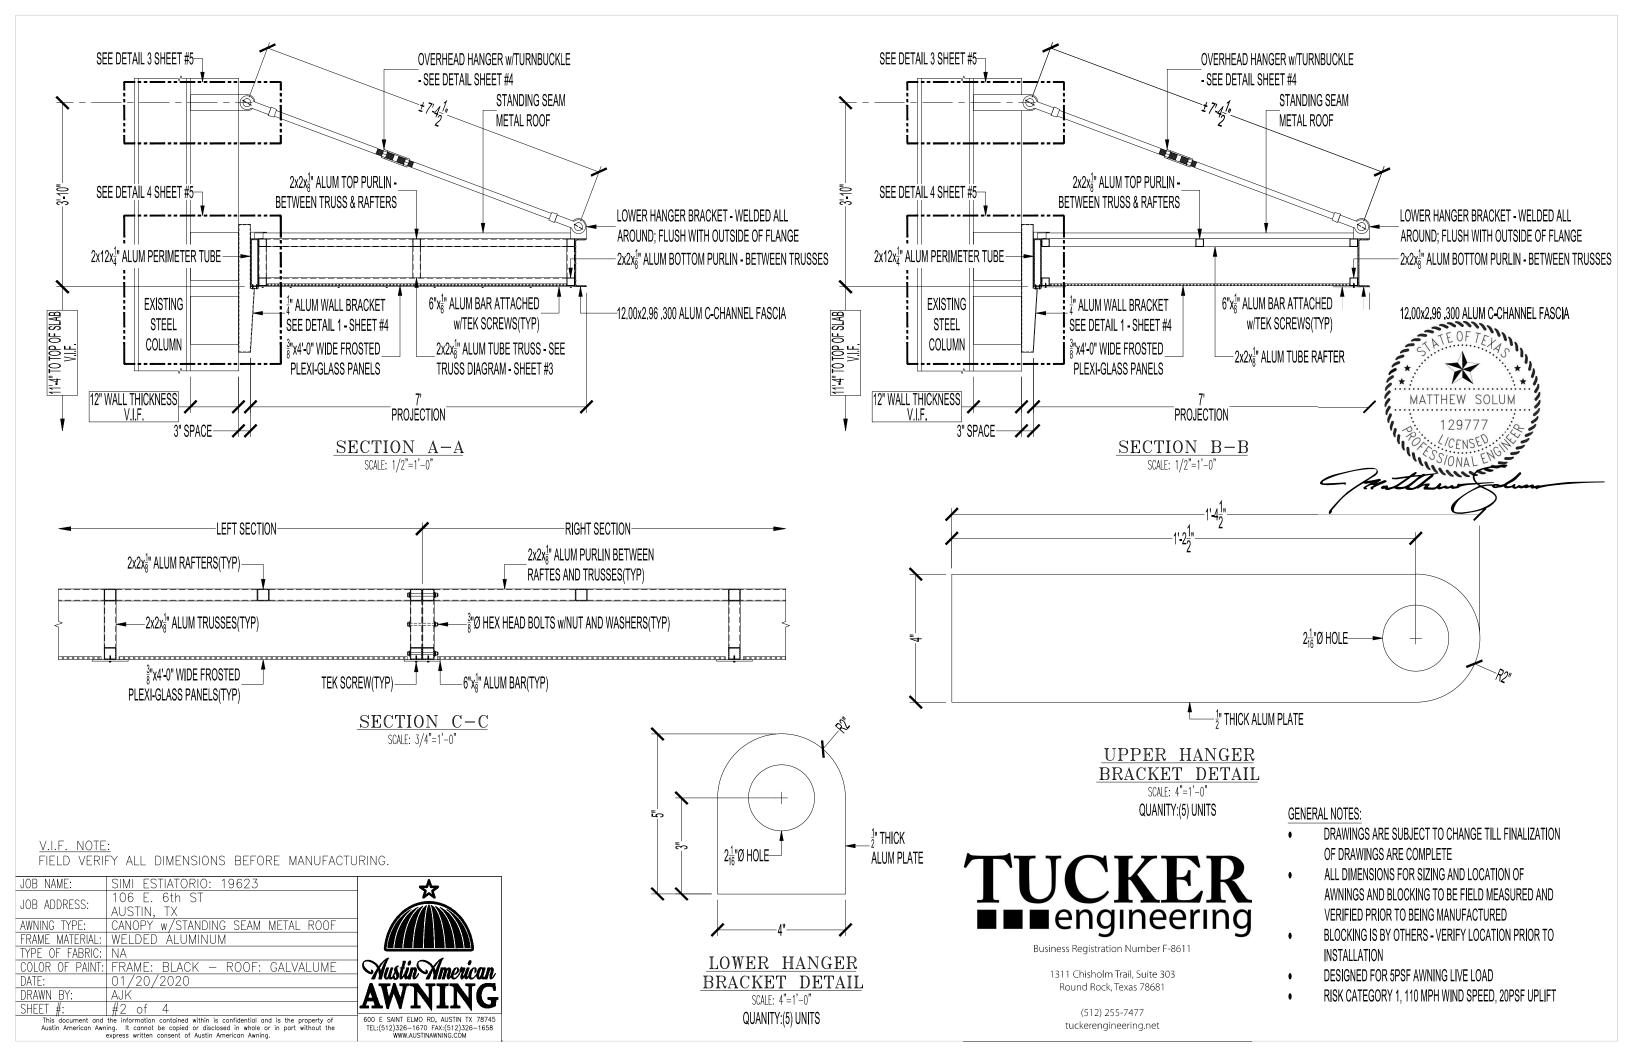
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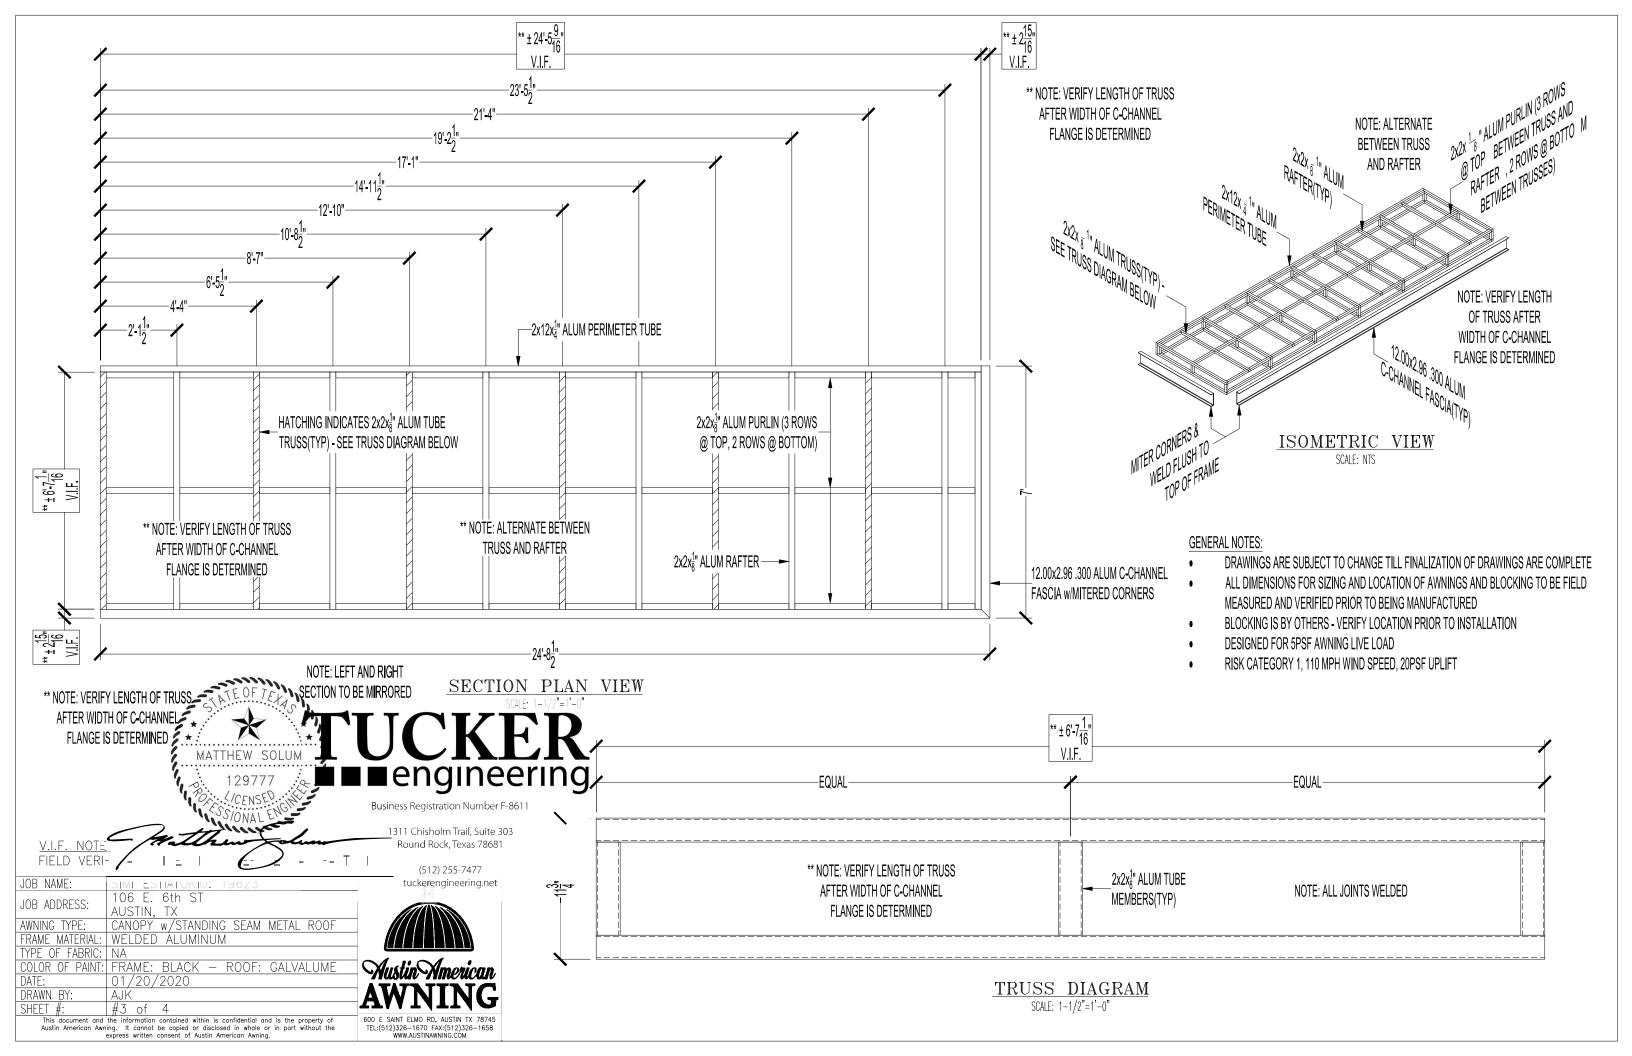
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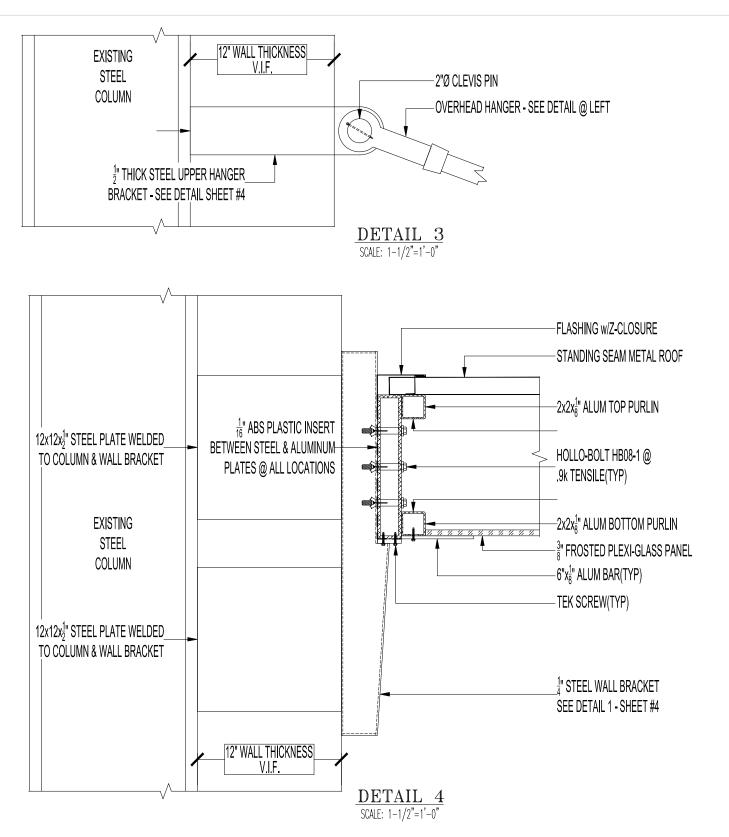
600 E SAINT ELMO RD, AUSTIN TX 78745 TEL:(512)326-1670 FAX:(512)326-1658 WWW.AUSTINAWNING.COM


- DESIGNED FOR 5PSF AWNING LIVE LOAD
- RISK CATEGORY 1, 110 MPH WIND SPEED, 20PSF UPLIFT


(512) 255-7477 tuckerengineering.net







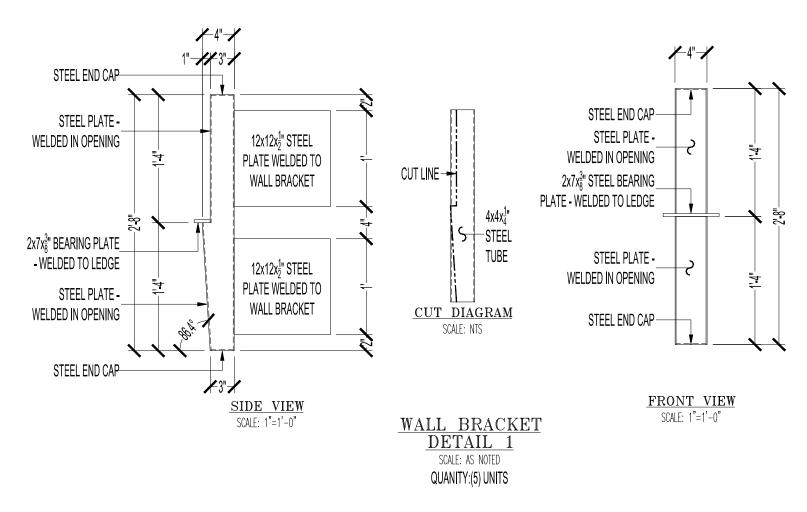

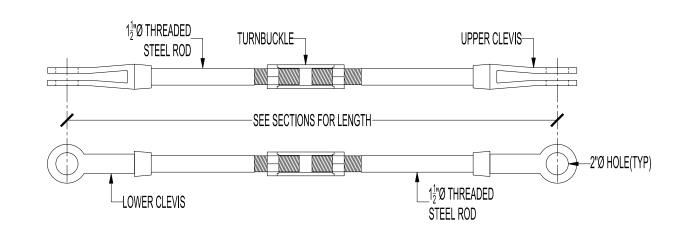

SCALE: NTS

V.I.F. NOTE: FIELD VERIFY ALL DIMENSIONS BEFORE MANUFACTURING.

JOB NAME:	SIMI ESTIATORIO: 19623	~
JOB ADDRESS:	106 E. 6th ST	M M
JUD ADDRESS.	AUSTIN, TX	
AWNING TYPE:	CANOPY w/STANDING SEAM METAL ROOF	///////////////////////////////////////
FRAME MATERIAL:	WELDED ÁLUMINUM	<i> </i>
TYPE OF FABRIC:	NA	
COLOR OF PAINT:	FRAME: BLACK - ROOF: GALVALUME	Mustin American
DATE:	01/20/2020	21000101
DRAWN BY:	AJŔ	AWNING
SHEET #:	#4 of 4	TTAATITIO
This document and	600 E SAINT ELMO RD, AUSTIN TX 78745 TEL:(512)326-1670 FAX:(512)326-1658	
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GENERAL NOTES:

- DRAWINGS ARE SUBJECT TO CHANGE TILL FINALIZATION OF DRAWINGS ARE COMPLETE
- ALL DIMENSIONS FOR SIZING AND LOCATION OF AWNINGS AND BLOCKING TO BE FIELD MEASURED AND VERIFIED PRIOR TO BEING MANUFACTURED
- BLOCKING IS BY OTHERS VERIFY LOCATION PRIOR TO INSTALLATION
- DESIGNED FOR 5PSF AWNING LIVE LOAD
- RISK CATEGORY 1, 110 MPH WIND SPEED, 20PSF UPLIFT





■engineering

Business Registration Number F-8611

1311 Chisholm Trail, Suite 303 Round Rock, Texas 78681

> (512) 255-7477 tuckerengineering.net

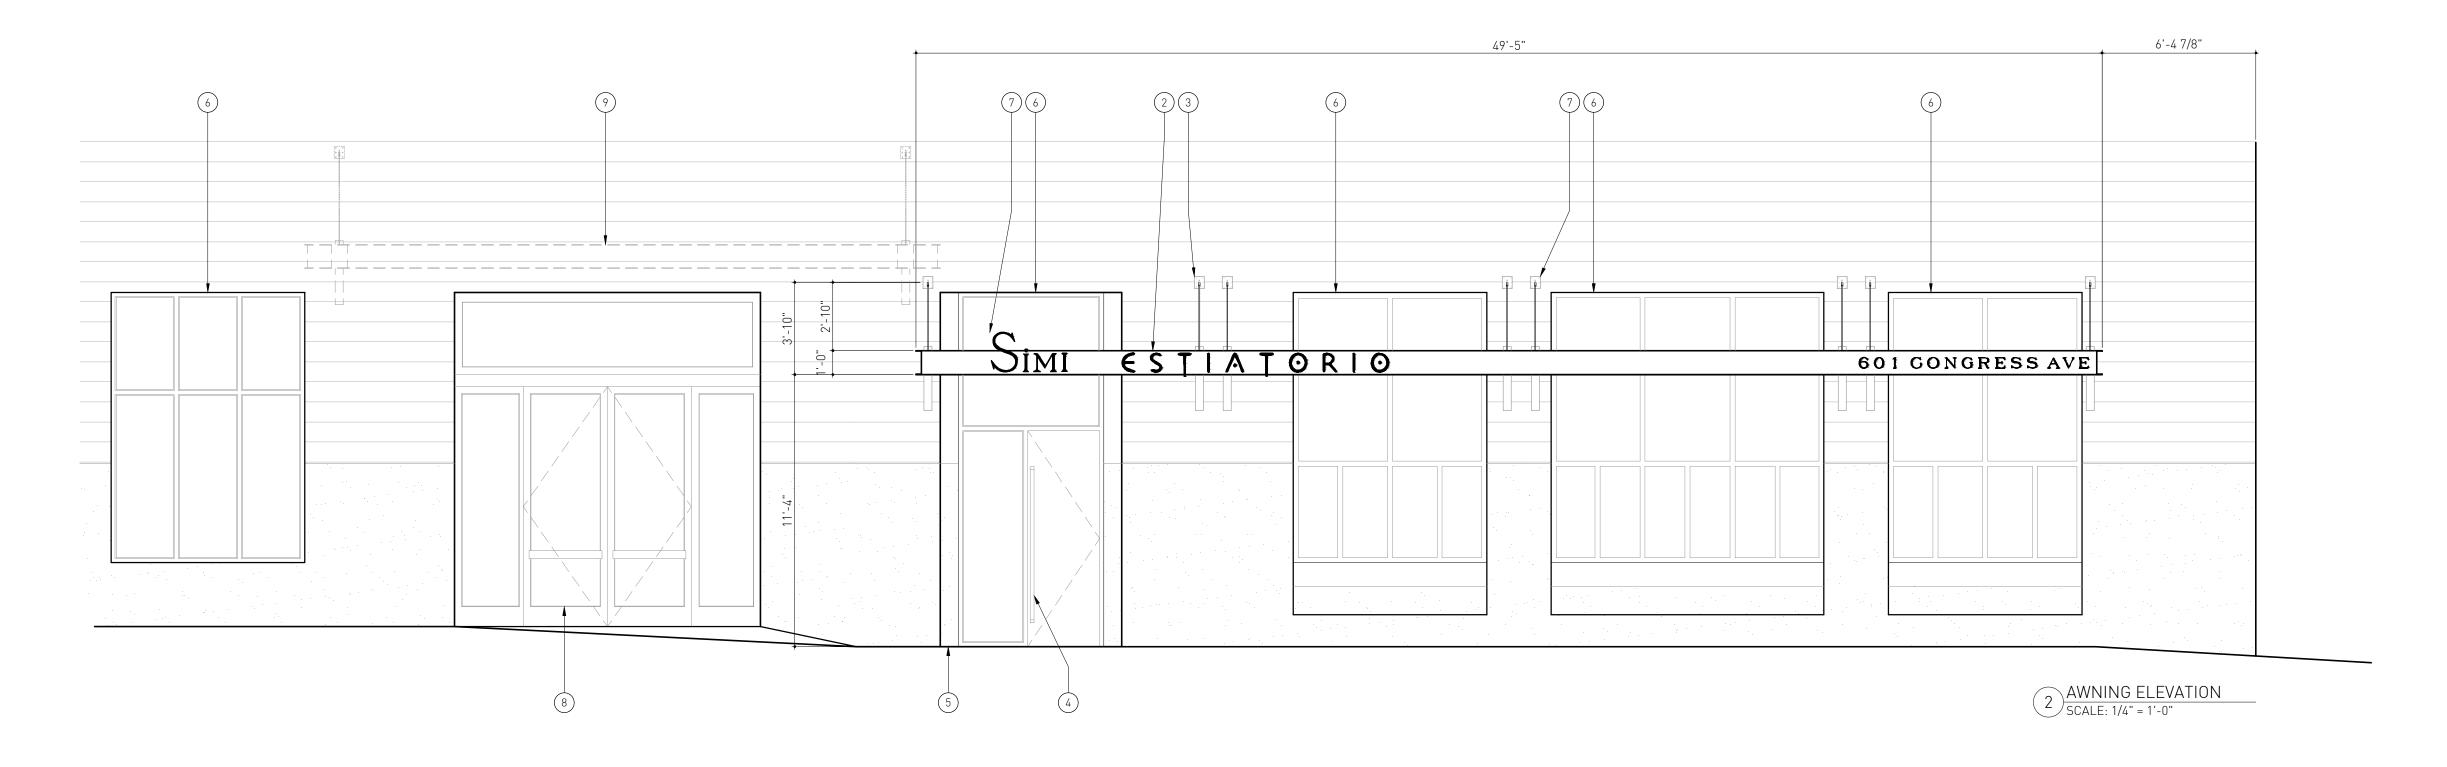

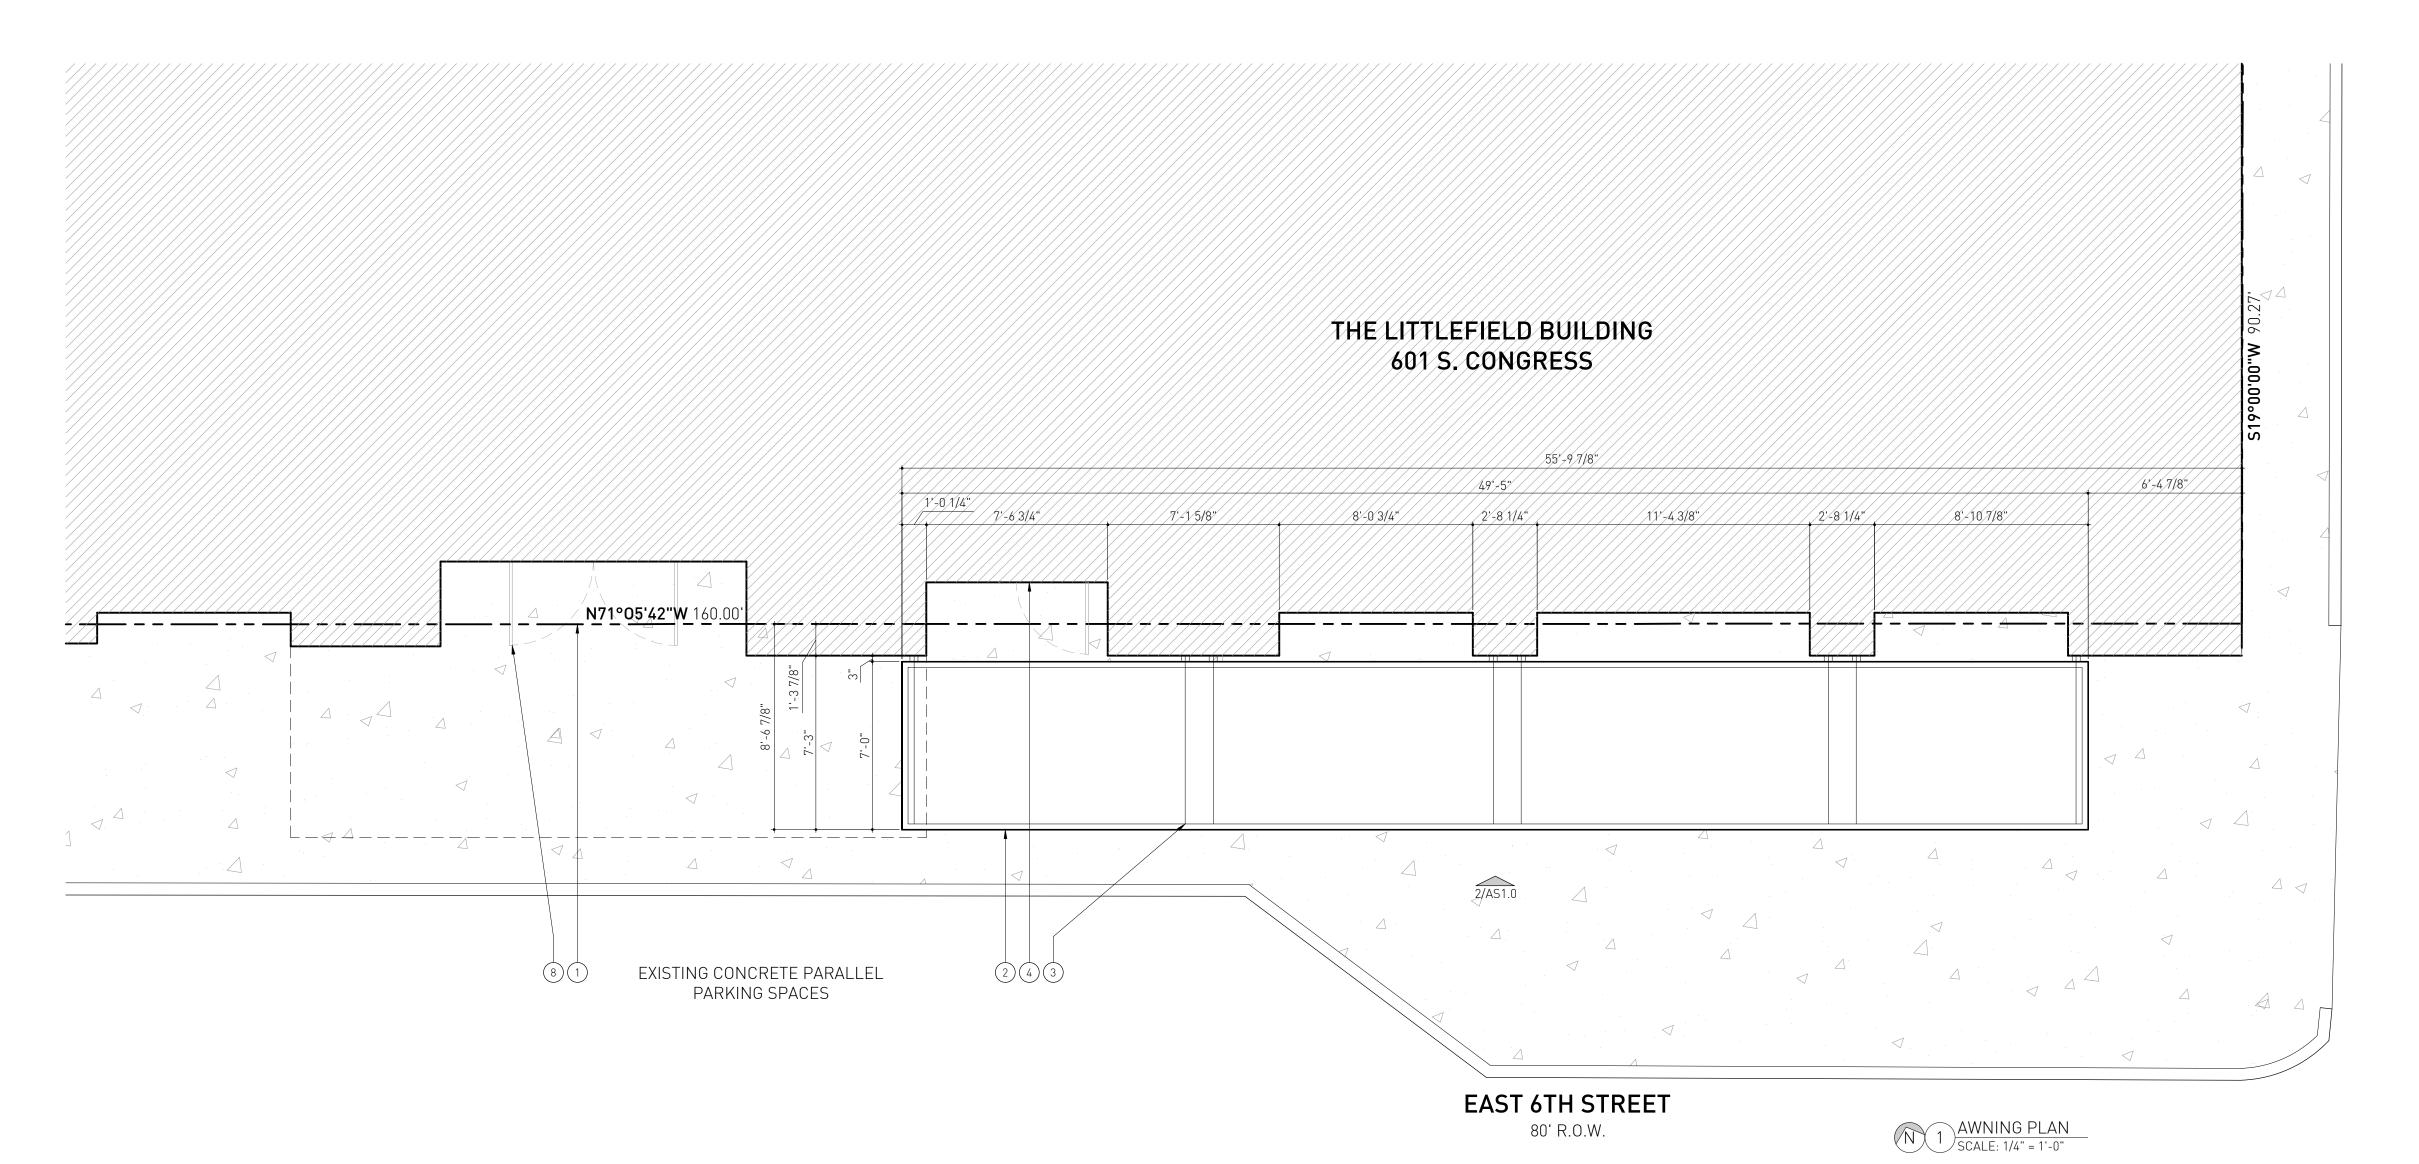

Architectural Site Plan & Awning Elevation General Notes:


- A. The dimensions on this sheet are based off of the face of finish material or masonry. All dimensions are to face of finish material, edge of awning, or centerline of support, unless otherwise noted.
- B. Contractor (GC) to field verify all dimensions prior to construction and/or installation of any equipment, accessories, etc. If a discrepancy is identified, notify NolanStudio immediately.
- C. Elevations are shown for reference only. Refer to Building Plans, Sections, Wall
- Sections and Window Elevations for additional information. D. All glass to be tempered in areas required by applicable code.
- E. Refer to appropriate sheet and/or schedule for additional information/detail regarding items shown herein.
- Keynotes located on this sheet are for this sheet only. G. Do not scale the drawings. If a specific dimension is not given, contact
- NolanStudio for clarification. H. Refer to Sheet A0.01-General Conditions for additional information associated with, but not limited to: submittals, shop drawings, samples, cutting and
- patching, coordination and staging, protection of work. I. Install all products per manufacturer's recommendations.

Architectural Site Plan & Awning Elevation Key Notes:

- Building mounted awning to match design of existing above entrance to building lobby. Coordinate with Building Owner for paint color & finish during construction.
- 3. Location, spacing, & size of overhead hanger and turn-buckle shown for reference only. Refer to Structural Drawings for specifications and layout.
- 4. Existing entrance to tenant space to remain. 5. Slope in existing sidewalk not shown here, vertical dimensions taken from
- installation for height above sidewalk. 6. Existing window to remain, cover and protect throughout construction process
- as necessary. 7. Sign mounted to face of awning structure by others, shown here for reference only, coordinate with Building Owner and Restaurant Tenant for power and

interior finish floor of restaurant tenancy, coordinate with Owner during

- lighting specifications. 8. Existing entrance to building lobby to remain.
- 9. Estimated location of existing awning shown for clarity only; verify in field as

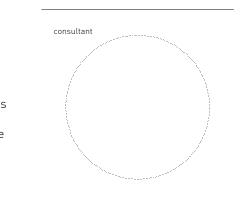

JANUARY 29, 2020

NOLAN


STUDIO

708 Rio Grande

Austin Texas 78701

512.330.4243

NOLAN-ARCHITECT.COM

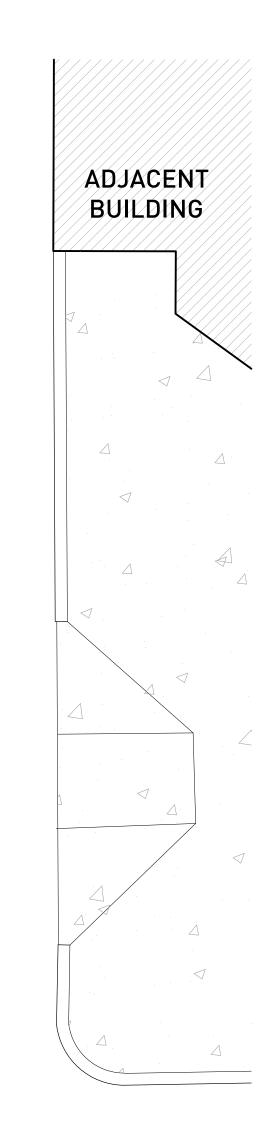

CITY OF AUSTIN

20' ALLEY

CONSTRUCTION SET

JANUARY 29, 2020

AWNING PLAN & ELEVATION

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