


SCALE: 1" = 10'-0"

15

1806 TRAVIS HEIGHTS BLVD

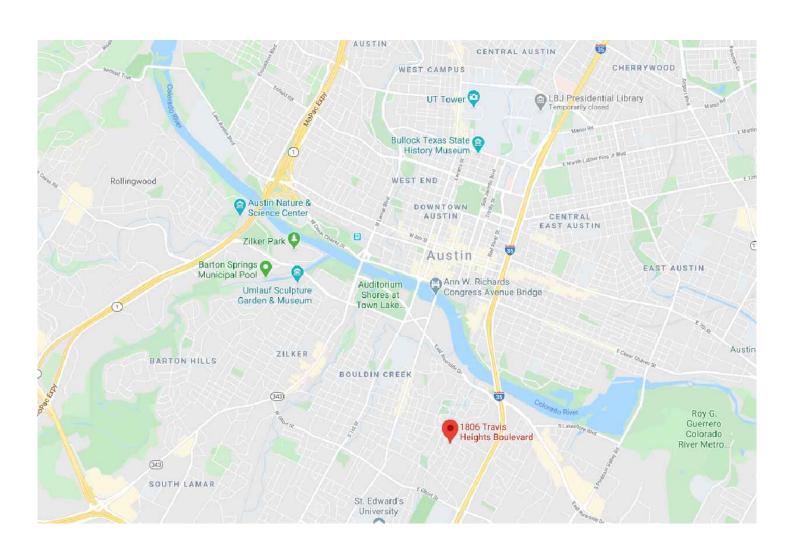

LOCATION MAP SCALE: N/A

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REMODEL/ADDITION

LEGAL DESCRIPTION: LOT 11 BLK 21 TRAVIS HEIGHTS

ZONING: SF-3-NP

PROJECT SUMMARY:

| TOTAL SITE: | 6,847 SF |
|---|----------------------------|
| REMODEL AREA: ADDITION AREA: NEW DECK (100%): | 708 SF |
| ZONING: WATERSHED: BLU FLOODPLAIN: | SF-3-NP NN CREEK NO |
| BUILDING AREA | |
| BLDG COVERAGE: New Bldg CVRG: | |
| ALLOWABLE FAR: | 2,739 SF |
| EXISTING FAR: EXISTING % FAR: | 1,160 SF 16.94 % |
| Proposed far: Proposed % far: | • |
| IMPERVIOUS COVER | <u>R</u> |
| ALLOWABLE I.C: | 3,081 SF |
| | 0 500 05 |

| EXISTING I.C. | 2,502 SF 36.54% |
|---|-----------------------------------|
| PROPOSED I.C. | <u>2,601 SF</u> 37.98 % |
| EXISTNG FOOTRPINT: ADTL. FOOTPRINT: CONC. DRIVE/STAIR NEW DECK 754SF@5 | 118 SF S: 636 SF |
| SET STONE WALL/ED EXISTING CONC. WA | GE 192 SF |

NEW IMPERVOUS: 2,601 SF

18 SF

2 AC PADS:

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NOTES:

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|-------|--------|

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| SP1 | EXIST/NEW SITEPLAN |
| SP2 | SITE AREA TOTALS |
| SP3 | FRONT YARD TOTALS |
| A.1.0 | DEMO PLAN |
| A1.1 | FLOOR PLANS |
| A1.2 | ROOF PLAN |
| A1.3 | FLOORING |
| A1.4 | CEILING MTRLS |
| A1.5 | LIGHTING |
| A1.6 | POWER |
| A1.7 | HVAC |
| A1.8 | WINDOWS |
| A1.7 | DOORS |
| A2.1 | EXTERIOR ELEVS |
| A2.2 | EXTERIOR ELEVS |
| A3.1 | INTERIOR ELEVS |
| A3.2 | INTERIOR ELEVS |
| A3.3 | INTERIOR ELEVS |
| A3.4 | INTERIOR ELEVS |
| A3.4 | INTERIOR ELEVS |
| A4,1 | INTERIOR ELEVS |
| 50.0 | STRUCTURAL NOTES |

SO.0 STRUCTURAL NOTES S1.0 FOUNDATION S1.1 2ND/ROOF FRAMING S2 DORMER FRAMING S3.0FRAMING DETAILSS4.0ROOF DETAILSS4.1TRUSS DETAILS \$5.0BRACING/DECKING\$5.1HEADER/STUD DTILS

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hollingsworth pack austin

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JUAN VARELA 512.576.4006 jvgeneralcarpentry@yahoo.com

PRICING SET

© BEN MAY DESIGN 2020

NEW REMODEL 1806 TRAVIS HEIGHTS BLVD AUSTIN, TX 78704

DATE REV1

8 / 14 / 20 10 / 15 / 20

SCALE

Sheet Name





15

1806 TRAVIS HEIGHTS BLVD

REMODEL/ADDITION

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ZONING: SF-3-NP

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| IMPERVIOUS COVER | |
| ALLOWABLE I.C: | 3,081 SF |
| EXISTING I.C. | 2,502 SF 36.54% |
| PROPOSED I.C. | 2,601 SF |

| EXISTNG FOOTRPINT: 1 | ,160 SF |
|----------------------|---------|
| ADTL. FOOTPRINT: | 118 SF |
| CONC. DRIVE/STAIRS: | 636 SF |
| NEW DECK 754SF@50% | 377 SF |
| SET STONE WALL/EDGE | 192 SF |
| EXISTING CONC. WALL | 100 SF |
| 2 AC PADS: | 18 SF |
| | |
| NEW IMPERVOUS: 2, | 601 SF |

37.98 %

NOTES:

SHEET INDEX:

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| 01 | RENDERINGS |

SP1 EXIST/NEW SITEPLAN SP2 SITE AREA TOTALS SP3 FRONT YARD TOTALS

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| A4,1 | DETAILS |
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| S1.1 | 2ND/ROOF FRAMING |
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SMOKE DETECTOR SYSTEM: GENERAL CONTRACTOR IS RESPONSIBLE THAT THE DWELLING UNIT TO BE EQUIPPED WITH AN APPROVED SMOKE DETECTOR SYSTEM AT CORRESPONDING LOCATIONS, IN

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CARBON MONOXIDE ALARM: THE GENERAL CONTRACTOR IS RESPONSIBLE THAT THE DWELLING UNIT BE EQUIPPED WITH AN APPROVED CARBON MONOXIDE ALARM AT CORRESPONDING LOCATIONS, IN ACCORDANCE WITH 2015 IRC SECTION R315.

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hollingsworth pack austin

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PRICING SET

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NEW REMODEL 1806 TRAVIS HEIGHTS BLVD AUSTIN, TX 78704

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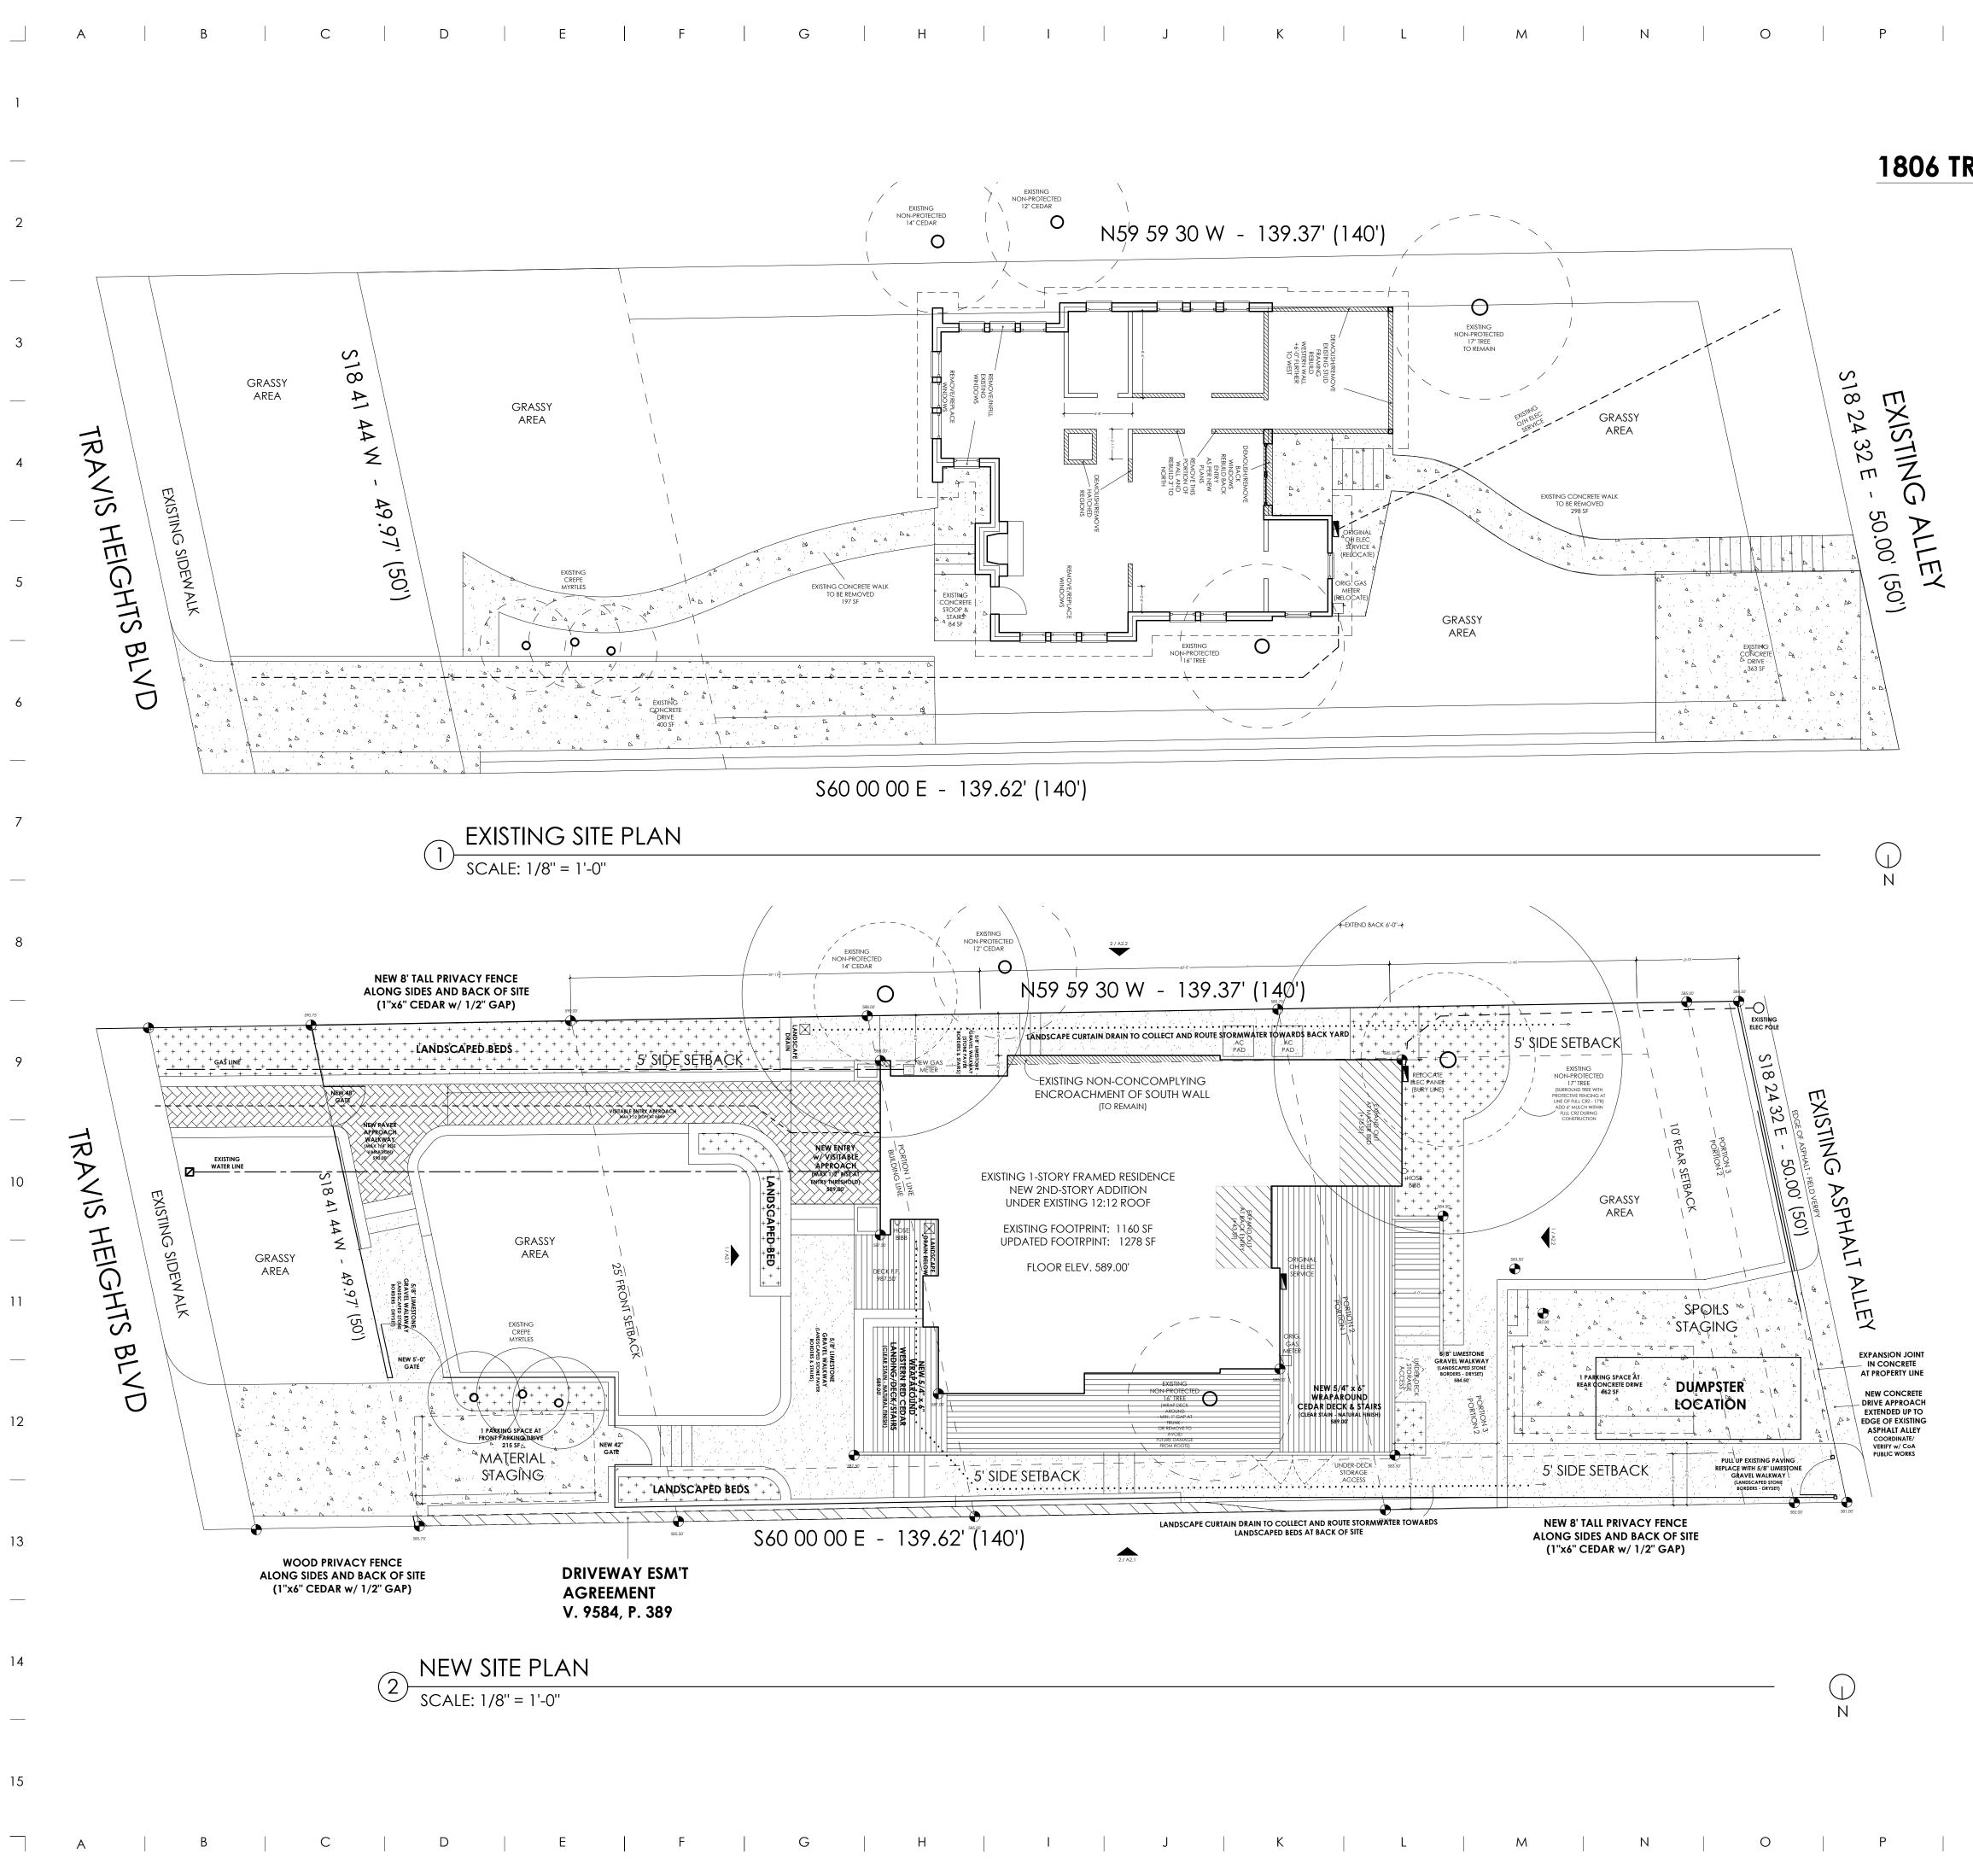
SCALE

DATE

REV1

Sheet Name

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NOTES:

1806 TRAVIS HEIGHTS BLVD REMODEL/ADDITION

GENERAL NOTES:

HIGH PERFORMANCE WINDOWS:

New Glazing to achieve Austin Energy Code requirements: U-Value of 0.35 / SHGC Factor of 0.25.

INSULATION: New Walls: Minimum of R19 New Roof: Minimum of **R38**. Floor Insulation: Minimum or **R13**.

SAFETY GLAZING: Safety Glazing to be installed as per IRC section R308.4. (Noted locations: glass in doors, windows 24" or less from a door jamb, glazing less than 5'-0" above tub floor if applicable, and at tub/shower enclosures.)

SMOKE DETECTOR SYSTEM:

General Contractor is responsible that the dwelling unit to be equipped with an APPROVED SMOKE DETECTOR system at corresponding locations, in accordance with 2015 IRC Section R314.

General Contractor to verify Smoke Detectors are located at least 36" away from horizontal path of mechanical air flow. **Per 2007 NFPA 72 Chapter 11**.

CARBON MONOXIDE ALARM:

General Contractor is responsible that the dwelling unit to be equipped with an Approved CARBON MONOXIDE ALARM at corresponding locations, in accordance with **2015 IRC Section R315**.

VISITABILITY NOTES:

| EXTERIOR | ROUTE: |
|----------|--------|
| | |

POINT OF ORIGIN: FRONT SIDEWALK ELEVATION 590'-0" VISITABLE ENTRANCE: FRONT ENTRY DOOR

VISITABLE ROUTE:

VISITABLE DOORWAY: 1) 36" WIDE x 6'-8" TALL DOOR (MIN. 32" CLEAR WIDTH) 2) BEVELED THRESHOLD w/ 1/2" MAX RISE (SEE DETAIL BELOW)

LANDING ELEV: 589'-0"

INTERIOR COMPLIANCE:

BATHROOM ROUTE: FRONT ENTRY DOOR TO BATH 1, KITCHEN, FRONT LIVING/DINING, AND BEDROOMS.

1) MINIMUM CLEAR WIDTH OF 32". 2) THRESHOLDS AND TRANSITIONS TO BE RAMPED OR

BEVELED.


VISITABLE BATHROOM:

1) MINIMUM CLEAR OPENING OF 30" AT DOOR. 2) LATERAL 2"x6" WOOD BLOCKING SHALL BE INSTALLED FLUSH WITH STUD EDGES OF BATHROOM WALLS. CENTERLINE OF BLOCK AT 34" A/F/F/ EXCEPT FOR PORTION OF THE WALL LOCATED DIRECTLY BEHIND THE LAVATORY.

ELECTRICAL:

1) LIGHT SWITCHES AND ENVIRONMENTAL CONTROLS NO HIGHER THAN 48" ABOVE FINISHED FLOOR LEVEL. (TO TOP OF DEVICE/SWITCH)

2) OUTLETS AND RECEPTICALS MINIMUM OF 15" ABOVE INTERIOR FLOOR LEVEL EXCEPT FOR FLOOR OUTLETS.

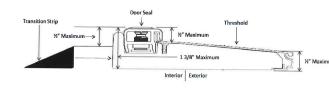

TYPICAL VISITABLE THRESHOLD CoA DETAIL: CI2013-0002







hollingsworth pack austin

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SHEET NAME

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WALK FROM FRONT SIDEWALK TO FRONT DOOR: 70'-0" LENGTH MAX. SLOPE 1:12 / 8.3%

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ELECTRICAL SYSTEMS. THIS OFFICE SHALL NOT BE RESPONSIBLE FOR

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SMOKE DETECTOR SYSTEM: GENERAL

CARBON MONOXIDE ALARM: THE GENERAL

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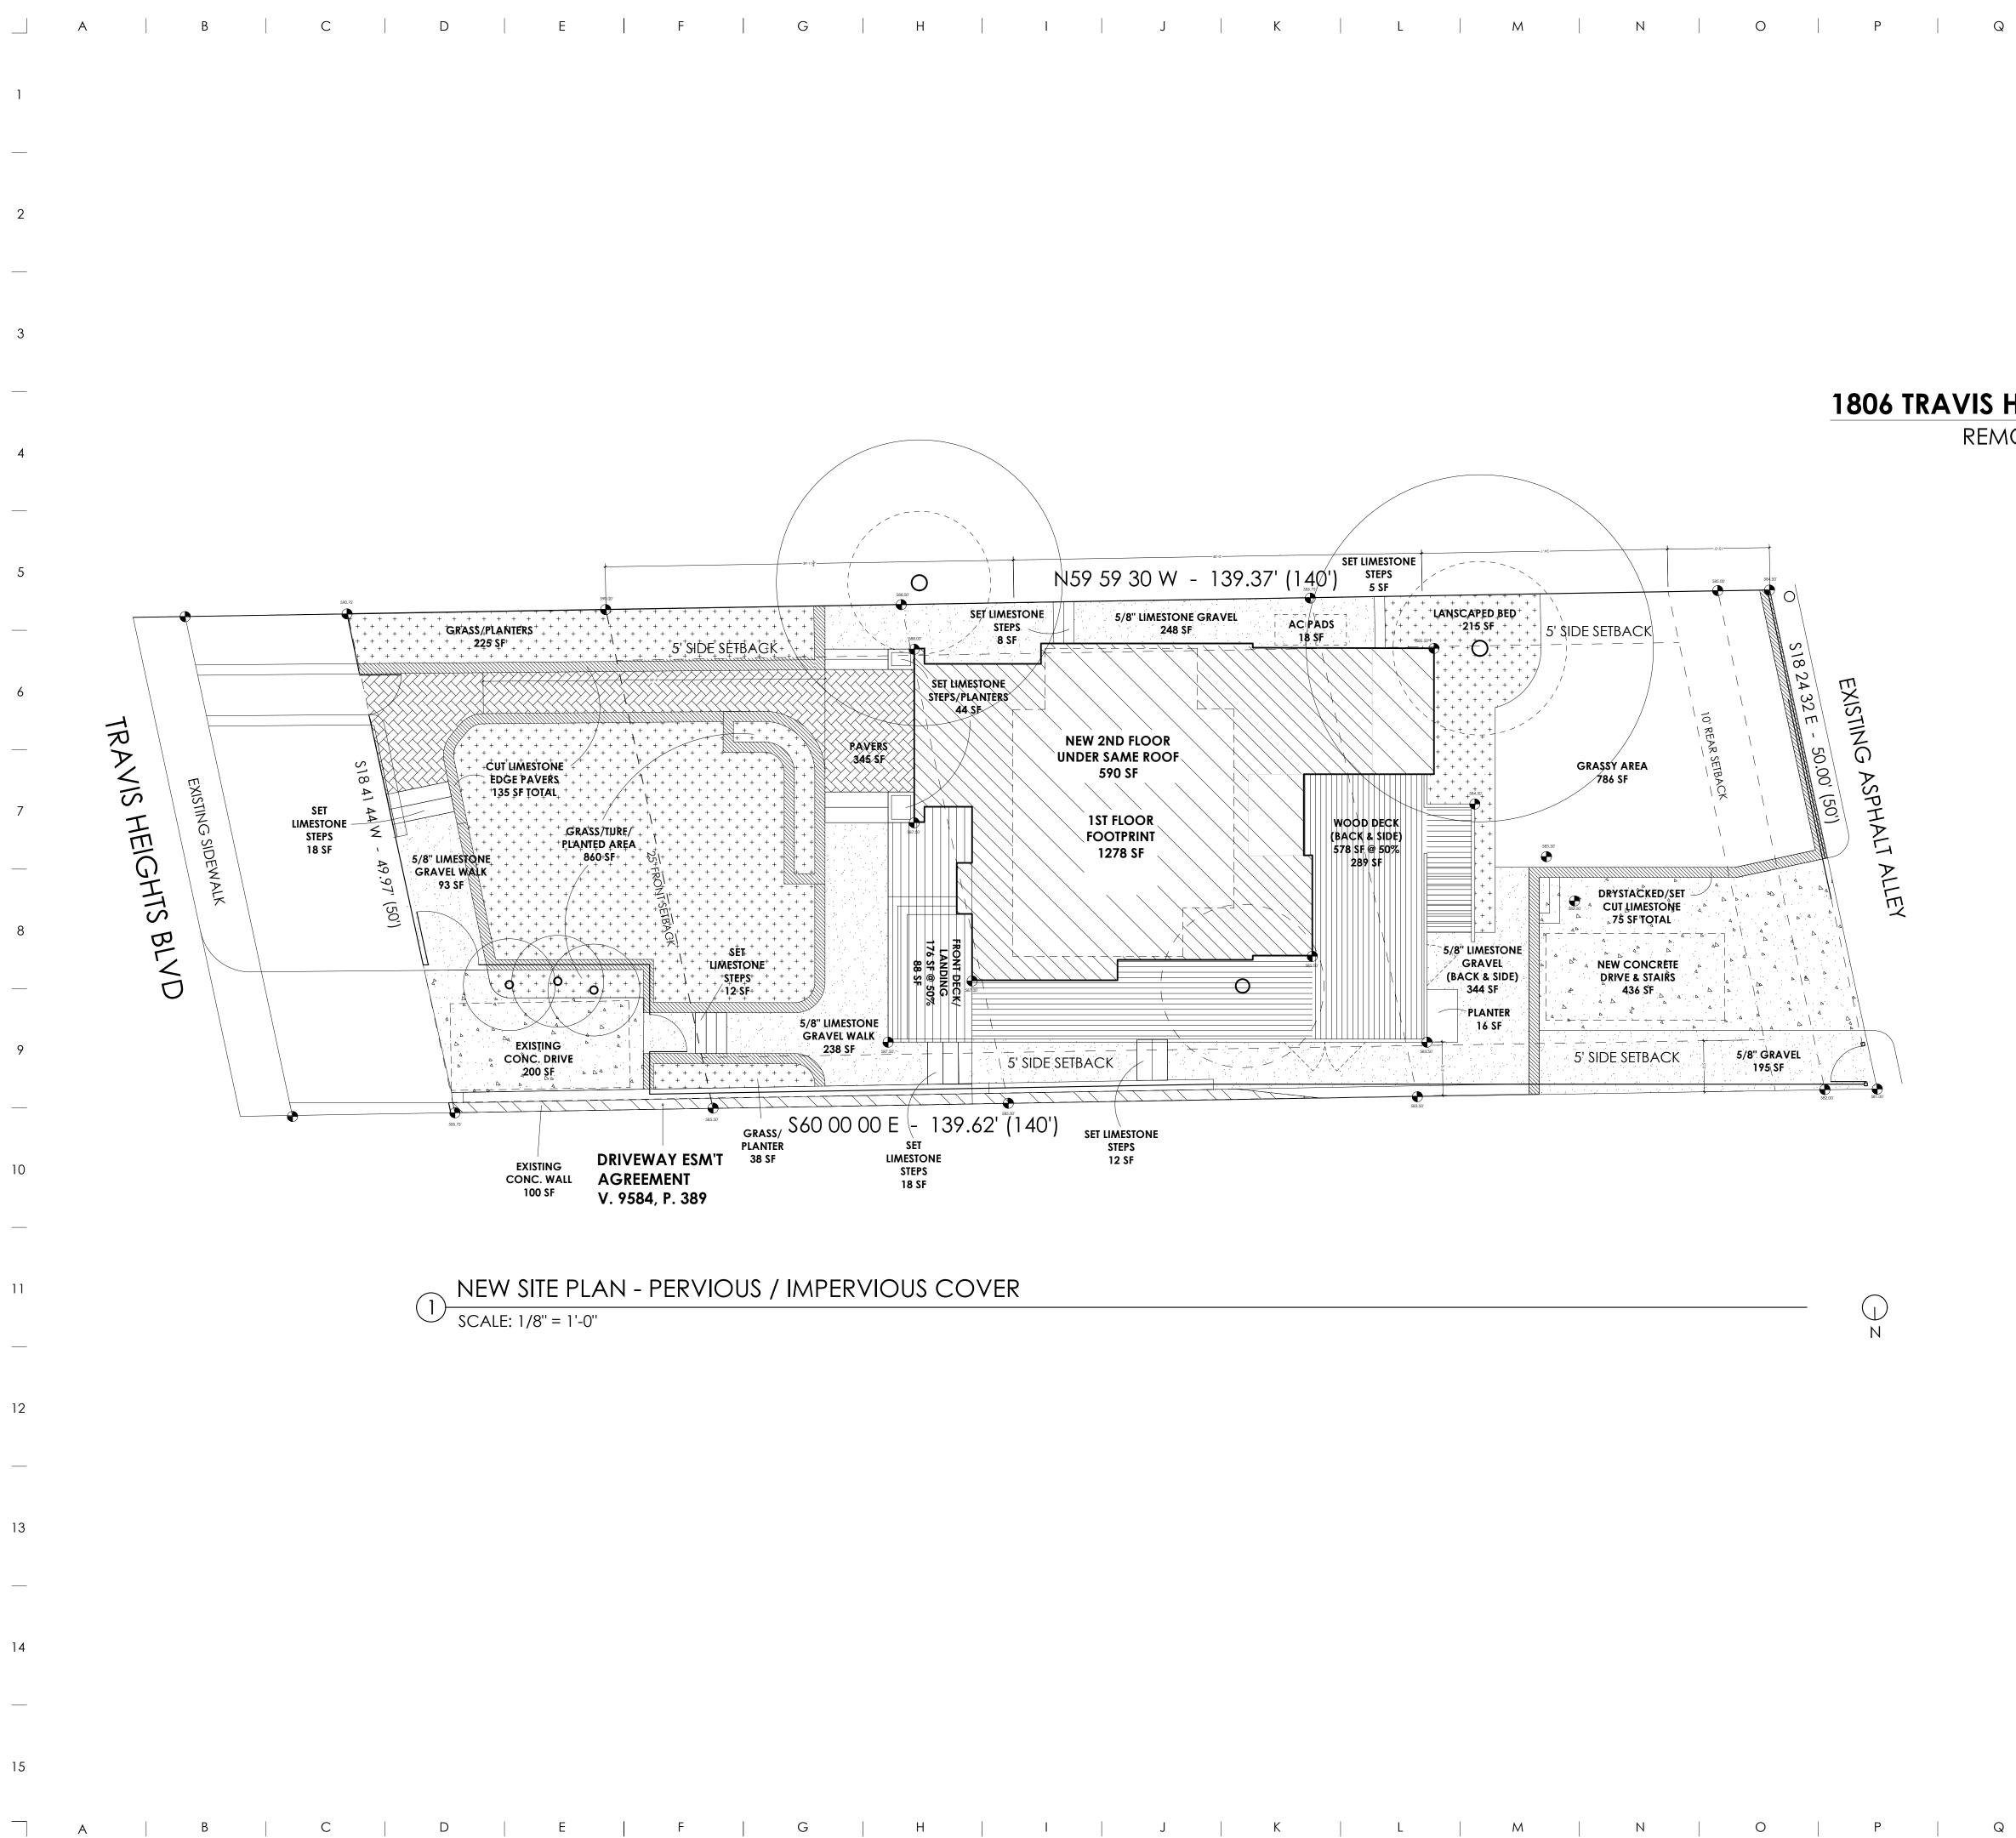
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1806 TRAVIS HEIGHTS BLVD

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GENERAL CONTRACTOR:

JV GENERAL CARPENTRY IIIANI VARFIA 512.576.4006 jvgeneralcarpentry@yahoo.com

PRICING SET

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NEW REMODEL 1806 TRAVIS HEIGHTS BLVD AUSTIN, TX 78704


| DATE | 8 / 14 / 20 |
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| REV1 | 10 / 15 / 20 |

10 / 15 / 20

SCALE

Sheet Name

| Q R |
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|-----|

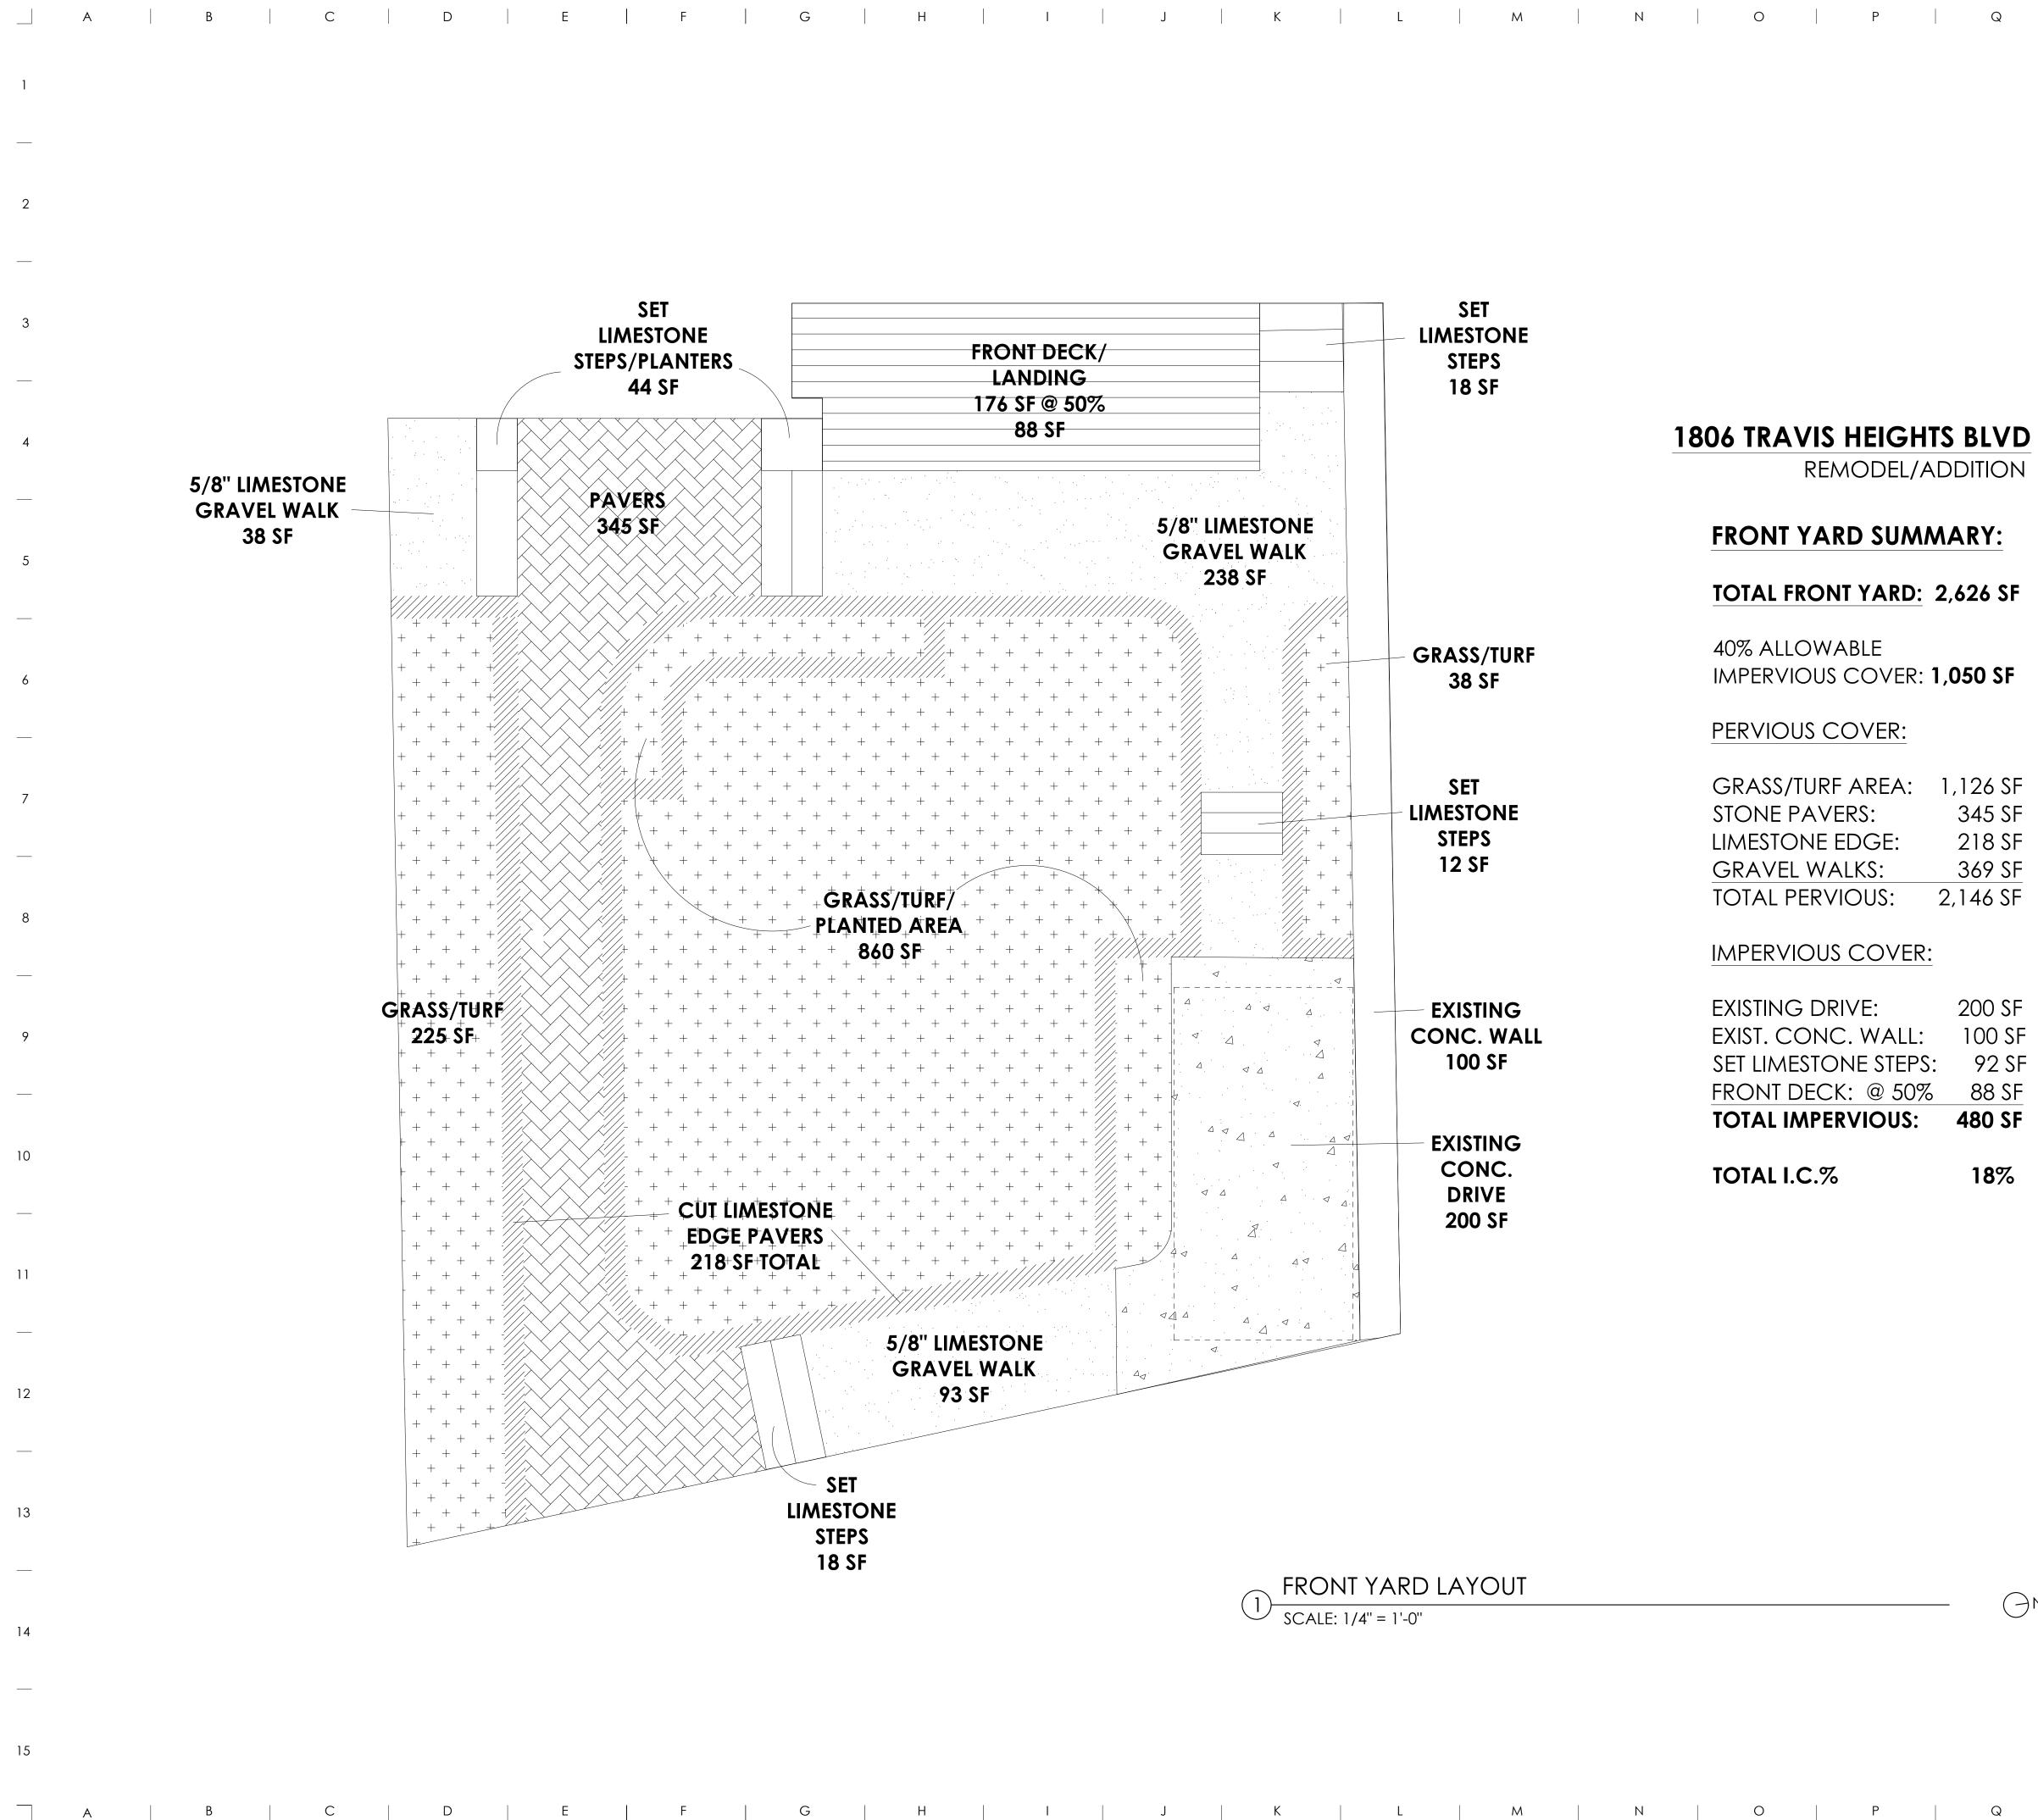

Q R

REMODEL/ADDITION

| REA: | 1,126 SF |
|----------|----------|
|).). | 345 SF |
| GE: | 218 SF |
| S: | 369 SF |
| US: | 2,146 SF |
| | |

| 480 SF |
|--------|
| 88 SF |
| 92 SF |
| 100 SF |
| 200 SF |
| |

18%



Q R



GENERAL

REQUIREMENTS.

CONTRACTOR NOTES:

THE GENERAL CONTRACTOR (GC) SHALL FULLY COMPLY WITH THE LOCAL

GOVERNING CODES, INCLUDING ALL ADDITIONAL STATE AND LOCAL CODE

THE GC SHALL ASSUME FULL RESPONSIBILITY

OR ANY WORK KNOWINGLY PERFORMED

CONTRARY TO SUCH LAWS, ORDINANCES, &

PERFORM COORDINATION WITH ALL UTILITIES

WRITTEN DIMENSIONS ON THESE DRAWINGS

SHALL HAVE PRECEDENCE OVER SCALED

THEMSELF WITH THE CONSTRUCTION DOCUMENTS AND NOTIFY THIS OFFICE OF

ANY DISCREPENCY THAT THEY MAY IDENTIFY

OR ANY ITEM NEEDING FURTHER ATTENTION.

DIMENSIONS SHOWN ARE TO FACE OF

THE GC SHALL VERIFY AND IS RESPONSIBLE

FOR ALL DIMENSIONS (INCLUDING ROUGH

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VARIATIONS FROM THESE DRAWINGS.

OPENINGS) AND CONDITIONS ON THE JOB

THE GC IS RESPONSIBLE FOR THE DESIGN AND PROPER FUNCTION OF PLUMBING, HVAC,

AND ELECTRICAL SYSTEMS. THE GC SHALL

NOTIFY THIS OFFICE WITH ANY PLAN CHANGES REQUIRED FOR DESIGN AND

FUNCTION OF PLUMBING, HVAC AND

THIS OFFICE SHALL NOT BE RESPONSIBLE FOR

ACTS OR OMISSIONS OF THE CONTRACTOR

OR SUBCONTRACTOR, OR FAILURE OF ANY

ACCORDANCE WITH THE CD'S. ANY DEFECT OR DISCREPENCY FOUND WITH THE CD'S

SHALL BE BROUGT TO THE ATTENTION OF THIS

BURDEN OF COST AND LIABILITY FROM SUCH

SAFETY GLAZING: ALL HAZARDOUS GLASS MUST BE IN ACCORDANCE WITH 2015 IRC

IN DOORS, WINDOWS 24" OR LESS FROM DOOR JAMB, GLAZING LESS THAN 5'-0"

SMOKE DETECTOR SYSTEM: GENERAL CONTRACTOR IS RESPONSIBLE THAT THE

CORRESPONDING LOCATIONS, IN

ABOVE TUB FLOOR, AND SHOWER OR TUB

DWELLING UNIT TO BE EQUIPPED WITH AN

APPROVED SMOKE DETECTOR SYSTEM AT

ACCORDANCE WITH 2015 IRC SECTION R314.

GENERAL CONTRACTOR SHALL VERIFY FOR SMOKE DETECTORS TO BE LOCATED AT LEAST

CARBON MONOXIDE ALARM: THE GENERAL

CONTRACTOR IS RESPONSIBLE THAT THE DWELLING UNIT BE EQUIPPED WITH AN

APPROVED CARBON MONOXIDE ALARM AT CORRESPONDING LOCATIONS, IN

ACCORDANCE WITH 2015 IRC SECTION R315

WATERPROOF ALL WATER/SPLASH AREAS TO A MINIMUM OF 60" ABOVE FINISHED FLOOR. INSULATE MEP LINES FOR SOUND CONTROL.

EXHAUST ALL VENTS AND FANS DIRECTLY

ALL LANDSCAPING TO PROMOTE DRAINAGE AWAY FROM THE STRUCTURE & FOUNDATION.

PROVIDE SILT FENCING AND/OR MULCH SOCKS AT PERIMETER OF SITE.

OUTSIDE VIA METAL DUCTS.

INSTALL POLYISOCYANURATE FOAM TYPE INSUATION - OR EQUIVALENT - AT FLOOR AND PLATE LINES, OPENINGS IN PLATES, CORNER STUD CAVITIES AND AROUND DOOR AND WINDOW ROUGH OPENING

36" AWAY FROM HORIZONTAL PATH OF MECHANICAL AIR FLOW.

PER NFPA 72 CHAPTER 11.

CAVITIES.

SECTION R308.4. (NOTED LOCATIONS: GLASS

OFFICE BY WRITTEN NOTICE PRIOR TO

TIME NOT ALLOWED THIS OFFICE TO CORRECT THE DEFECT SHALL PLACE THE

DEFECT UPON THE GC.

ENCLOSURES.

PROCEEDING WITH WORK. REASONABLE

OF THEM TO CARRY OUT WORK IN

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FINISHED MATERIALS.

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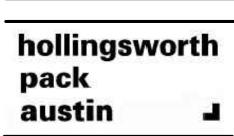
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PROJECT TEAM:

OWNERS:

KATHERINE & NORMAN TALIAFERRO CONTACT: 913.940.2843 katherine@denpg.com

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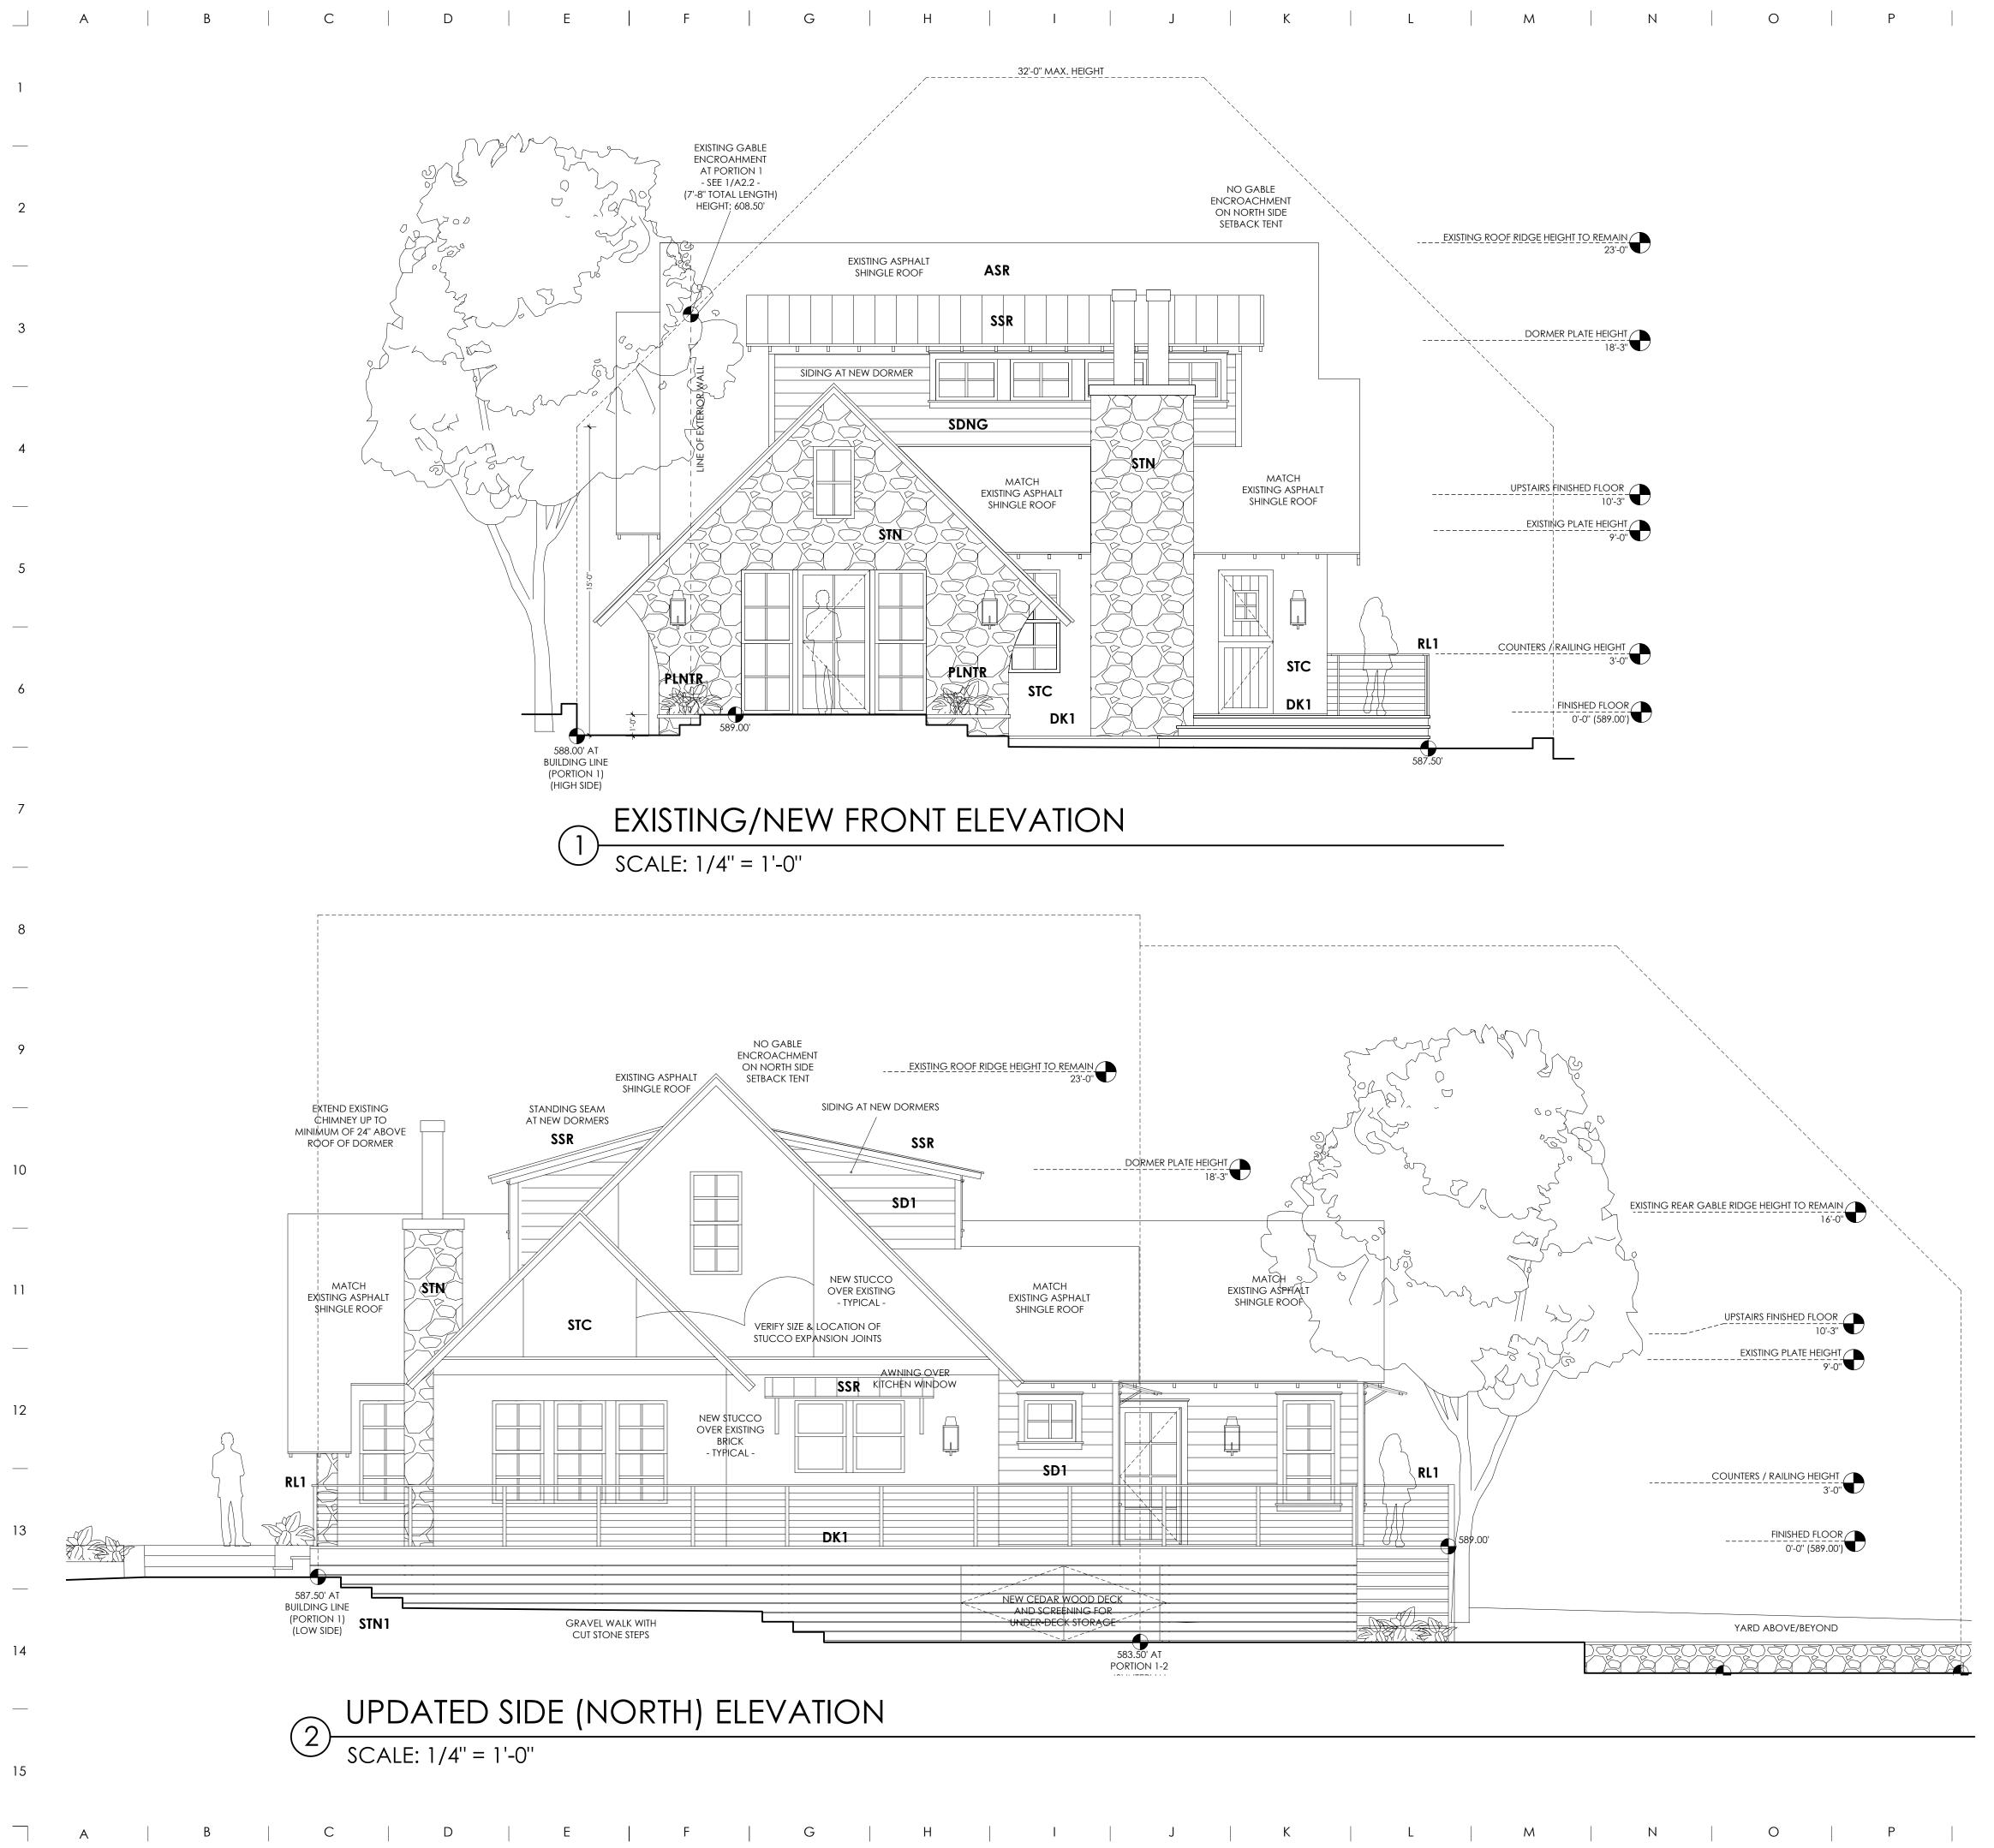
DATE 8/14/20 REV1

10 / 15 / 20

SCALE

SHEET NAME

SP



MATERIAL NOTES

R

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EXTERIOR FINISHES:

Q

** ALL EXPOSED WOOD TO BE CLEAR HEART NO.2 OR BETTER (KILN DRIED TO 16-18%)

- **CNC** CONCRETE DRIVE/STAIRS SALTED NON-SLIP FINISH
- **DK1** 5/4" x 6" WR CEDAR DECKING w GAP (CLEAR SEALER - NATURAL FINISH)
- **ASR** ASPHALT SHINGLE ROOF (MATCH EXISTING)
- SSR STANDING SEAM METAL (1" SEAM - CHARCOAL)
- **STC** NEW STUCCO EXTERIOR (TYPICAL 3-COAT - HAND-TROULED)
- **STN** EXISTING EXTERIOR STONE TO BE WHITE-WASHED/ SLURRY-COATED
- **SD1** LAP-SIDING MATCH EXISTING AND/OR REPLACE WITH EQUIVALENT (PAINTED - COLOR TBD)
- **RL1** 1/2" x 3" FLATBAR STEEL VERTICAL POSTS w/ 1/2" x 1/2" SQUARE BAR TACK-WELDED TO OUTSIDE OF FLATBAR POSTS (RE: STRUCTURAL/MAX. 4" OPENING)
- WD1 1"x10" WOOD SOFFIT (EXISTING - MATCH) PAINT-GRADE PINE/FIR (REPAIR OR REPLACE AS NEEDED) (REPLACEMENT/NEW SOFFIT MATERIAL LOCATED WITHIN THE SETBACK TO BE 1HR FIRE RATED ASSEMBLY/MATERIAL)
- **WD2** 1"x4" HANDRAIL TOPPER VG/CLEAR HEART WESTERN RED CEDAR (CLEAR COAT SEALER - NATURAL FINISH)
- **STN1** CUT STONE WALKS/STAIRS (FLAGSTONE/LEUTERS/PAVERS)
- **PLNTR**LANDSCAPED BEDS 12" CUT LIMESTONE CAPS w/ DRYSTACK CUT STONE TO MATCH EXISTING -(MORTAR AT BACK OF COURSE IF NEEDED - PROVIDE ADEQUATE WEEP AND DRAINAGE)

CASE TRIM: 1x4 TO MATCH SIDING (PAINT TO MATCH)

CASE TOP ACCENT TRIM:

DOUBLE STEPPED CROWN CAP (1x2 + RIPPED 1x4 STEPPED CASE CAPS or ALTERNATE CAP PROFILE TBD WITH OWNER)


SILLS/STOOLS: 2x THICKNESS w 1x4 APRON SLOPE AWAY FROM WINDOW (PAINT TO MATCH)

FLASH ALL WINDOWS/DOORS AS PER MANUFACTURER SPECS

GUTTERS:

5K-STYLE METAL GUTTERS w/ ROUND DOWNSPOUTS AS SHOWN ON ROOF PLAN (A1.2) (BRONZE TO MATCH WINDOWS)

·2

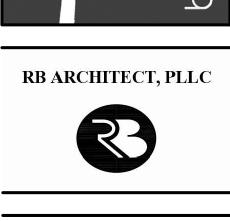

hollingsworth pack austin

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