


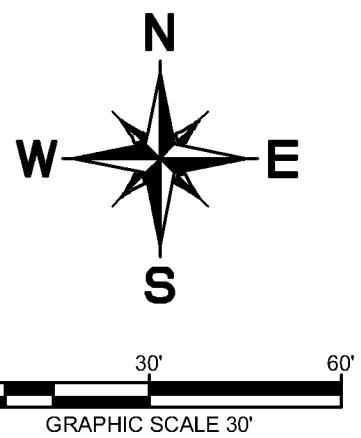




ELEVATIONS TABLE		
	CUT/FILL RANGE	COLOR
CUT	4'-8'	
	8'+	
FILL	4'-8'	
	8'+	

NOTE:

1. CUT/FILL EXCLUDES BUILDINGS.
2. THERE IS NO PUBLIC RIGHT OF WAY ON THE CAMPUS.
ALL ROADS ARE PRIVATE.

[illegible]

Kimley»»Horn
10814 JOLLYVILLE ROAD AVALON IV SUITE 200 AUSTIN, TX 78759
PHONE: 512-418-1771 FAX: 512-418-1791
WWW.KIMLEY-HORN.COM
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TBE Firm No. 928



KHA PROJECT 069229503	DATE SEPTEMBER 2020	SCALE: AS SHOWN	DESIGNED BY: JCL	DRAWN BY: JCL	CHECKED BY: BEH
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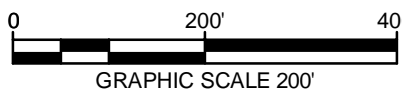
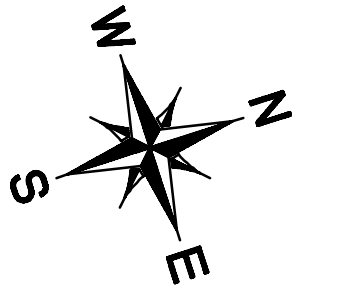
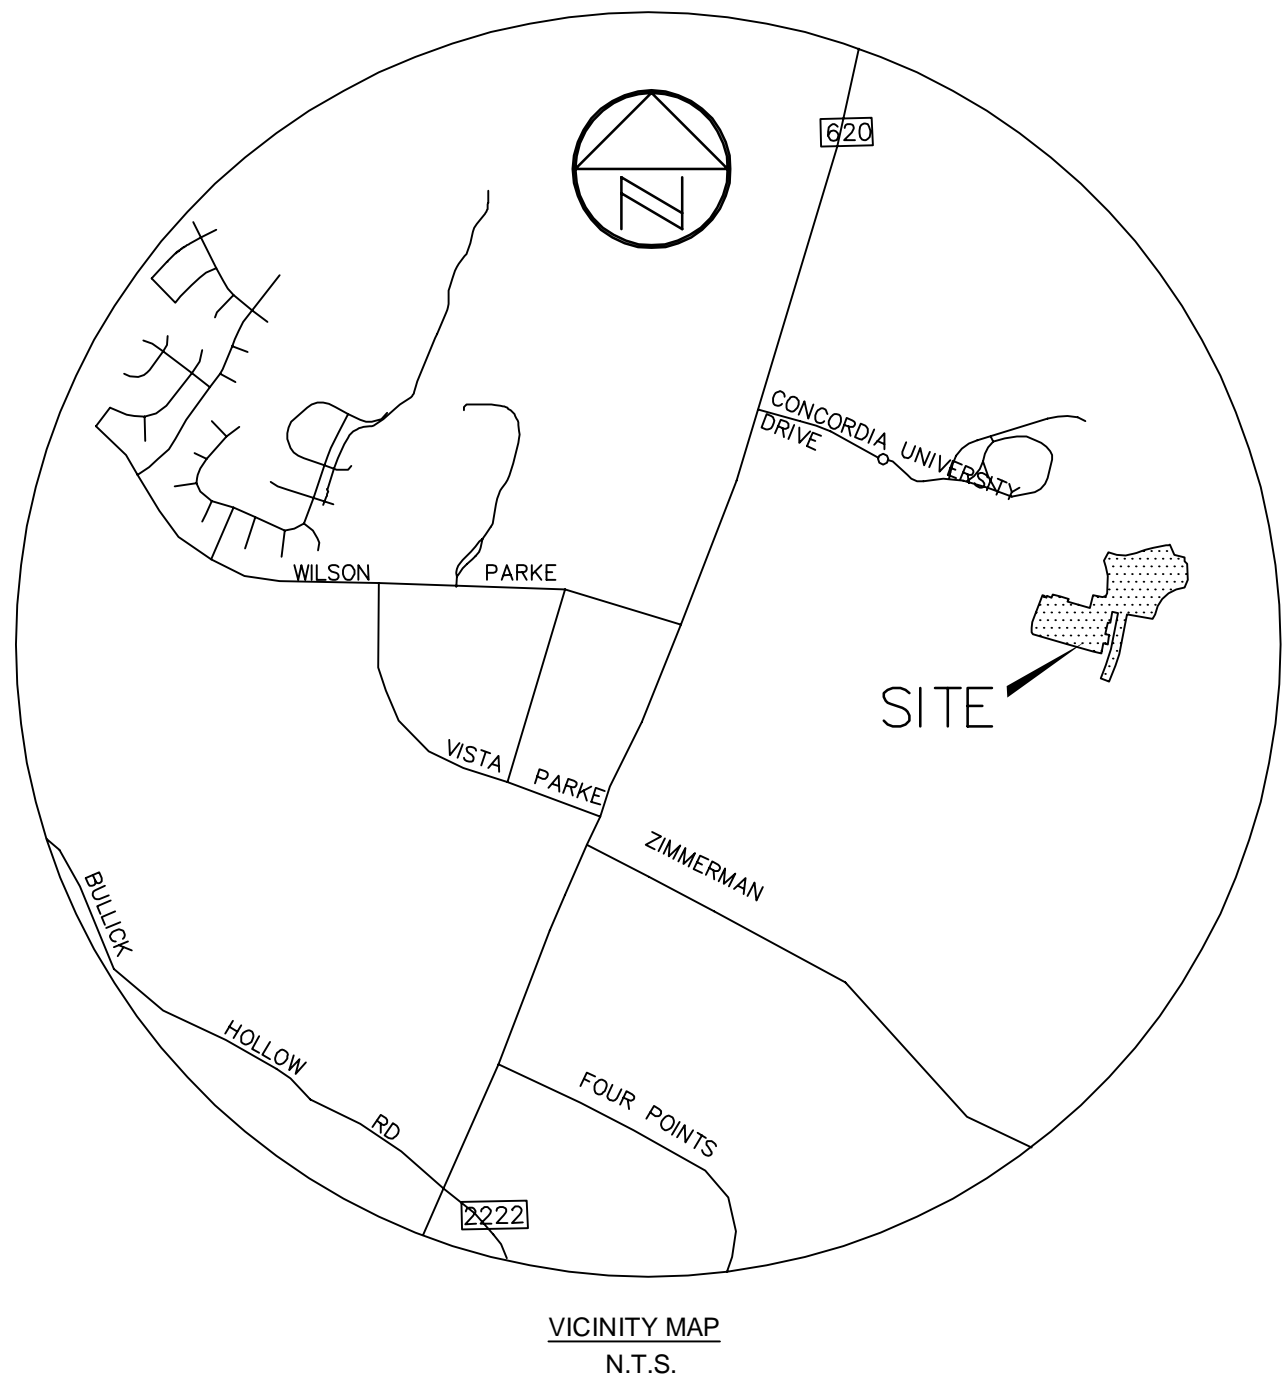
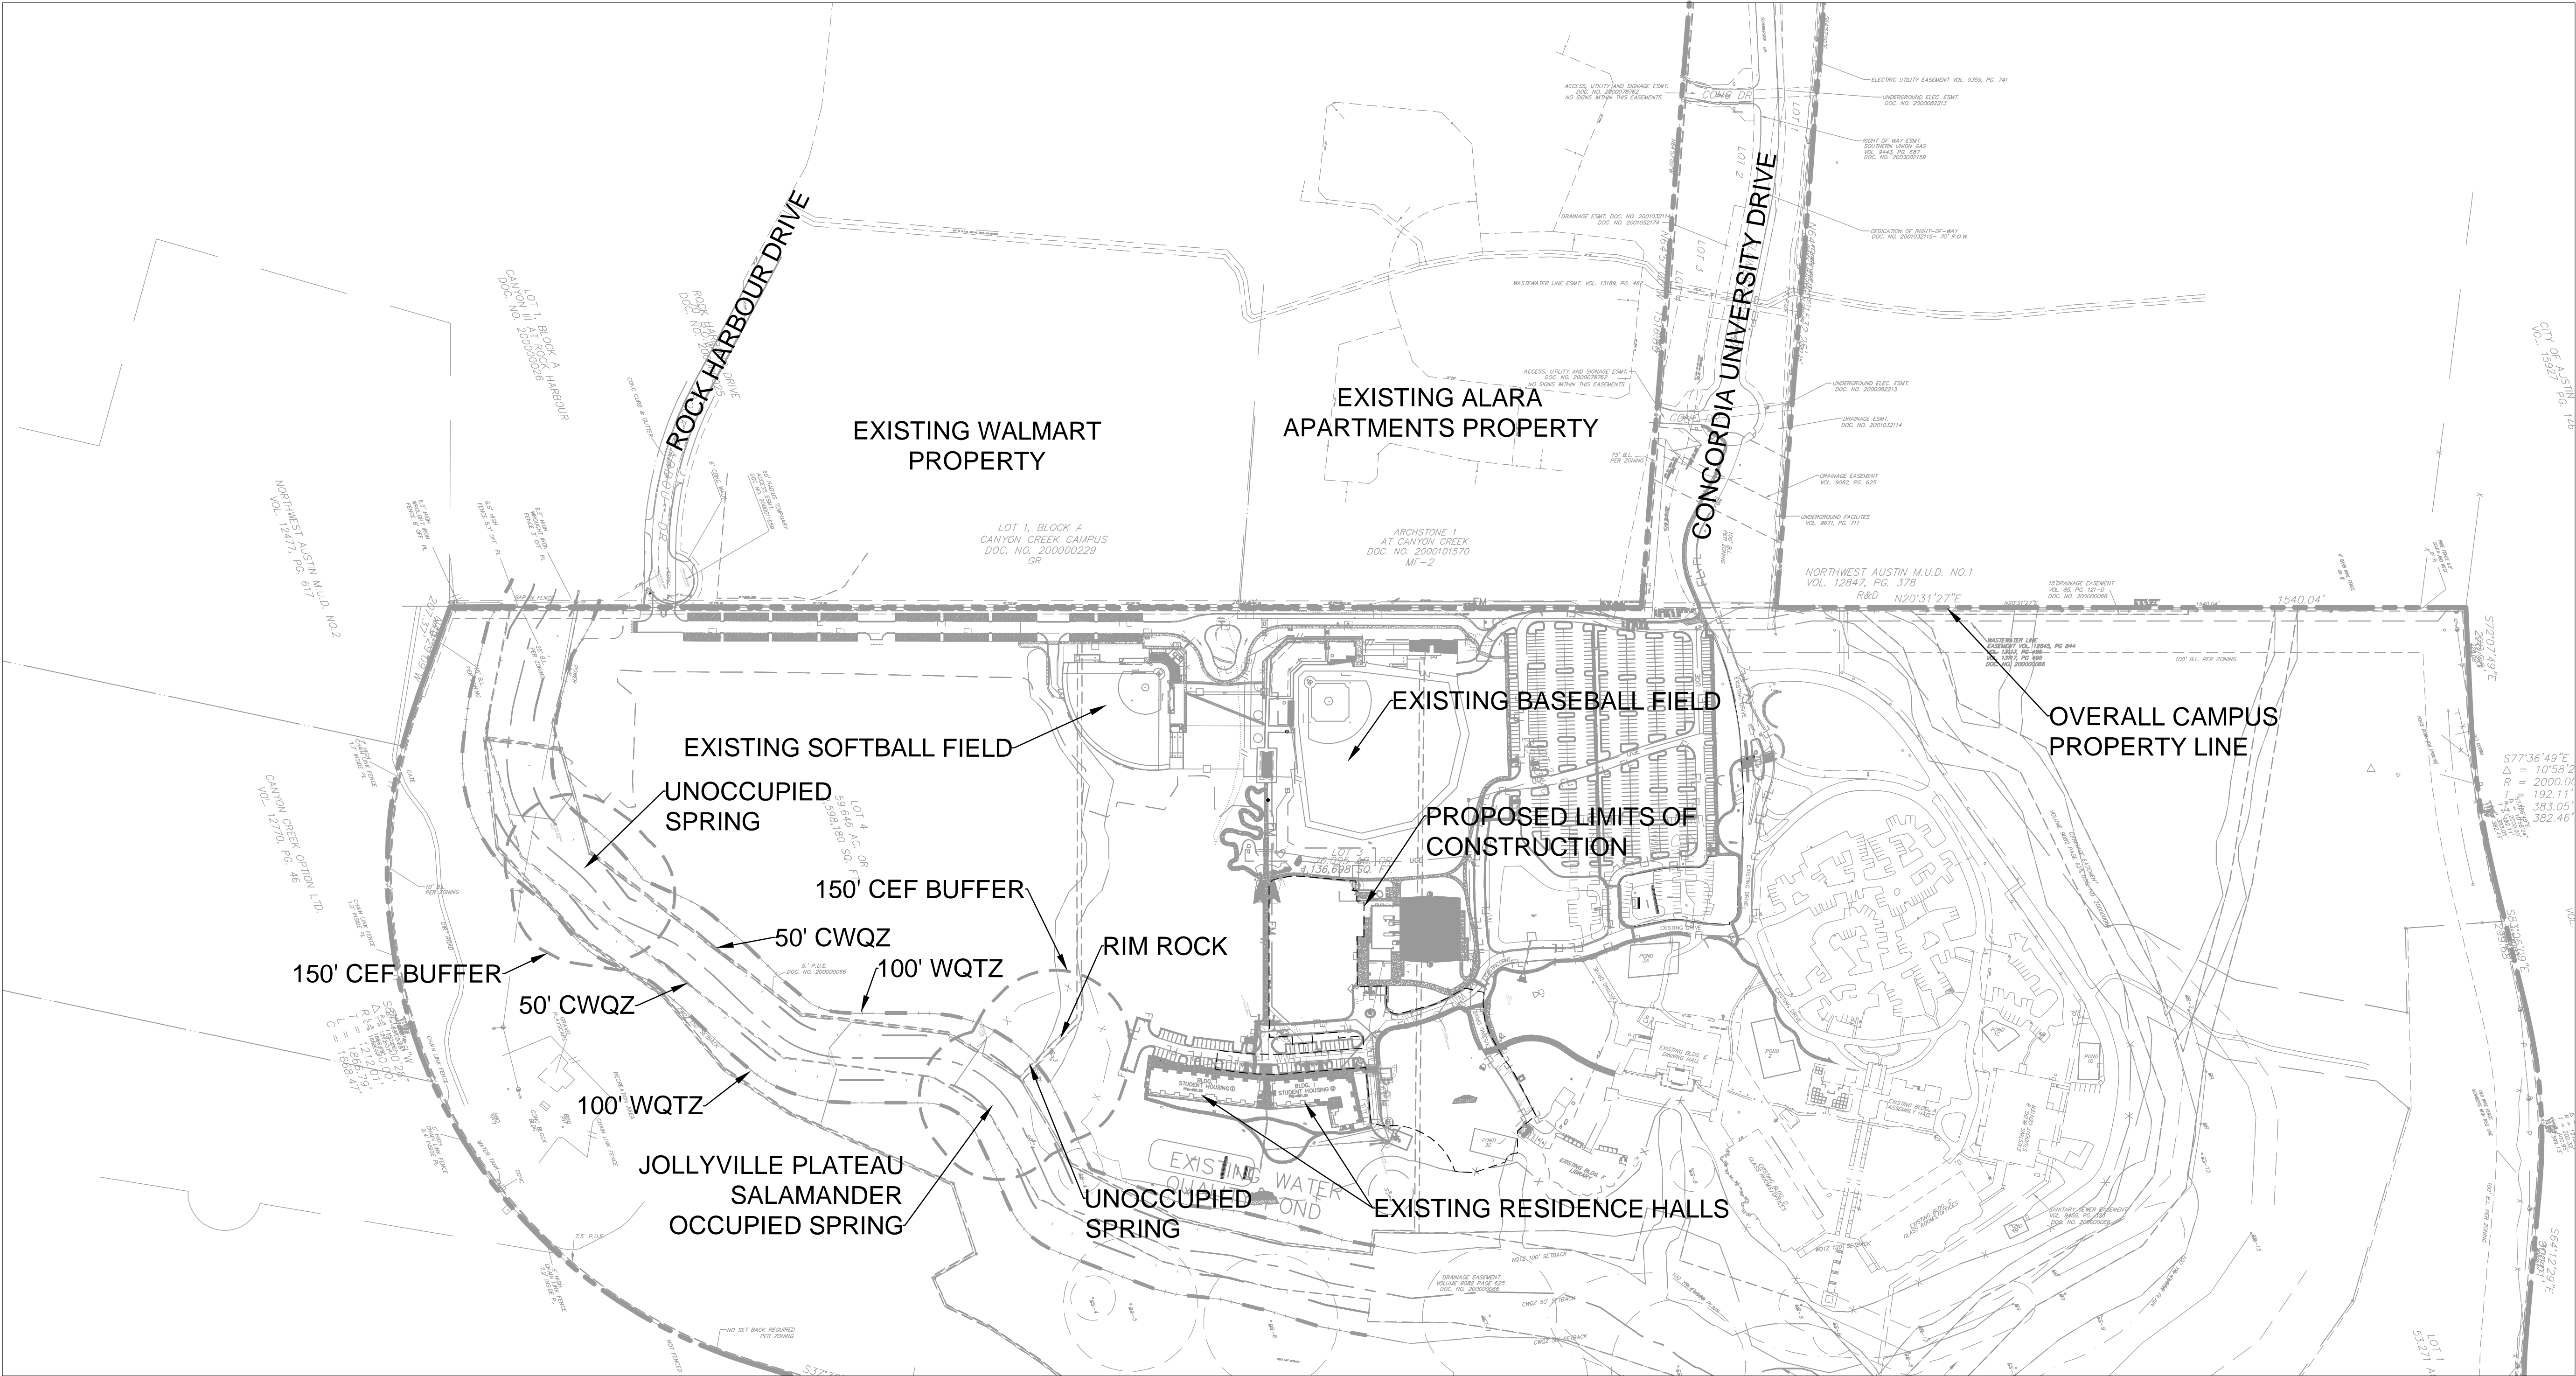
CUT-FILL MAP

CONCORDIA UNIVERSITY
RESIDENCE HALL
CITY OF AUSTIN
TRAVIS COUNTY, TEXAS

SHEET NUMBER
23 OF 43

SP-2020-0038C

Plotted By: Lytle, Jack Date: June 29, 2020 10:29:37am File Path: Z:\Project\AUS_Civil\069229503 Concordia Master Plan\069273300 Residence Hall\Con\Exhibits\PlanSheets\Existing Site Plan.dwg
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---	PROPERTY LINE
---	LIMITS OF CONSTRUCTION

EXISTING SITE PLAN

Concordia Unviersity Residence Hall

July 2020

Kimley»Horn

NOTE: THIS PLAN IS CONCEPTUAL IN NATURE AND HAS BEEN PRODUCED WITHOUT THE BENEFIT OF A SURVEY. TOPOGRAPHY, UTILITIES, CONTACT WITH THE CITY, ETC.

Plotted By: Kyle, Jack Date: July 27, 2020 08:41:07pm File Path: K:\AUS_Civil\609229503 Concordia Master Plan\609273300 RESIDENCE HALL\CD Plan Sheets\OVERALL SITE PLAN-OVERALL.dwg
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SLOPE CATEGORY	SITE AREA (AC)	IMPERVIOUS COVER (SF)					IMPERVIOUS COVER (%)					BUILDING COVERAGE		GROSS FLOOR AREA (SF)	F.A.R.
		BUILDING	ROADWAY/ DRIVEWAY	OTHER	TOTAL	ALLOWED	BUILDING	ROADWAY/ DRIVEWAY	OTHER	TOTAL	ALLOWED	SF	%		
0-15%	316.9	183388	725710	252212	1161310	6902082	1.33%	5.26%	1.83%	8.41%	50.00%	183388	1.33%	311836	0.023
15-25%	28.5	0	0	0	0	0	0.00%	0.00%	0.00%	0.00%	0.00%	0	0.00%	0	0.000
25-35%	15.4	0	0	0	0	0	0.00%	0.00%	0.00%	0.00%	0.00%	0	0.00%	0	0.000
TOTAL	360.8	183388	725710	252212	1161310	N/A	1.17%	4.62%	1.60%	7.39%	N/A	183388	1.17%	311836	0.023


SLOPE CATEGORY	SITE AREA (AC)	IMPERVIOUS COVER (SF)					IMPERVIOUS COVER IN PERCENT					BUILDING COVERAGE		GROSS FLOOR AREA (SF)	F.A.R.
		BUILDING	ROADWAY/ DRIVEWAY	OTHER	TOTAL	ALLOWED	BUILDING	ROADWAY/ DRIVEWAY	OTHER	TOTAL	ALLOWED	SF	%		
0-15%	316.9	0	142537	625	143162	6902082	0.00%	1.03%	0.00%	1.04%	50.00%	0	0.00%	0.00	0.000
15-25%	28.5	0	0	0	0	0	0.00%	0.00%	0.00%	0.00%	0.00%	0	0.00%	0.00	0.000
25-35%	15.4	0	0	0	0	0	0.00%	0.00%	0.00%	0.00%	0.00%	0	0.00%	0.00	0.000
TOTAL	360.8	0	142537	625	143162	N/A	0.00%	0.91%	0.00%	0.91%	N/A	0	0.00%	0.00	0.000

SLOPE CATEGORY	SITE AREA (AC)	IMPERVIOUS COVER (SF)					IMPERVIOUS COVER IN PERCENT					BUILDING COVERAGE		GROSS FLOOR AREA (SF)	F.A.R.
		BUILDING	ROADWAY/ DRIVEWAY	OTHER	TOTAL	ALLOWED	BUILDING	ROADWAY/ DRIVEWAY	OTHER	TOTAL	ALLOWED	SF	%		
0-15%	316.9	16940	31897	23462	72239	6902082	0.12%	0.23%	0.17%	0.52%	50.00%	16940	0.12%	68618	0.005
15-25%	28.5	0	0	0	0	0	0.00%	0.00%	0.00%	0.00%	0	0.00%	0	0.000	
25-35%	15.4	0	0	0	0	0	0.00%	0.00%	0.00%	0.00%	0	0.00%	0	0.000	
TOTAL	360.8	16940	31897	23462	72239	N/A	0.11%	0.20%	0.15%	0.46%	N/A	16940	0.11%	68618	0.005

SLOPE CATEGORY	SITE AREA (AC)	IMPERVIOUS COVER (SF)					IMPERVIOUS COVER IN PERCENT					BUILDING COVERAGE		GROSS FLOOR AREA (SF)	F.A.R.
		BUILDING	ROADWAY/ DRIVEWAY	OTHER	TOTAL	ALLOWED	BUILDING	ROADWAY/ DRIVEWAY	OTHER	TOTAL	ALLOWED	SF	%		
0-15%	316.9	200328	900144	276299	1376771	6902082	1.45%	6.52%	2.00%	9.97%	50.00%	200328	1.45%	380454	0.028
15-25%	28.5	0	0	0	0	0	0.00%	0.00%	0.00%	0.00%	0	0.00%	0	0.000	
25-35%	15.4	0	0	0	0	0	0.00%	0.00%	0.00%	0.00%	0	0.00%	0	0.000	
TOTAL	360.8	200328	900144	276299	1376771	N/A	1.27%	5.73%	1.76%	8.76%	N/A	200328	1.27%	380454	0.028

This site plan map illustrates the proposed 100-year floodplain (shaded gray) and associated water quality zones along a creek. Key features include:

- Floodplains and Zones:** FEMA 100-Year Floodplain = CoA Fully Developed 100-Year Floodplain; Proposed 100-Year Floodplain (Atlas 14) per Floodplain Study dated 6/30/2020 by KHA; Water Quality Transition Zone (WQTZ); Critical Water Quality Zone (CWQZ).
- Infrastructure and Landmarks:** Existing Water Quality Pond; D.E. DOC#201415200; Jollyville Plateau Salamander Occupied Spring; Preserve Tract DOC# 2007108613 OPRTC.
- Easements and Buffers:** 10' P.U.E. DOC#200000066 O.P.R.T.C.; 150' CEF Buffer; Drainage Easement Vol.9082, PG.625 OPRTC.
- Survey Data:** Numerous bearing and distance measurements are provided for boundary lines and easements, such as N68°12'22"E x 67.06', S80°11'11"W x 358.36', and S75°15'41"W x 496.66'.
- Creek Features:** Creek Centerline and Rock at Support Pier are indicated.

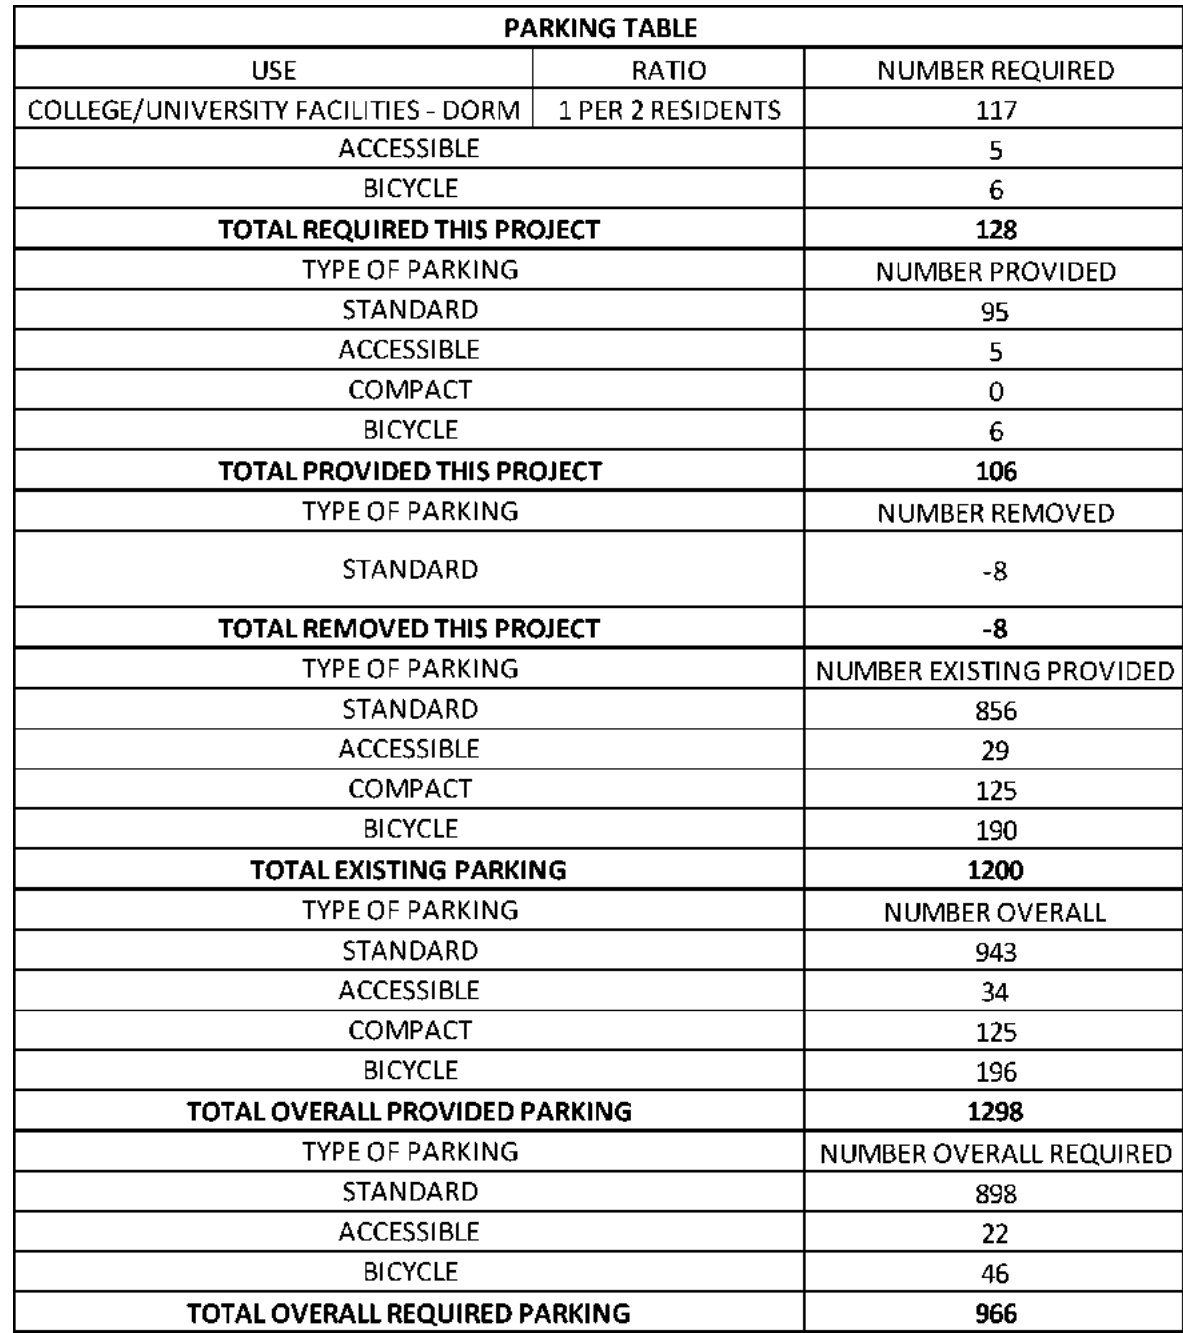

BUILDING DATA	
BUILDING HEIGHT	51.25 FT
BUILDING STORIES	4
FFE (LOWER LEVEL)	951 MSL
FFE (UPPER LEVEL)	957 MSL
FOUNDATION TYPE	SLAB-ON-GRADE
FLOOR AREA - LVL 1	16,940 GSF
FLOOR AREA - LVL 2	17,726 GSF
FLOOR AREA - LVL 3	17,226 GSF
FLOOR AREA - LVL 4	17,726 GSF
TOTAL FLOOR AREA	68,618 GSF

SITE DATA TABLE	
TOTAL SITE AREA (AC)	4.40
OPEN SPACE	
REQUIRED (%)	5.0%
REQUIRED (SF)	9,583
PROVIDED (%)	13.4%
PROVIDED (SF)	25,656
ZONING	R&D-PDA
PROPOSED USE	COLLEGE/UNIVERSITY FACILITIES - DORMITORY

BM #50003 MAG NAIL SET IN TOP OF CURB ON A CIRCULAR MEDIAN LOCATED AT THE INTERSECTION OF TWO DRIVEWAYS 8' NORTHWEST OF A FLAG POLE AND 36' NORTHWEST OF A WASTEWATER MANHOLE.

- ELEV.=957.97' (NAVD '88)

BM #52122 MAG NAIL SET IN THE MIDDLE OF A CONCRETE WALL SOUTH ON THE LIFT STATION 25' SOUTH OF A STORM SEWER MANHOLE ON A CURB INLET AND 47' SOUTHEAST OF A WASTEWATER MANHOLE

- ELEV.=940.28' (NAVD '88)



WARNING: CONTRACTOR IS TO
VERIFY PRESENCE AND EXACT
LOCATION OF ALL UTILITIES
PRIOR TO CONSTRUCTION.

SITE PLAN APPROVAL SHEET 14 OF 43

FILE NUMBER **SP-2020-0038C** APPLICATION DATE **1/31/2020**

APPROVED BY COMMISSION ON _____ UNDER SECTION **112** OF CHAPTER **25-5** OF THE CITY OF AUSTIN CODE.

EXPIRATION DATE (25-5.8.LDC) _____ CASE MANAGER **JEREMY SILTALA**

PROJECT EXPIRATION DATE (ORD-#970905-A) _____ DWPZ _____ DDZ _____

Director, Development Services Department

RELEASED FOR GENERAL COMPLIANCE: _____ ZONING **R&D-PDA**



Rev. 1 _____ Correction 1 _____

Rev. 2 _____ Correction 2 _____

Rev. 3 _____ Correction 3 _____

Final plan must be recorded by the Project Expiration Date, if applicable. Subsequent Site Plan filings that do not comply with the Code current at the time of filing, and all required Building Permits and/or a notice of construction (if a building permit is not required), must also be recorded prior to the Project Expiration Date.

Plotted By: Jack, Date: July 27, 2020 08:47:20am File Path: K:\AUS CIVIL\069229503 Concordia Master Plan\069229503 JOLLYVILLE PLATEAU SALAMANDER PROTECTION PLAN.dwg This document, together with the concepts and designs presented herein, is intended only for the specific purpose and client for which it was prepared. Reuse of and improper reliance on this document without written authorization and adaptation by Kimley-Horn and Associates, Inc. shall be without liability to Kimley-Horn and Associates, Inc.

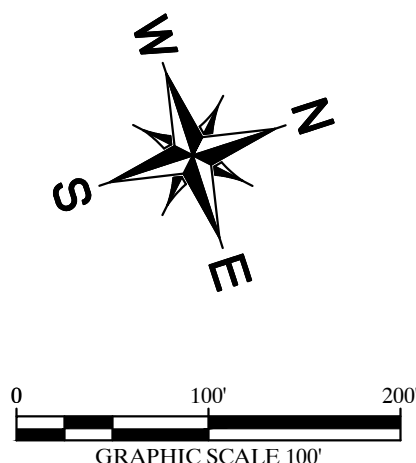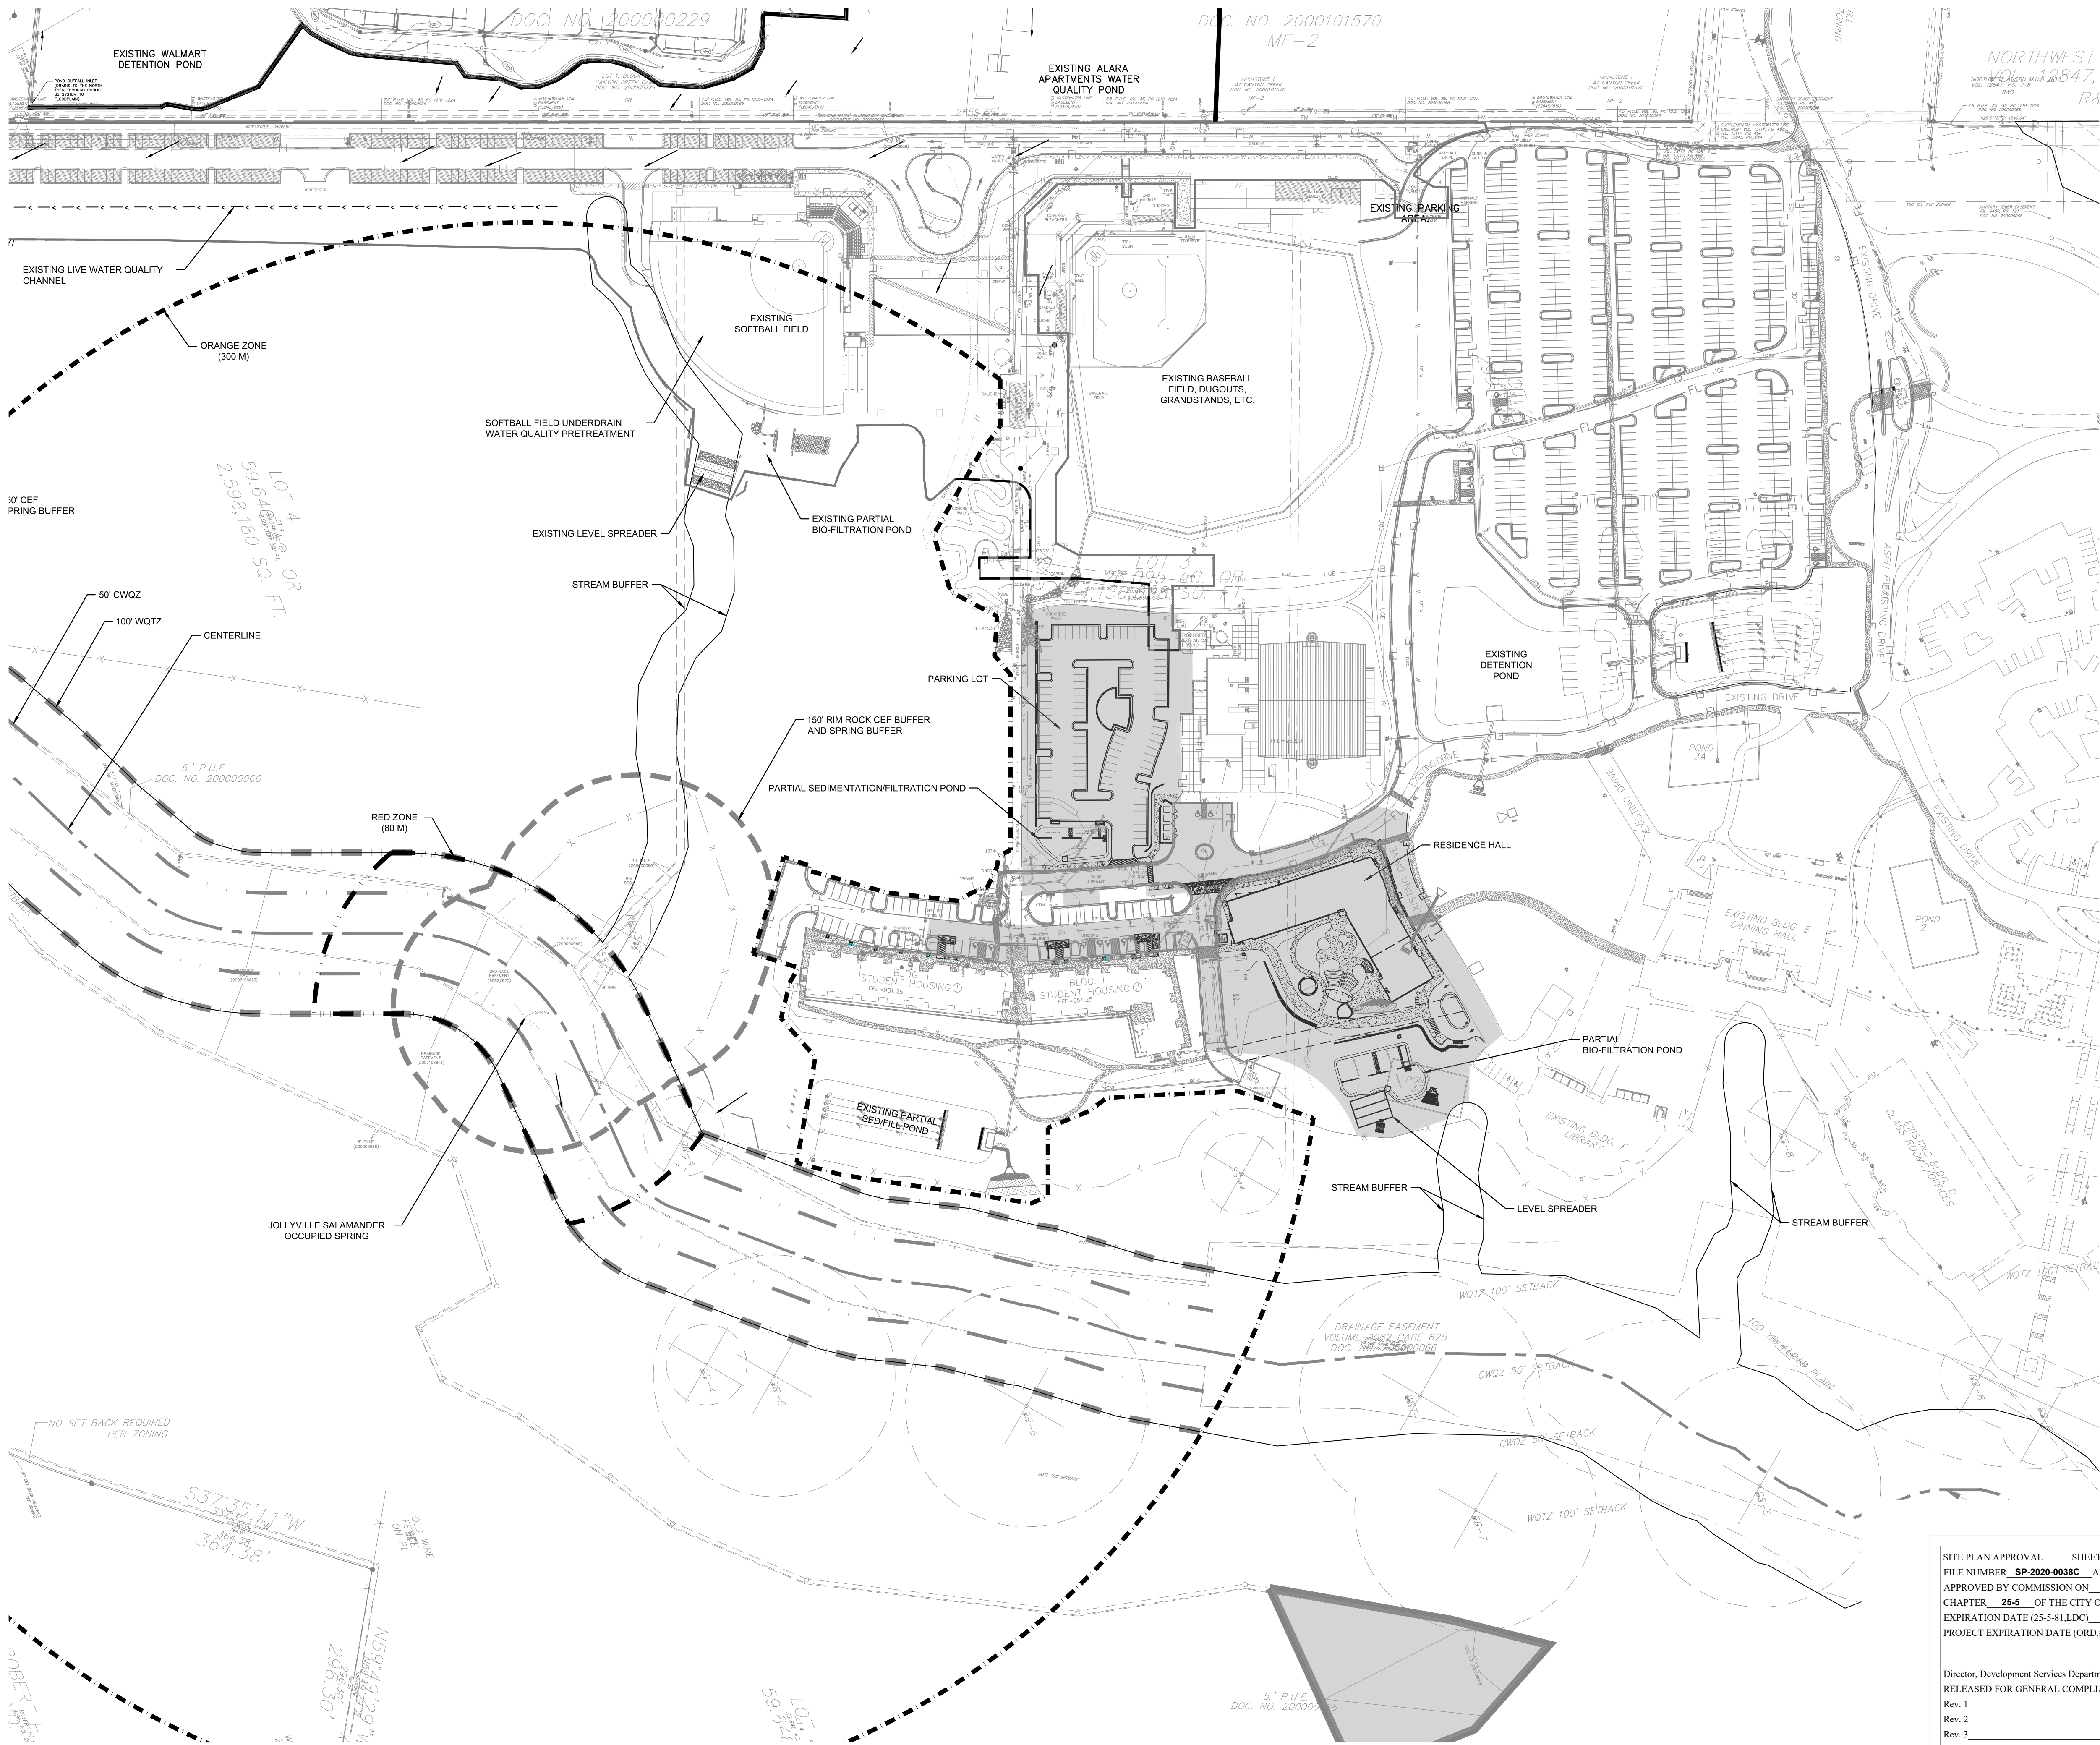

LEGEND

LIMITS OF CONSTRUCTION

ENDANGERED SPECIES PROTECTION PLAN

THE JOLLYVILLE PLATEAU SALAMANDER OCCUPIES A SPRING LOCATED ON THE CONCORDIA UNIVERSITY TEXAS PROPERTY AND IS LOCATED +/-800 FEET WEST OF THE SOFTBALL FIELD IN A NATURAL DRAINAGE CHANNEL LOCATED IN EXISTING PRESERVE LANDS OWNED BY CONCORDIA AND MANAGED BY TRAVIS COUNTY.

THE ENGINEER, THE OWNER, AND ENVIRONMENTAL CONSULTANT, ACI, HAVE MET WITH USFWS AND THE CITY OF AUSTIN (COA) TO WORK TOGETHER IN DETERMINING AN EFFECTIVE SOLUTION FOR PROTECTING THE JOLLYVILLE PLATEAU SALAMANDER. THIS SALAMANDER IS LISTED AS AN ENDANGERED SPECIES. IMPLEMENTING THE MEASURES REQUIRED IN THE CITY OF GEORGETOWN'S WATER QUALITY MANAGEMENT PLAN (WQMP) EXHIBIT 'A' WAS DISCUSSED WITH THE USFWS AND CITY OF AUSTIN AS PROVIDING SUFFICIENT PROTECTION FOR THE SALAMANDER.

IN ORDER TO COMPLY WITH THE WQMP AND TO PROVIDE ADDITIONAL PROTECTION FOR THE SALAMANDER SPRING SITE, THE FOLLOWING HAS BEEN IMPLEMENTED INTO THIS SITE PLAN:

1. BUFFERS:

- NO DEVELOPMENT IS PROPOSED IN THE "RED ZONE." (80M UP AND DOWN STREAM FROM CENTER OF SPRING).
- THE DEVELOPMENT IS PROPOSED OUTSIDE OF THE "ORANGE ZONE" (300M FROM CENTER OF SPRING).
- 100-FOOT STREAM BUFFERS FROM CENTERLINE HAVE BEEN PROVIDED, WHICH COINCIDE WITH THE CITY OF AUSTIN WATER QUALITY TRANSITION ZONE.

2. WATER QUALITY:

- A LIVE CHANNEL THAT MEETS THE TCEQ REQUIREMENTS FOR CHANNEL DESIGN HAS BEEN INCLUDED TO PROVIDE "PRETREATMENT" FOR THE ROADS AND THE BUILDING. THIS CHANNEL PROVIDES ADDITIONAL WATER QUALITY OVER AND ABOVE WHAT IS REQUIRED TO MEET CITY OF AUSTIN WATER QUALITY REQUIREMENTS.
- A PARTIAL/SEDIMENTATION FILTRATION POND HAS BEEN PROVIDED MEETING 100% OF THE REQUIRED WATER QUALITY FOR THE DEVELOPMENT OF THE ROADS AND THE BUILDING, MEETING CITY OF AUSTIN REQUIREMENTS.
- PARTIAL BIO-FILTRATION PONDS ARE PROVIDED MEETING 100% OF THE REQUIRED WATER QUALITY FOR THE DEVELOPMENT OF THE PARKING LOT, RESIDENCE HALL, AND ANCILLARY SITE IMPROVEMENTS, MEETING CITY OF AUSTIN REQUIREMENTS.
- EXTENSIVE LEVEL SPREADERS (INCLUDING DEEP ROOTED SWITCH GRASS, STILLING BASINS, AND BIG MUHLY) HAVE BEEN PROVIDED TO REDUCE VELOCITIES FROM CONVEYANCE AREAS DISCHARGING CONCENTRATED RUNOFF.

3. WATER QUANTITY:

- OFFSITE FLOWS ARE CONVEYED THROUGH THE SITE FOLLOWING NATURAL DRAINAGE PATTERNS AS MUCH AS PRACTICABLE.

BENCHMARKS

BM #50003 MAG NAIL SET IN TOP OF CURB ON A CIRCULAR MEDIAN LOCATED AT THE INTERSECTION OF TWO DRIVEWAYS 8' NORTHWEST OF A FLAG POLE AND 36' NORTHWEST OF A WASTEWATER MANHOLE.

- ELEV.=957.97' (NAVD '88)

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- ELEV.=940.28' (NAVD '88)






Know what's below.
Call before you dig.

WARNING: CONTRACTOR IS TO VERIFY PRESENCE AND EXACT LOCATION OF ALL UTILITIES PRIOR TO CONSTRUCTION.


SITE PLAN APPROVAL SHEET 20 OF 43	
FILE NUMBER SP-2020-0038C APPLICATION DATE 1/31/2020	
APPROVED BY COMMISSION ON UNDER SECTION 112 OF CHAPTER 25-5 OF THE CITY OF AUSTIN CODE.	
EXPIRATION DATE (25-5-81.LDC) CASE MANAGER JEREMY SILTALA	
PROJECT EXPIRATION DATE (ORD#970905-A) DWFPZ DDZ	
Director, Development Services Department	
RELEASED FOR GENERAL COMPLIANCE: ZONING R&D-PDA	
Rev. 1	Correction 1
Rev. 2	Correction 2
Rev. 3	Correction 3
Final plat must be recorded by the Project Expiration Date, if applicable. Subsequent Site Plans which do not comply with the Code current at the time of filing, and all required Building Permits and/or a notice of construction (if a building permit is not required), must also be approved prior to the Project Expiration Date.	

Kimley»Horn	
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7/27/2020	
KHA PROJECT 069229503	DATE JULY 2020
SCALE: AS SHOWN	DESIGNED BY: JCL
DRAWN BY: JCL	CHECKED BY: BEH
JOLLYVILLE PLATEAU SALAMANDER PROTECTION PLAN	
CONCORDIA UNIVERSITY RESIDENCE HALL CITY OF AUSTIN TRAVIS COUNTY, TEXAS	
SHEET NUMBER 20 OF 43	

Plotted By: Lytle, Jack Date: June 29, 2020 10:15:50am File Path: Z:\Project\AUS_Civil\069229503 Concordia Master Plan\069273300 Residence Hall\ConcExhibits\PlanSheets\Context Map.dwg
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---	PROPERTY LINE
---	LIMITS OF CONSTRUCTION

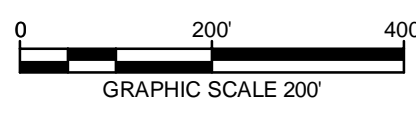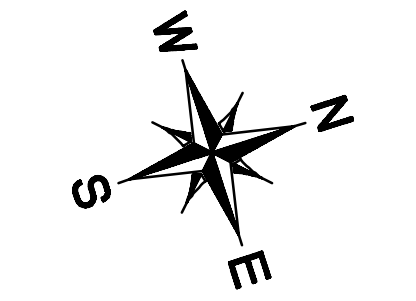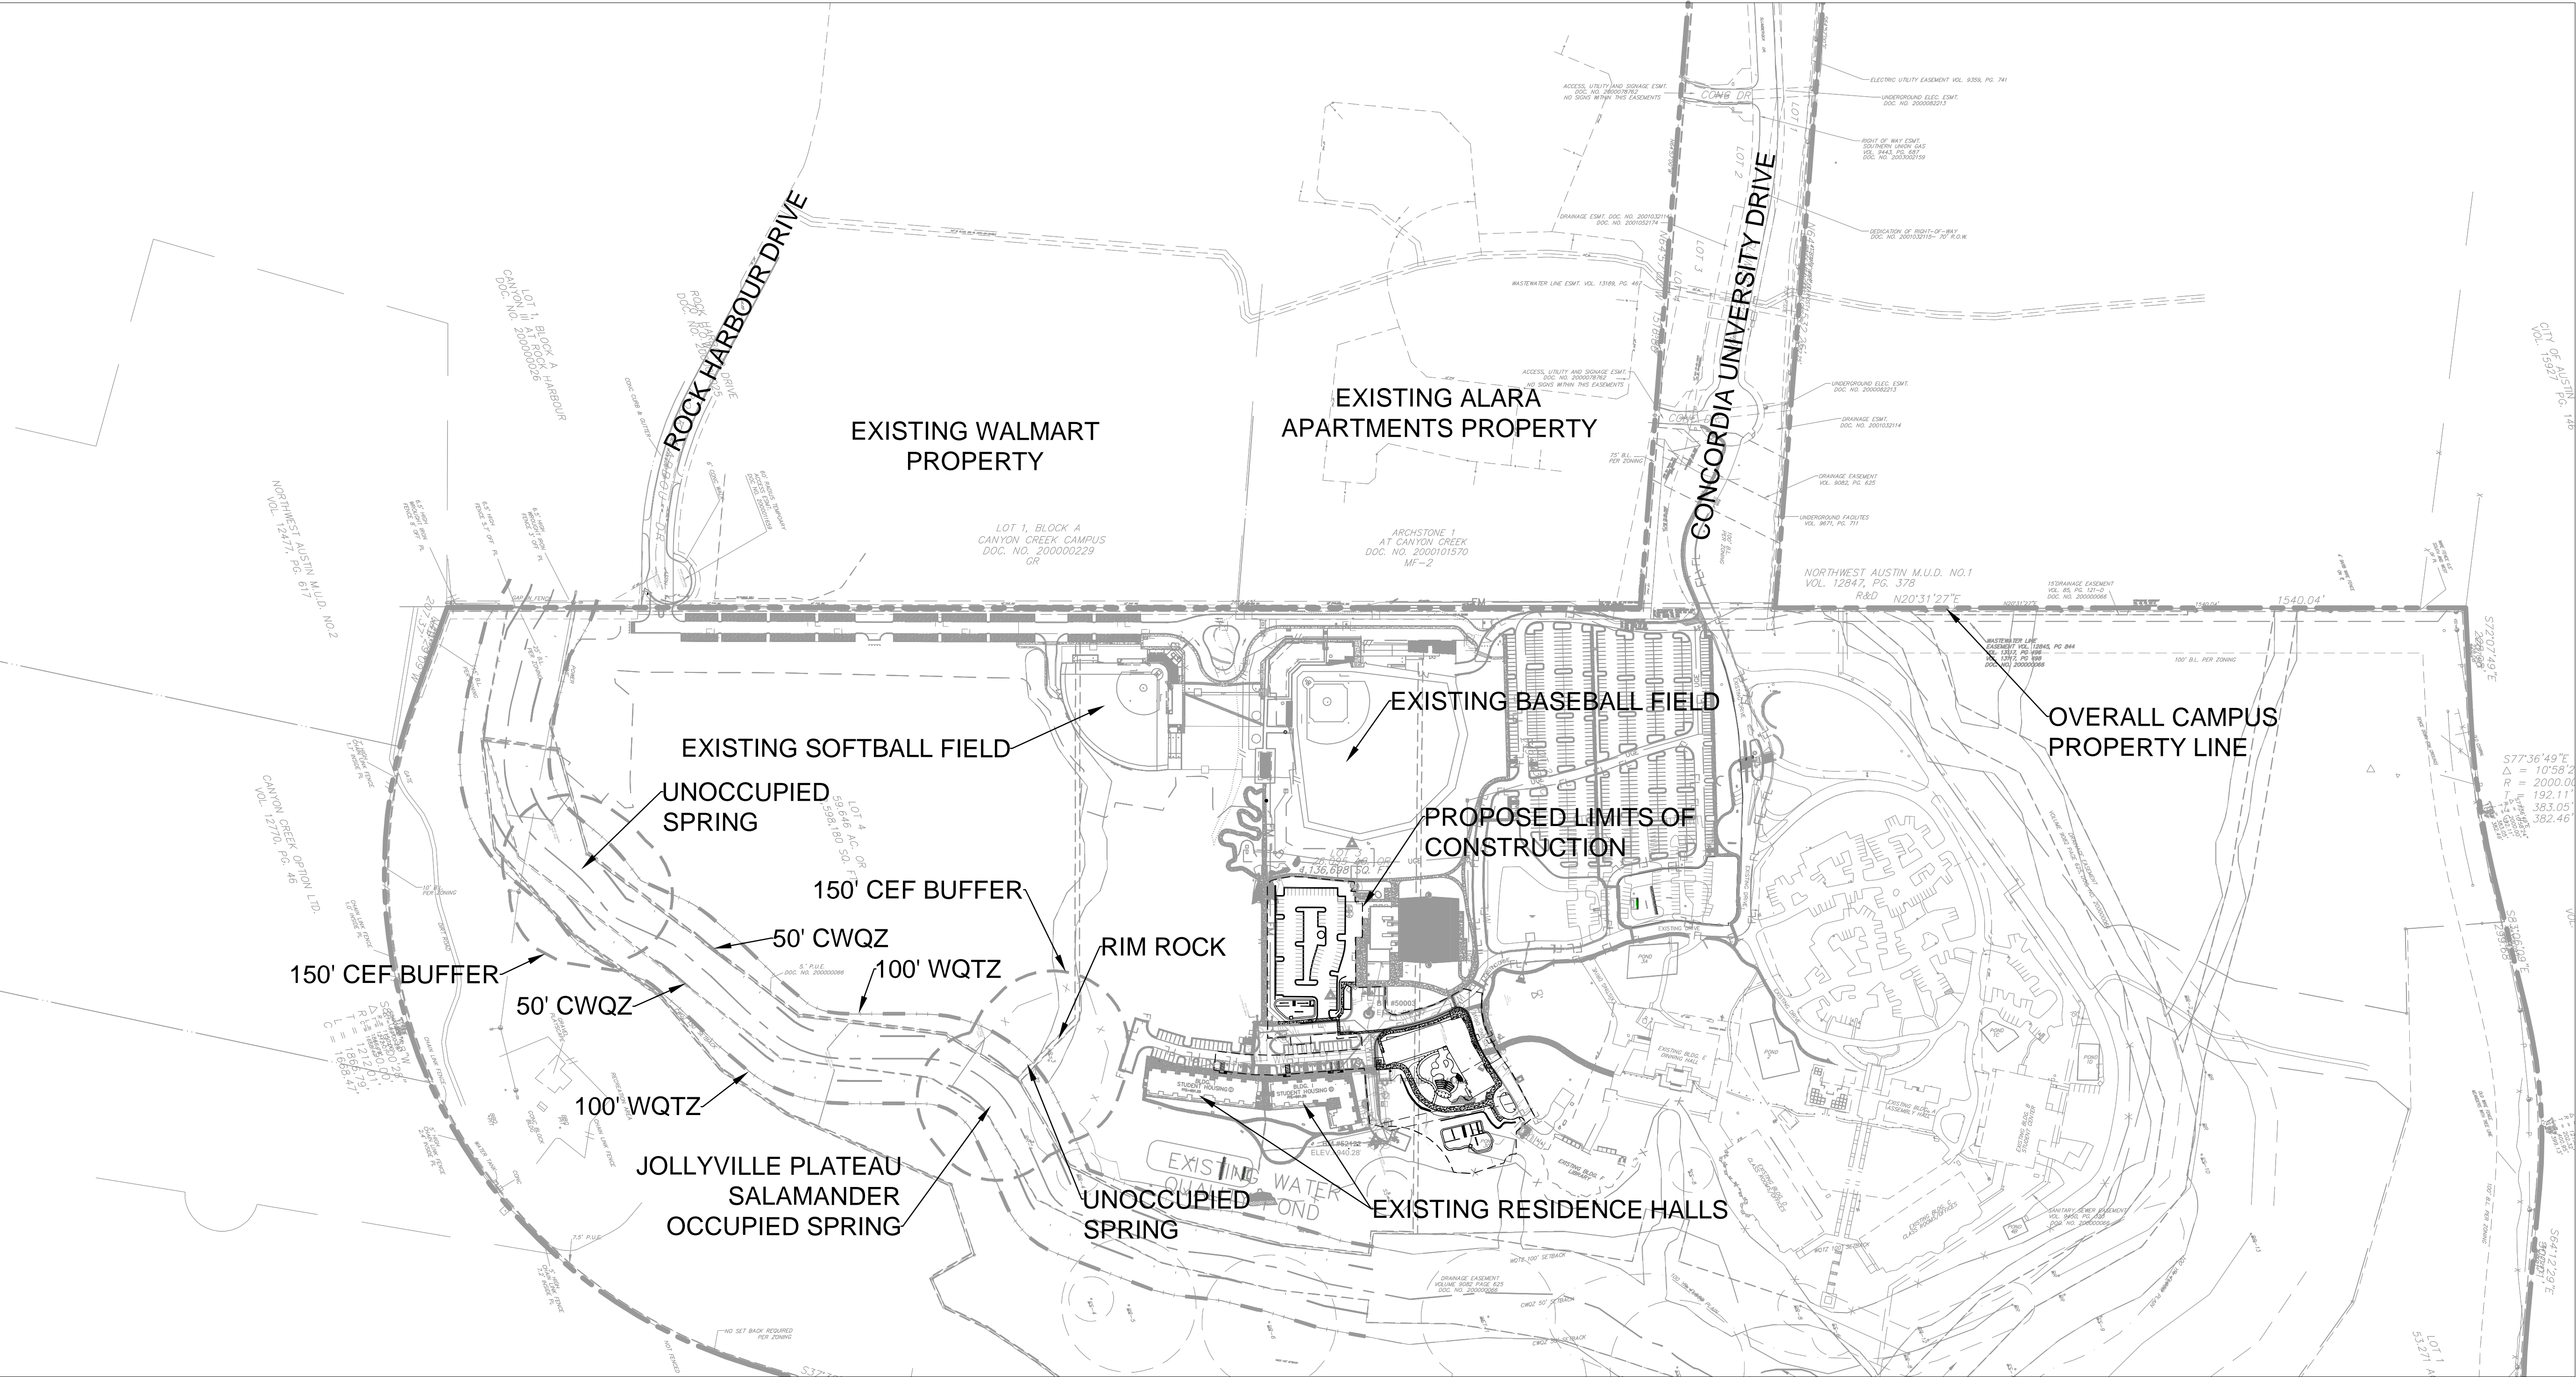

CONTEXT MAP

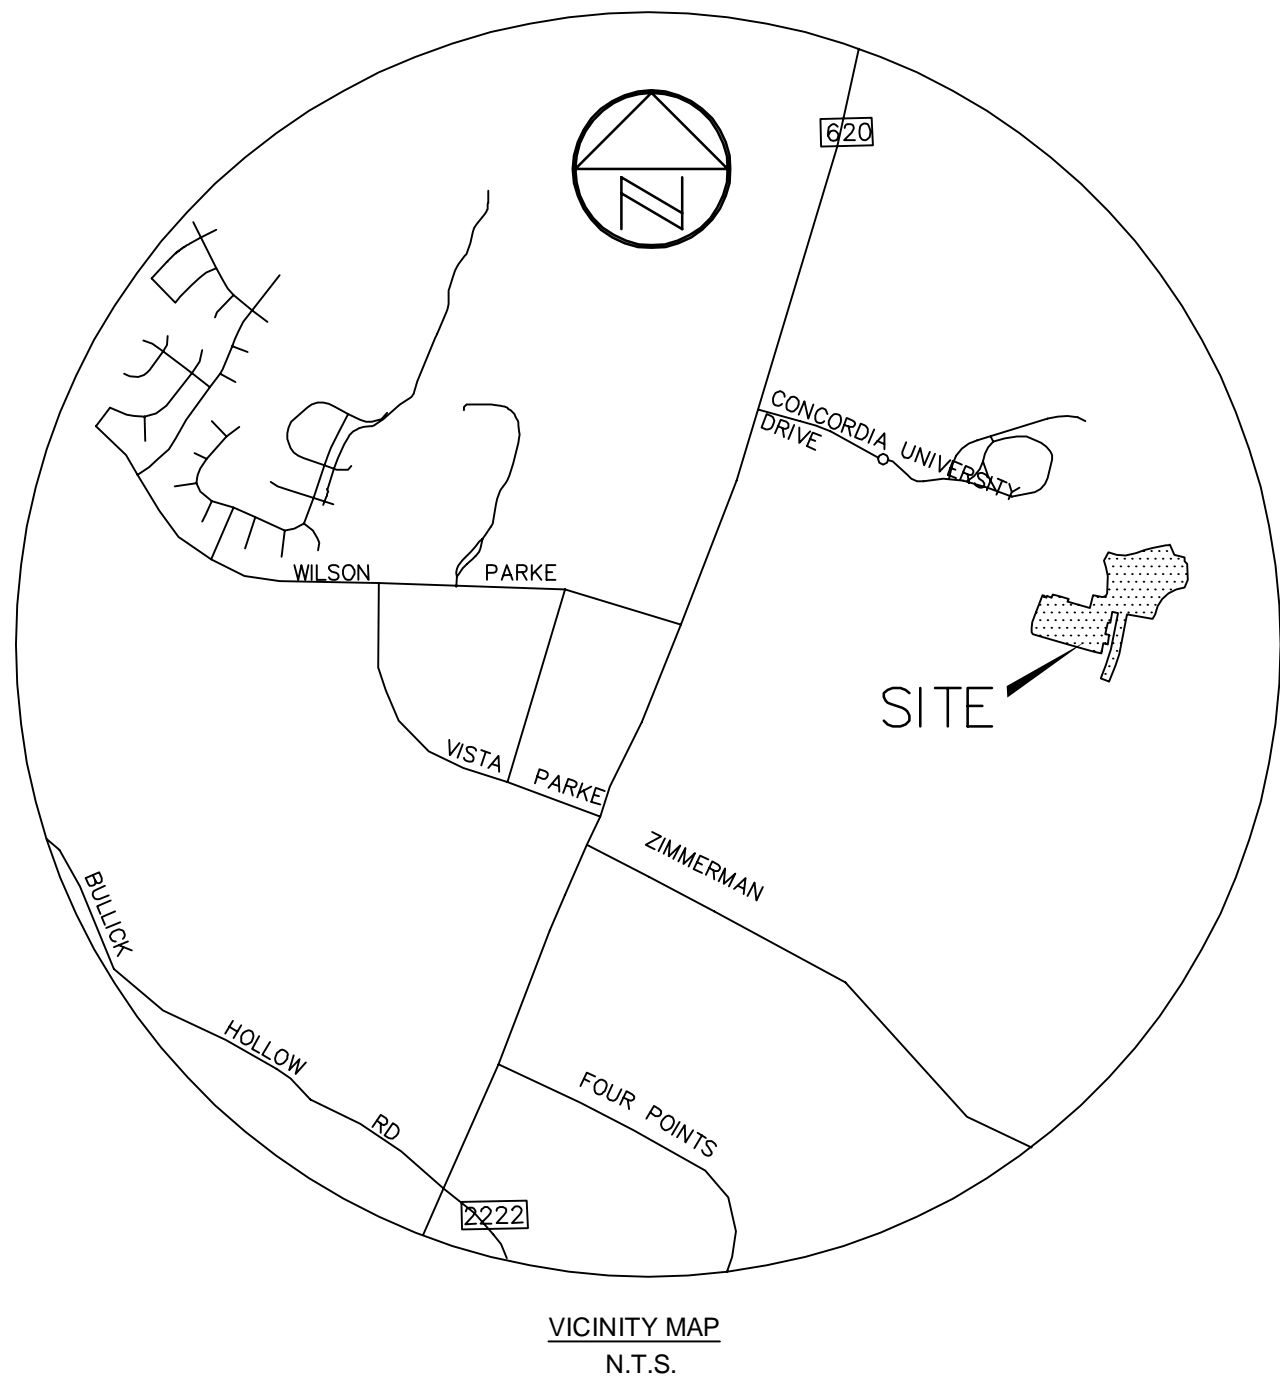Concordia Unviersity Residence Hall

July 2020

Kimley»Horn

NOTE: THIS PLAN IS CONCEPTUAL IN NATURE AND HAS BEEN PRODUCED WITHOUT THE BENEFIT OF A SURVEY. TOPOGRAPHY, UTILITIES, CONTACT WITH THE CITY, ETC.



October 20, 2020

City of Austin
Planning and Development Review Department
505 Barton Springs Road
Austin, TX 78767

**Re: Variance Request Letter – Cut
Concordia University Residence Hall - Site Plan Application SP-2020-0038C
11400 Concordia University Drive
Austin, Texas 78726**

To Whom It May Concern:

INTRODUCTION

Please accept this letter as a request for a variance to the Lake Austin Ordinance #840301-F, Sections 9-10-409(A) and 9-10-409(B) for a max cut of +/- 8.74 ft for the above referenced project.

PROJECT DESCRIPTION

The Concordia University Texas campus is an existing campus located at 11400 Concordia University Drive in northwest Austin, Texas and Travis County. The existing property is approximately 383 acres including approximately 250 acres of preserve land. The campus has existing improvements including buildings, athletic facilities, private drives, underground utilities storm drains, stormwater ponds, and auxiliary improvements.

The proposed campus improvements include a 4-story residence hall building, associated parking lot, outdoor amphitheater area, pedestrian improvements, two water quality and detention ponds, and associated site improvements. This project is located within the Bull Creek Watershed, classified as a Water Supply Suburban Watershed. The site is located within the Edwards Aquifer Recharge Zone according to the City of Austin GIS. Critical water quality zones, water quality transition zones, and critical environmental features are located on the southern and eastern portion of the site. No development will occur in these locations. The terrain is heavily wooded and has some grass cover.


No requests for a variance to CEF buffers, WQTZ or CWQZ areas are being requested. If you have any questions or comments regarding this request, please contact me at 512-271-6314.

Sincerely,



Brandon Hammann, P.E., LEED AP
Project Manager

Plotted By: Lyle, Jack Date: July 27, 2020 08:14:44am File Path: K:\AUS_Civil\069229503_Corcordia Master Plan\069229503_RESIDENCE HALL\069229503_EROSION AND SEDIMENTATION CONTROL AND TREE PROTECTION PLAN.dwg
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LEGEND

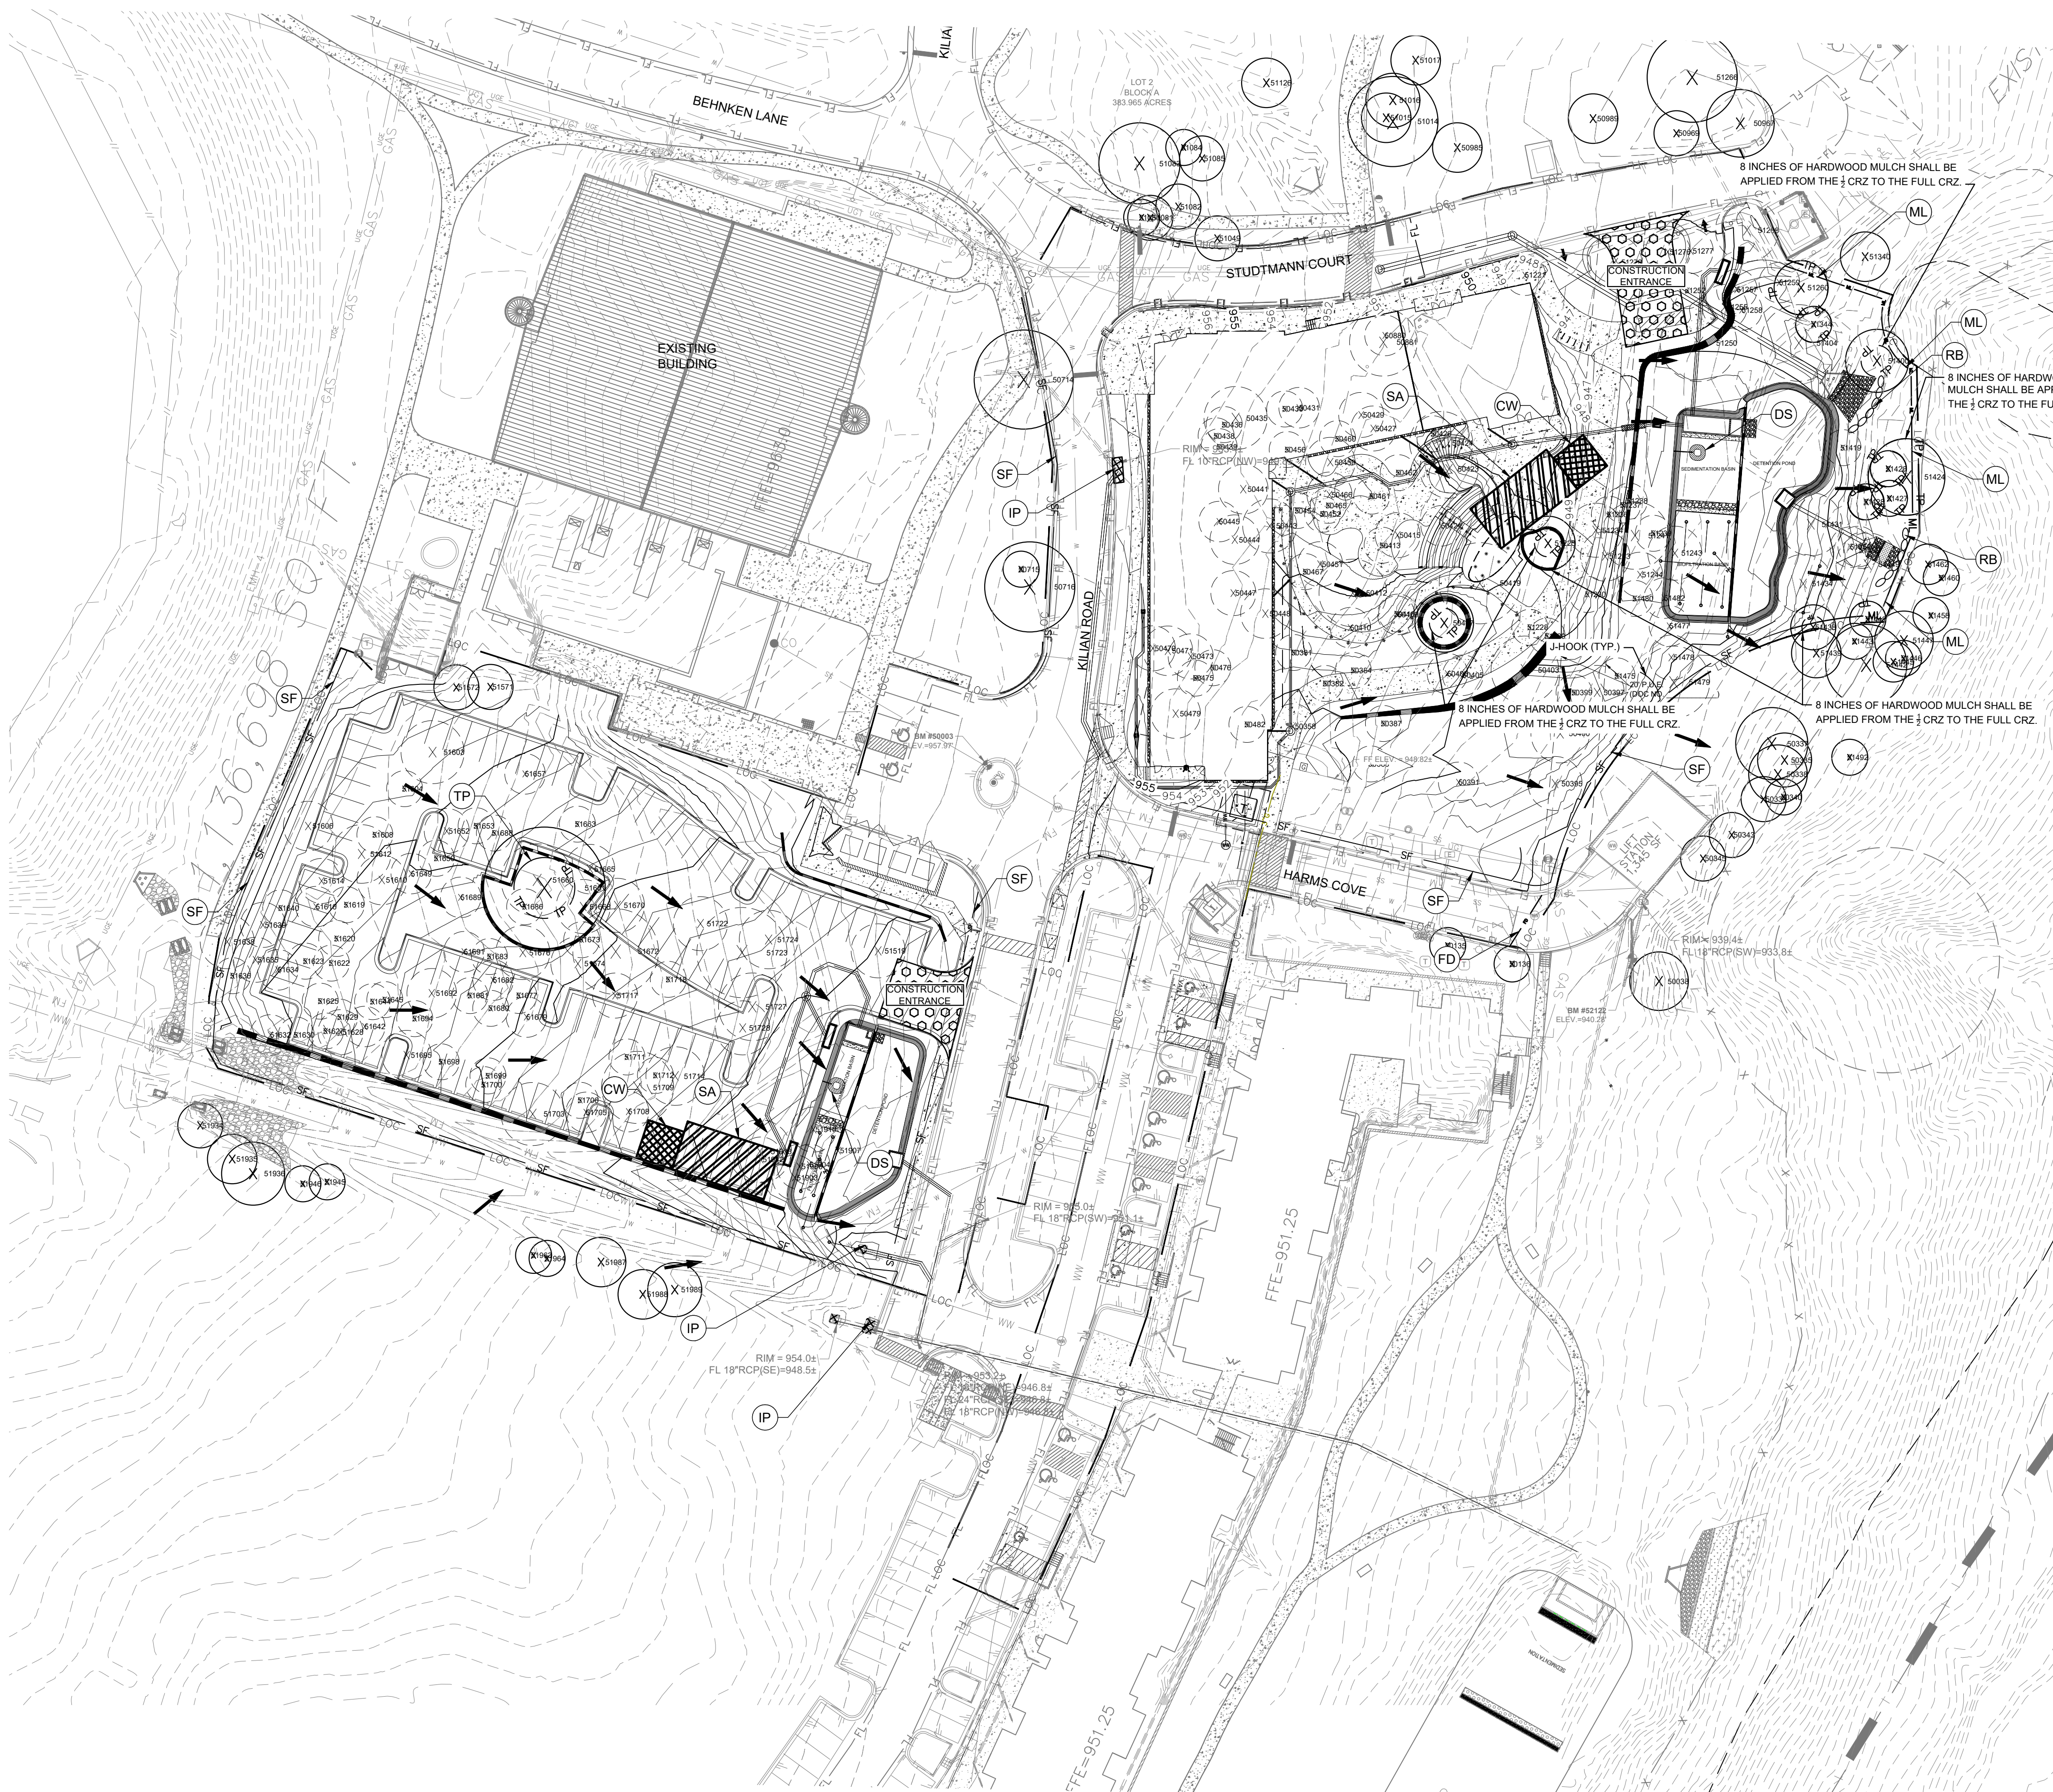710	EXISTING CONTOUR
710	PROPOSED CONTOUR
LOC	LIMITS OF CONSTRUCTION
SF	SILT FENCE - SEE DETAIL ON SHEET 11.
CE	CONSTRUCTION ENTRANCE - SEE DETAIL ON SHEET 11.
SA	STAGING AND SPOILS AREA
CW	CONCRETE WASHOUT PIT - SEE DETAIL ON SHEET 11.
TP	TREE PROTECTION - SEE DETAIL ON SHEET 11.
IP	INLET PROTECTION - SEE DETAIL ON SHEET 11.
FD	TRIANGULAR FILTER DIKE - SEE DETAIL ON SHEET 11.
DS	DEWATERING SKIMMER - SEE DETAIL ON SHEET 11.
ML	MULCH SOCK - SEE DETAIL ON SHEET 11.
	TREE TO REMAIN
	TREE TO BE REMOVED

- NOTES:**
- REFER TO EROSION AND SEDIMENTATION CONTROL AND TREE PROTECTION DETAILS, SHEET 11.
 - ALL TREES 8" AND GREATER IN SIZE HAVE BEEN SURVEYED. ONLY THOSE TREES 19" AND LARGER ARE CONSIDERED PROTECTED PER ORDINANCE NO. 63-0324-N, AND CROSS-REFERENCED IN THE PDA ORDINANCE FOR THIS PROPERTY (850131-Q).
 - CONTRACTOR IS RESPONSIBLE FOR IMPLEMENTATION, MAINTENANCE, AND EFFECTIVENESS OF ALL SWPPP CONTROLS - CONTROLS SHOWN ON THIS SITE MAP ARE SUGGESTED CONTROLS ONLY.
 - CONTRACTOR SHALL RECORD INSTALLATION, MAINTENANCE, OR MODIFICATION, AND REMOVAL DATES FOR EACH BMP EMPLOYED (WHETHER CALLED OUT ON ORIGINAL SWPPP OR NOT) DIRECTLY ON THE SITE MAP.
 - THE ENVIRONMENTAL INSPECTOR HAS THE AUTHORITY TO ADD AND/OR MODIFY EROSION/SEDIMENTATION CONTROLS ON SITE TO KEEP PROJECT IN COMPLIANCE WITH THE CITY OF AUSTIN RULES AND REGULATIONS (LDC 25-6-183).
 - CONTRACTOR SHALL UTILIZE DUST CONTROL MEASURES DURING SITE CONSTRUCTION SUCH AS IRRIGATION TRUCKS AND MULCHING AS PER ECM 1.4.3(A) OR AS DIRECTED BY THE ENVIRONMENTAL INSPECTOR.
 - TEMPORARY AND PERMANENT STABILIZATION PRACTICES AND BMPs SHALL BE INSTALLED AT THE EARLIEST POSSIBLE TIME DURING THE CONSTRUCTION SEQUENCE. AS AN EXAMPLE, PERIMETER SILT FENCE SHALL BE INSTALLED BEFORE COMMENCEMENT OF ANY GRADEING ACTIVITIES. OTHER BMPs SHALL BE INSTALLED AS SOON AS PRACTICABLE AND SHALL BE MAINTAINED UNTIL FINAL SITE STABILIZATION IS ATTAINED.
 - CONTRACTOR SHALL ALSO REFERENCE CIVIL AND LANDSCAPE PLANS SINCE PERMANENT STABILIZATION IS PROVIDED BY LANDSCAPING (THE BUILDING(S), AND SITE PAVING).
 - BMPs HAVE BEEN LOCATED AS INDICATED ON THIS PLAN IN ACCORDANCE WITH GENERALLY ACCEPTED ENGINEERING PRACTICES IN ORDER TO MINIMIZE SEDIMENT TRANSFER. FOR EXAMPLE: SILT FENCES LOCATED AT TOE OF SLOPE AND INLET PROTECTION FOR INLETS RECEIVING SEDIMENT FROM SITE RUN-OFF.
 - ADDITIONAL EROSION AND SEDIMENTATION CONTROLS MAY BE REQUIRED BY THE CITY DURING CONSTRUCTION.
 - IF DISTURBED AREA IS NOT TO BE WORKED ON FOR MORE THAN 14 DAYS, DISTURBED AREA NEEDS TO BE STABILIZED BY REVEGETATION, MULCH, TARP OR REVEGETATION MATTING [ECM 1.4.4.B.3, SECTION 5, I].
 - THE CONTRACTOR WILL CLEAN UP SPOILS THAT MIGRATE ONTO THE ROADS A MINIMUM OF ONCE DAILY [ECM 1.4.4.D.4].
 - USE J-HOOKS WHERE SILT FENCE CANNOT BE INSTALLED PARALLEL TO THE EXISTING CONTOURS.
 - THE CONTRACTOR WILL CLEAN UP SPOILS THAT MIGRATE ONTO THE ROADS A MINIMUM OF ONCE DAILY. [ECM 1.4.4.D.4].
 - INLET PROTECTION GEOTEXTILE FABRIC SHALL MEET THE SPECIFICATIONS LISTED IN SECTION 1.4.5.9, INLET PROTECTION, OF THE CITY OF AUSTIN ENVIRONMENTAL CRITERIA MANUAL.
 - CONTRACTOR SHALL BE RESPONSIBLE FOR SUBMITTAL OF N.O.I., N.O.T. AND ANY ADDITIONAL INFORMATION REQUIRED BY THE TCEQ CONTRACTOR SHALL COMPLY WITH ALL TCEQ STORMWATER POLLUTION PREVENTION REQUIREMENTS.
 - INSPECTIONS SHALL BE MADE WEEKLY AND AFTER RAIN STORM EVENTS TO INSURE THAT THE DEVICES ARE FUNCTIONING PROPERLY. WHEN SEDIMENT OR MUD HAS CLOGGED THE VOID SPACES BETWEEN STONES OR MUD IS BEING TRACKED ONTO A PUBLIC ROADWAY THE AGGREGATE PAD MUST BE WASHED DOWN OR REPLACED. RUNOFF FROM THE WASH DOWN OPERATION SHALL NOT BE ALLOWED TO DRAIN DIRECTLY OFF SITE WITHOUT FIRST FLOWING THROUGH ANOTHER BMP TO CONTROL OFF SITE SEDIMENTATION. PERIODIC RE-GRAIDING OR THE ADDITION OF NEW STONE MAY BE REQUIRED TO MAINTAIN THE EFFICIENCY OF THE DEVICES.
 - EROSION CONTROL DEVICES SHOWN ON THIS PLAN SHALL BE INSTALLED PRIOR TO THE START OF LAND DISTURBING ACTIVITIES ON THE PROJECT.
 - ALL EROSION CONTROL DEVICES ARE TO BE INSTALLED IN ACCORDANCE WITH THE APPROVED PLANS FOR THIS PROJECT, AND NCTCOG SPECIFICATIONS. CHANGES ARE TO BE APPROVED BEFORE CONSTRUCTION BY THE DESIGN ENGINEER AND THE CITY/COUNTY ENGINEERING DIVISION.
 - IF THE EROSION CONTROL PLAN APPROVED CANNOT CONTROL EROSION AND OFF-SITE SEDIMENTATION FROM THE PROJECT, THE EROSION CONTROL PLAN WILL BE REQUIRED TO BE REVISED AND/OR ADDITIONAL EROSION CONTROL DEVICES WILL BE REQUIRED ON SITE.
 - OFF-SITE BORROW AND SPOIL AREAS ARE CONSIDERED AS PART OF THE PROJECT SITE, AND MUST ALSO COMPLY WITH THE EROSION CONTROL REQUIREMENTS FOR THIS PROJECT. THIS INCLUDES THE INSTALLATION OF BMPs TO CONTROL OFFSITE SEDIMENTATION AND THE ESTABLISHMENT OF PERMANENT GROUND COVER ON DISTURBED AREAS PRIOR TO FINAL APPROVAL OF THE PROJECT.
 - IN ORDER TO COMPLY WITH THE UNITED STATES ENVIRONMENTAL PROTECTION AGENCY AND ALL OTHER AGENCIES HAVING JURISDICTION, THE CONTRACTOR SHALL PROVIDE ANY ADDITIONAL EROSION OR POLLUTION DEVICES, AS REQUIRED, DURING CONSTRUCTION. FILING OF N.O.I. (PER TCEQ REQUIREMENTS) SHALL BE RESPONSIBILITY OF THE CONTRACTOR AND THE OWNER.
 - TREES PROPOSED TO BE PRESERVED MUST MEET THE FOLLOWING CRITERIA:
 - A MINIMUM OF 50% OF THE CRITICAL ROOT ZONE MUST BE PRESERVED AT NATURAL GRADE, WITH NATURAL GROUND COVER.
 - CUT OR FILL IS LIMITED TO 4 INCHES FROM THE 1/2 CRITICAL ROOT ZONE TO THE 1/2 CRITICAL ROOT ZONE; AND NO CUT OR FILL IS PERMITTED WITHIN THE 1/2 CRITICAL ROOT ZONE.
 - CONTRACTOR SHALL MAINTAIN THE DEWATERING SYSTEM TO ENSURE PERFORMANCE. IF THE DEWATERING SYSTEM IS NOT PERFORMING, THE CONTRACTOR MUST IMMEDIATELY MAKE THE NECESSARY MODIFICATIONS, FOLLOWING THE ENVIRONMENTAL INSPECTOR'S DIRECTION TO ENSURE ADEQUATE SYSTEM PERFORMANCE. CONTRACTOR SHALL PROVIDE THE DEWATERING PLAN AT THE PRECONSTRUCTION MEETING.
 - THE CONTRACTOR IS RESPONSIBLE FOR REMOVING ANY SEDIMENT TRANSPORTED FROM THE LOC TO THE OFFSITE DETENTION/WATER QUALITY POND(S).
 - NO AREAS IN EXCESS OF 2:1 SLOPES ARE ANTICIPATED POST-CONSTRUCTION.

BENCHMARKS

- BM #50003 MAG NAIL SET IN TOP OF CURB ON A CIRCULAR MEDIAN LOCATED AT THE INTERSECTION OF TWO DRIVEWAYS 81' NORTHWEST OF A FLAG POLE AND 361' NORTHWEST OF A WASTEWATER MANHOLE.
- ELEV = 957.97' (NAVD '88)
- BM #52122 MAG NAIL SET IN THE MIDDLE OF A CONCRETE WALL SOUTH ON THE LIFT STATION 25+ SOUTH OF A STORM SEWER MANHOLE ON A CURB INLET AND 471'2" SOUTHEAST OF A WASTEWATER MANHOLE.
- ELEV = 940.28' (NAVD '88)

SITE PLAN APPROVAL SHEET 10 OF 43
FILE NUMBER **SP-2020-0038C** APPLICATION DATE **1/31/2020**
APPROVED BY COMMISSION ON _____ UNDER SECTION **112** OF CHAPTER **25-5** OF THE CITY OF AUSTIN CODE.
EXPIRATION DATE (25-5-81.LDC) CASE MANAGER **JEREMY SILTALA**
PROJECT EXPIRATION DATE (ORD#970905-A) DWPZ _____ DDZ _____

Director, Development Services Department
RELEASED FOR GENERAL COMPLIANCE: _____ ZONING **R&D-PDA**
Rev. 1 _____ Correction 1 _____
Rev. 2 _____ Correction 2 _____
Rev. 3 _____ Correction 3 _____

Final plan must be recorded by the Project Expiration Date, if applicable. Subsequent Site Plans which do not comply with the Code current at the time of filing, and all required Building Permits and/or a notice of construction (if a building permit is not required), must also be approved prior to the Project Expiration Date.



WARNING: CONTRACTOR IS TO VERIFY PRESENCE AND EXACT LOCATION OF ALL UTILITIES PRIOR TO CONSTRUCTION.

EROSION AND SEDIMENTATION CONTROL AND TREE PROTECTION PLAN

CONCORDIA UNIVERSITY RESIDENCE HALL CITY OF AUSTIN TRAVIS COUNTY, TEXAS

SHEET NUMBER
10 OF 43

Kimley»Horn

10814 JOLLYVILLE ROAD AVALON IV SUITE 200 AUSTIN, TX 78759
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TPE Firm No. 928



KHA PROJECT	DATE	SCALE	DESIGNED BY	DRAWN BY	CHECKED BY
069229503	JULY 2020	AS SHOWN	JCL	JCL	BEH

REVISIONS

No.

DATE

BY