




1 FRONT ELEVATON

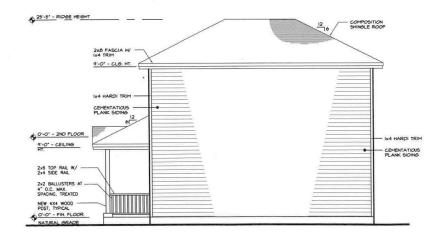

RIGHT ELEVATION

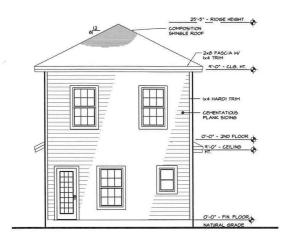

2 REAR ELEVATION

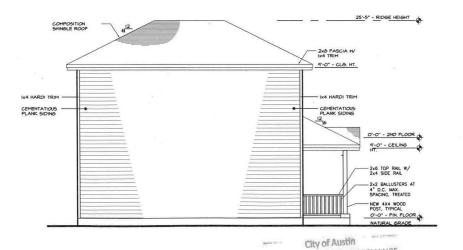

REVIEWED FOR CODE COMPLIANCE

LEFT ELEVATION
SCALE: 1/8"=1"-0"



RB ARCHITECT 3

REVISIONS

ROEL BAZAN, AIA

11502 Kripp Cove Austin, Texas 78739 (512) 791-2986

Salazar Residence 2810 Gonzales St. Austin, Texas 78702 ELEVATIONS


The design group

1301 S. IH 35, Suite 315 Austin, Texas 78704 Mobile: 512 584 0211 e-mail: rduranjr.atx@gmail

ATX DATE: 10/8/2018 SCALE: 1/8"=1'-0" DRAWN: RD/MAD

FILE:C/OMGS/SALAZAR RES/ SHEET 2 A2

9 SHEETS

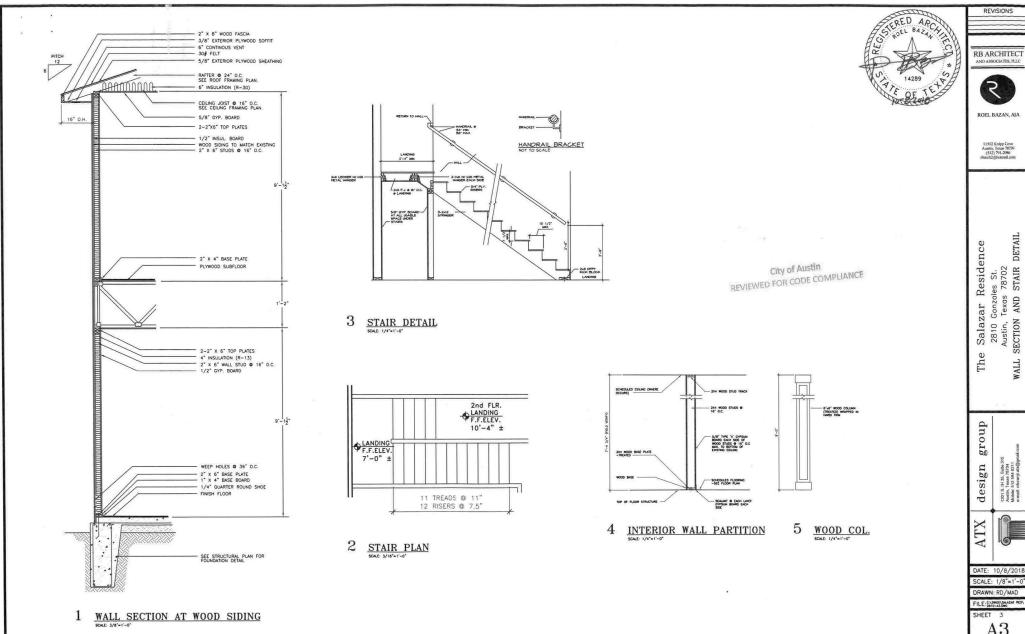

REVISIONS RB ARCHITECT
AND ASSOCIATES, PLLC

3

ROEL BAZAN, AIA

11502 Knipp Cove Austin, Texas 78739 (512) 791-2986 rbarch2@hotmail.com

DETAIL

1301 S. IH 35, Suke 315 Austin, Texas 78704 Mobile: 512 584 0211 e-mail: rduranjr.atx@gma

WALL

DATE: 10/8/2018 SCALE: 1/8"=1'-0"


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A3


9 SHEETS



City of Austin REVIEWED FOR CODE COMPLIANCE

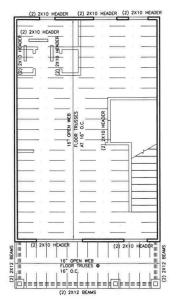

FIRST FLOOR FRAMING PLAN

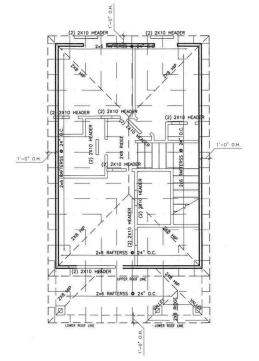

ROOF FRAMING PLAN

CEILING JOISTS SPAN CHARTS & NOTES

20.732.7730	LIMITED AT	TIC STORAGE	
SIZE	24" O.C.	16" O.C.	12" O.C.
2×6	10'-10"	13'-1"	15'-2"
2×8	14'-3"	17'-3"	19'-11"
2×10	18'-3"	22'-1"	25'-5"

NOTE: USES NOTED ORIGINATE: ALL JOST TO BE \$2 MOYP - UNIXES NOTED ORIGINATE: ALL JOST TO BE \$7 MOYP - UNIXES NOTED ORIGINATE: ALL JOST ALL

ROOF FRAMING SPAN CHARTS & NOTES

SIZE	24" O.C.	16" O.C.	12" O.C
2×6	11'-5"	14'-0"	16'-2"
2×8	15'-1"	18'-5"	21'-4"
2×10	19'-3"	23'-7"	27'-2"

SIZE	24" O.C.	16" O.C.	12" O.C.
2×6	10'-0"	12'-4"	14'-2"
2x8	13'-3"	16'-3"	18'-9"
2×10	16'-11"	20'-8"	23'-11"
2x12	20'-6"	25'-2"	29'-1"

REQUIRED.

A. BUILDER TO VERIFY SIZING AND SPACING OF JOIST AND BEAMS PRIOR TO CONSTRUCTION.

S. UNLESS NOTED OTHERWISE: ALL JOIST TO BE 2x6's 0 24' O.C. WITH NO ATTIC STORAGE UNLESS NOTED.

LOCOL Structural and Environmental Engineers Texas Registered Engineering Firm F-47356 Austra 1772 - 1773 (1772 - 1772 (1772 (1772 - 1772 (177

REVISIONS

Salazar Residence 2810 Gonzales St. Austin, Texas 78702 Framing Plans

The

design group 1301 S. JH 35, Suite 315 Austin, Texas 78741 Mobile: 512 584 0211 e-mail: rduranir atx@gamai

ATX

DATE: 10/8/2018 SCALE: 1/8"=1'-0" DRAWN: AAB

FILE: C-LOWOS-SALAZAR RES SHEET 4 A4

OF 9 SHEETS


TIMBER GENERAL NOTES

- UNLESS OTHERWISE NOTED, ALL STRUCTURAL FRAMING LUMBER SHALL BE #2 SOUTHERN PINE, CLEARLY MARKED IN CONFORMANCE WITH SPECIFICATION REQUIREMENTS.
 ALL WOOD HEADERS, BEAMS, AND TOP PLATE SHALL BE SELECTED STRUCTURAL DOUGLAS FER-AGRIC HULESS DETAILED OTHERWISE
- ALL WOOD STUD WALLS SHALL BE #2 SOUTHERN PINE AND SHALL BE FULL HEIGHT WITHOUT INTERMEDIATE PLATE LINE, UNLESS DETAILED OTHERWISE.
- UNLESS DE FIRED TO TREMME:

 SOULD ZO BLOCKING SHALL BE PROVIDED AT END AND POINT OF SUPPORT OF ALL WOOD JOISTS AND SHALL BE PLACED BETWEEN SUPPORTS IS ROOMS NOT SECREDING FOR APPIR, ALL WALLS SHALL HAVE SOULD ZO BLOCKING AT 4-70 C. MANDIAU WERTHOLLY, END NALL, WITH 2-160 PAULS OF SIDE TO BHALL WITH 2-160 PAULS.
- SALL FRAMING MEMBERS FRAMING INTO THE SIDE OF A HEADER SHALL BE ATTACHED USING METAL, JOIST HANGER OF TYPE "HUTF" AS MANUFACTURED BY SIMPSON COMPANY OR EQUAL. THE HANGES SHALL BE SIZED ON INTALLED IN ACCORDANCE WITH THE MANUFACTURERS RECOMENDATIONS FOR THE SIZE OF JOIST SUPPORTED.
- FOR THE SIZE OF A STATE OF THE STATE OF THE SIZE OF TH
- ALL CORNERS OF WALL FRAMING SHALL BE BRACED BY ONE OF THE FOLLOWING METHODS:
- A 4 X 8 X 1/2" PLYWOOD DIAPHRAGM FROM THE TOP PLATE TO THE BOTTOM PLATE. PROVIDE SOUID BLOCKING AT JOINTS, AND NAIL WITH BD BOX NAILS AT 8" ON CENTER.
- PLACE A SINGLE PLATE AT THE BOTTOM (PRESSURE TRETED) AND A DOUBLE PLATE AT THE TOP OF ALL STUD WALLS.
- NALING AND ATTACHMENT OF ALL FRANKS MEMBERS SHALL BE AS SPECIFIED IN THE INTERNATIONAL BUILDING CODE FASTERING SCHEDULE TABLE 2304 S. I. UNLESS NOTED OTHERWISE IN THE DRAWINGS. COMMON WIRE NAILS OR SPIKES. OR GALVANZED BOX NAILS SHALL BE USED FOR ALL FRANKS UNLESS NOTED OTHERWISE
- 10. ALL BOLTS AND LAS SCREWS SHALL HAVE STANDARD WASHERS ALL ANCHOR AND EXPANSION BOLTS USED IN WOOD TO CONCRETE CONNECTIONS SHALL BE NOT ENGLANDED ON STANLESS STEEL CONTRESSEN BOLTS ANOLAG SCREWS UNLESS NOTEO OTHERWISE. NOT FOR "J" BOLT @ FUNDATION TO BASE PLATE.
- 11. REFER TO THE ARCHITECTURAL DRAWINGS FOR ADDITIONAL WOOD FRAMING MEMBERS, PROVIDE ADDITIONAL WOOD FRAMING IMMBERS SHOWN ON THE ARCHITECTURAL DRAWINGS EVEN THOUGH THEY MAY NOT BE SHOWN ON THE STRUCTURAL DRAWINGS.
- 12. CONTRACTOR SHALL DESIGN AND DETAIL CONNECTIONS NOT SHOWN AND SUMMIT TO ENGINEER FOR APPROVAL
- PROVIDE SIMPSON STRAP TO TIE WALLS TO BEAM AND SECOND LEVEL TO FIRST LEVEL 16" LENGTH AT BOTH ENDS PLUS FLOOR JOIST DIMENSION.

MAX ROUGH OPENING	HEADER, UND
UP TO 4-0"	6xf OR 4x10
€-17 TO S-Q*	8x10 OR 4x14
6-1" TO 8-0"	3 161/1210LB OR 8/12
8-1" TO 10"-0"	3 VEN 15 OLS OR 5 VEN 10 1/2 OLS
OVER 101-0"	SEE PLANS

LINTEL SCHEDULE

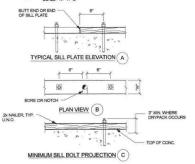

SILL BOLT REQUIREMENTS

- PROVIDE A MINIMUM SILL BUT EMBEDMENT OF 7' BELOW FINSH FLOOR OR OR PROVIDE AN ADDITIONAL SILL BUT 5 INCHES FROM EACH END OF EACH PIECE OF SILL PLATE.

 WHERE SILL IS A TEXT OF THE ADDITIONAL SILL BUT 5 INCHES FROM EACH END OF EACH PIECE OF SILL PLATE.
- MINUTE OF SILL PLATE.

 3. WHERE SILL PLATES ARE BORED OR NOTCHED IN EXCESS OF 1/3 OF THE SILL PLATE WIDTH, PROVIDE ADDITIONAL SILL BOLTS 6 INCHES EACH SIDE OF BORE OF NOTCH.
- VIDE A MINIMUM SILL BOLT PROJECTION ABOVE THE CONCRETE AS SHOWN
- 5. PROVIDE A 1/2" Ø HILTY HY 150 AT EVERY OPONING, 6" AWAY FROM EDGE OF

1 SILL ANCHORAGE TYP. DETAIL

MALLING COLEDINE


	CONNECTION	NAILING
	JOIST TO SILL OR GIRDER, TOENAIL	3-8d
	BRIDGING TO JOIST, TOENAL EACH END	2-8d
	1" X 6" SUBFLOOR OR LESS TO EACH JOIST, FACE NAIL	2-8d
	WIDER THAN 1" X 6" SUBFLOOR TO EACH JOIST, FACE NAIL	3-8d
	2" SUBFLOOR TO JOIST OR BLOCKING, FACE NAIL	2-16d
	SOLE PLATE TO JOIST OR BLOCKING, FACE NAIL	16d at 16" o.c.
	TOP PLATE TO STUD, END NUL	2-16d
	STUD TO SOLE PLATE	4-8d, toensil or
		2-16d, end neil
	DOUBLE STUDS, FACE NAIL	16d at 24" o.c.
	DOUBLED TOP PLATES, FACE NAIL	16d at 16" o.c.
	TOP PLATES, LAPS AND INTERSECTIONS, FACE NAIL	2-16d
	CONTINUOUS HEADER, TWO PEICES	16d at 16" o.c. along ea. edg
į.	CEILING JOISTS TO PLATE, TOENAIL	3-8d
	CONTINUOUS HEADER TO STUD, TOENAIL	4-8d
Ų.	CEILING JOISTS, LAPS OVERPARTITIONS, FACE NAIL	3-16d
	CEILING JOISTS TO PARALLEL RAFTERS, FACE NAIL	3-16d
	RAFTER TO PLATE, TOENAIL	3-8d
C.	1" BRACE TO EACH STUD AND PLATE, FACE NAIL	2-8d
ũ	1" X 8" SHEATHING OR LESS TO EACH BEARING, FACE NAIL	2-8d
L	WIDER THAN 1" X 8" SHEATHING TO EA, BEARING, FACE NAIL	3-8d
	BUILT-UP CORNER STUDS	16d at 24" o.c.
	BUILT-UP GIRDER AND BEANS	20d at 32" o.c. at top
		and bottom and staggered
		2-20d at ends and at each sp
be	2" PLANKS	2-16d at each bearing
Ĺ;	PLYWOOD AND PARTICLEBOARD, ROOF AND WALL SHEATHING	TO FRAMING:
	1/2" AND LESS	6d spaced at 6" o.c. at edges

6d spaced at 6" o.c. at edges, 12" o.c. at intermediate supports.

NOTE: "X" INDICATES EDGE NAILING-SEE SHEAR PANEL SCHEDULE FOR NAIL SIZE AND SPACING 3/8 FLAT BLOCKING AT EDGE OF WSF


19/32" - 3/4"

WOOD STRUCTURAL PANEL NAILING AT SPLICE (A

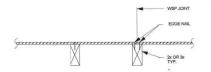


PLAN: WOOD STRUCTURAL PANEL ONE SIDE (B


SHEATHING NAILING DETAIL

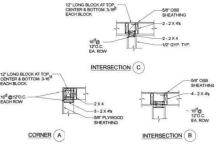

5 TYP. WALL FRAMING DETAILS

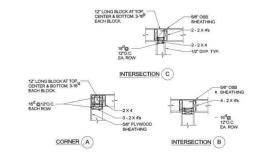

TYP. WALL FRAMING DETIALS

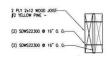

TYPICAL 2-PLY BEAM/JOIST DETAIL

TABLE R602.3(3) REQUIREMENTS FOR WOOD STRUCTURAL PANEL WALL SHEATHING USED TO RESIST

MINIMUM NAIL		MINIMUM MINIMUM MAXIMUM WOOD NOMINAL WALL STUD		PANEL NAIL SPACING		MAXIMUM WIND SPEED (mph)			
SIZE	PENETRATION (Inches)	PANEL SPAN RATING	THICKNESS	SPACING (Inches)	EDGES (Inches o.c.)	FIELD (Inches o.c.)	WIND EXPOSURE CATEGORY		
KATIN	KATINO	(inches)		A SHOWN THE	ACCOUNT DOOR	A 8		C	
6D COMMON (2.0"X0.131")	1.5	24/0	3/8	16	6	12	110	90	85
80				16	6	12	130	110	105
COMMON (2.5"X0.131")	1.75	24/16	7/16	24	6	12	110	90	85

For S1: 1 inch = 25.4 mm, 1 mile per hour = 0.447 m/s.

- a. Ponel strength axis porollel or perpendiculor to supports. Three-ply plywood sheothing with studs spoce more than 15 inches on center shall be applied with panel strength axis perpendicular to supports. Loteral broading requirements shall be in accordance with Section, B802.10.
 c. Wood Structural Ponels with spon rotings of wall-16 or wall-24 shall be permitted as an olternate to panels with a 24/0 spon rotting, Plywood siding roted 16 a.c. ar2 4 a.c. shall be permitted on olternate to panels with a 24/16 spon roting, Wall-16 and plywood siding 16 a.c. shall be used with studs spoced or manitum of 16 is inches on center.

TABLE R602.3(1)-continue FASTENER SCHEDULE FOR STRUCTURAL MEMBERS


				CING OF TENERS
ITEM	DESCRIPTION OF BUILDING MATERIALS	DESCRIPTION OF FASTENER***	EDGES (Inches)	SUPPORTS** (Inches)
W000 St	framing and part	subfloor, roof and in ticleboard wall sheat	ning to from	ning to
30	3/8"-1/2"	6d common (2"x0.113") noil (subfloor wall) 8d		T

- Stoples ore 16 gags wire and hove a minimum 7/16" on diameter crown width. Noils shall be spaced of not more than 6 inches on center of all supports where goods are 46 benches or greature. The control of the control



PROVICE FURRING OR BACKING OF THICKNESS AS REQUIRED TO MANITAIN A COMMON WALL PLANE AT ALL WOOD STUD WALL SURFACES WHICH ARE ONLY PARTIALLY SHEATHED WITH WOOD STRUCTURAL PANEL. COORDINATE AND ADJUST HEAD, JAMB AND SILL DETAILS AS REQUIRED FOR PROPER OVERALL WALL THICKNESS

"X"INDICATES EDGE NAILING-SEE NAILING SCHEDULE FOR NAIL SIZE AND SPACING.

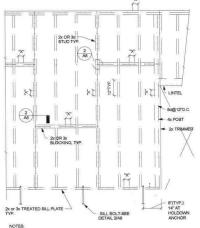

City of Austin

· FOR SHEAR WALL NAILING, SEE NAILING SCHEDULE

FOR SHEAR WALL NALING, SEE NALING SCHEDULE
NDOWDULA PIECES OF WOOD STRUCTURAL PANEL
SHALL BE NOT LESS THAN 2-0" IN LEAST
DIMENSION NOR FT. IN AREA
RE-TIGHTEN BOLTS BEFORE CLOSING
FOR ADDITIONAL NOTES, SEE TIMBER GENERAL NOTES.

. FOR OPENINGS IN WOOD STRUCTURAL PANEL SHEATHING, SEE DETAIL 3/S.1

REVIEWED FOR CODE COMPLIANCE 6 WALL TYP. DETAIL

			CONNECTION C	RITERIA
METHOD, MATERIAL		MINIMUM THICKNESS	FASTENERS	SPACING
CONTINUOUS CS-WSP		EXTERIOR SHEATHING PER TABLE R602.3(3)		
SHEATHING METHOD	CONTINUOUSLY SHEATHED WOOD STRUCTURAL PANEL	3/8"	EXTERIOR SHEATHING PER TABLE R602.3(1) OR R602.3(2)	VARIES BY FASTENER

G8 CYPSIIM BOARD	1/2"	TABLE R602.3(1) FOR EXTERIOR LOCATIONS	PANEL LOCATIONS: 7" EDGES (INCLUDING TOP
GYPSUM BOARD		NAILS OR SCREWS PER TABLE R702.3.5 FOR INTERIOR LOCATIONS	AND BOTTOM PLATES) 7" FIELD

Chineers F-4756 12) 524-0677 UHDI Inmental En Structural and Environment Registered Engineering Fi Civil, S Texas 1715 E.

REVISIONS


Residence Gonzales St. Texas 78702 Details Salazar 2810 Gonzo Austin, Texos Framing The

group design IH 35, Texas 512 58 Austin, Mobile: e-mail:

ATX

DATE: 10/8/2018 SCALE: VARIES DRAWN: RD/SR FILE: CIONGSISALAZAR RES. SHEET 5 A5

9 SHEETS

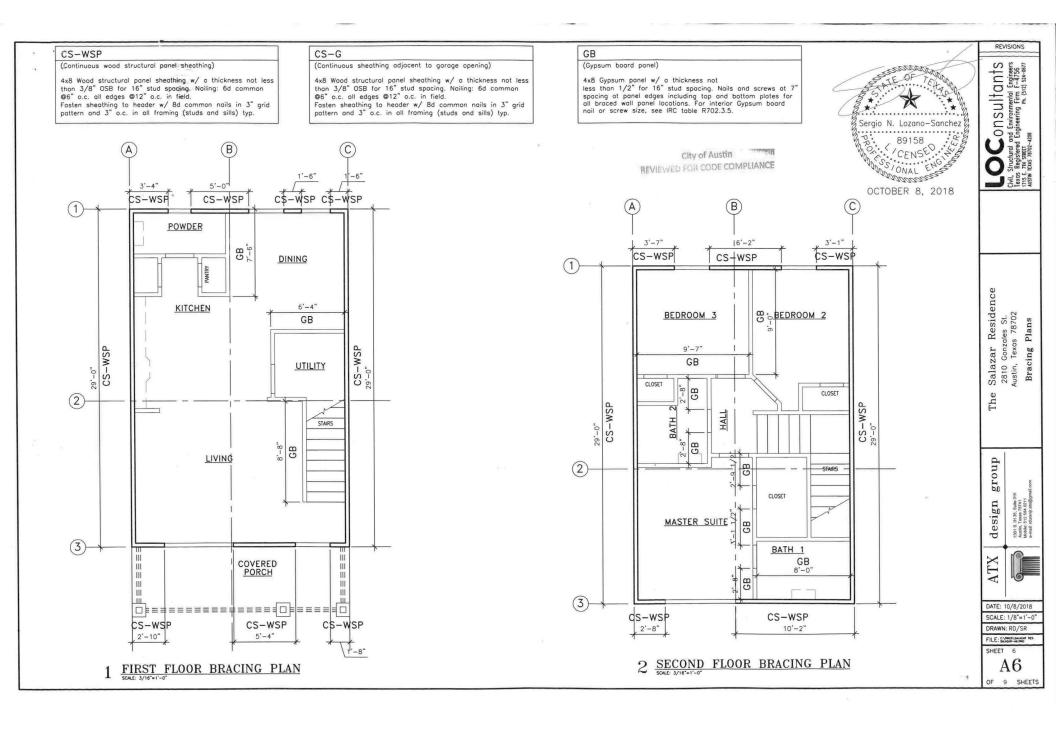

FOUNDATION NOTES

- TREMOVE ALL VOSCITATION AND TOP SOIL FROM THEBUILDING AREA STOCKNESS TO SOIL FROM THE BUILDING AREA STOCKNESS TO SOIL FROM THE ATTEMPT OF 18 FEET WITHIN BLALDING PERMITTER RE-COMPACT TO HE REST WITHIN BLALDING PERMITTER BACKFILL IN IT LEFT SUB-STRUCTURAL FILL COMPACT TO A DENSITY OF SOIL FROM THE ATT MOSTING THE MOST THE COUNTY OF SOIL FROM THE ATT MOSTING THE MOST THE COUNTY OF THE MOST THE MOST THE COUNTY OF THE MOST THEM MOST THE M
- STRUCTURA FILL.

 S STRUCTURA FILL SHALL CONSIST OF GRANLAR MATERIAL FREE OF ORGANIC MATTER AND DEBRIS. NATURALLY OR AFFECURALY GRANDED MOTULES OF GRANCE, CONSIDED STOME AND SAFE AND ASTRO-MENT OF GRANDED STRUCTURAL OF T
- COMPACTION AND MOISTURE CONTENT OF SUB-GRADE AND EACH LIFT SHALL BE MONITORED BY INSPECTOR.
- FOOTING EXCAVATION SHALL BE NEAT AND FREE OF LOOSE OR WET MATERIALS.
- MITCHALD.

 THE VAPOR BARRIER BELOW ALL SLAB AREAS SHALL BE 15 MIL POLYETHYLENE.

 WITH ALL JOINTS LAPPED 12" CONTINUOUS AND SEALED. DROP VAPOR
 BARRIER DOWN THE SIDES OF ALL BEAM TRENCHES. DO NOT PLACE VAPOR
 BARRIER ACROSS TRENCH BOTTOM.
- IF BEARING SOILS ARE SOFTENED BY SURFACE WATER INTRUSIONS DURING EXPOSURE OR BY DESICCATION, THE UNSUITABLE SOILS MUST BE REMOVED FROM THE FOUNDATION EXCAVATION PRIOR TO PULCEMENT OF CONCRETE.
 GRADE AREA AROUND BUILDING TO DRAINWATER WAY FROM THE BUILDING.
- 10. SEE ELECT. & PLUMBING DWG'S FOR SLAB & WALL PENETRATIONS

REINFORCING CONCRETE NOTES:

- CONCRETE CONSTRUCTION SHALL BE IN ACCORDANCE WITH THE AMERICAN CONCRETE INSTITUTE "BUILDING CODE REQUIREMENTS FOR REINFORCED CONCRETE," ACI 318-11.
- ALL CONCRETE SHALL. HAVE A SPECIFIED MINIMUM COMPRESSIVE STRENGTH OF 3000 P.S.I. AT 28 DAYS.
- 3. SLUMP 3" to 5" WITH MAX. WATER/CEMENT RATIO OF 0.45
- PROVIDE 5 % ±1-1/2 % OF ENTRAINED AIR IN CONCRETE PERMANENTLY EXPOSED TO THE WEATHER.
- EMBEDDED CONDUITS, PIPES AND SLEEVES SHALL MEET THE REQUIREMENTS OF ACI 318-99 SECT. 6.3.
- REINFORCING STEEL SHALL BE DEFORMED BARS IN CONFORMANCE WITH ASTM A615 GRADE 60.
- 7. DETAILING OF REINFORCING STEEL IN ACCORDANCE WITH ACI DETAILING MANUAL
- 8. MIN. LAP 38 X BAR DIA (NOMINAL)

STEEL CLEAR COVER: GRADE BEAM. 1-1/2" TOP, 3" BOT., AND 2" SIDE (FORMED). 3" SIDE (PLACE AGAINST EARTH)

SLAB ON GRADE - 3" BOT, AND 1 1/2" TOP

- PROVIDE CORNER AND INTERSECTION REINF, AS SHOWN IN STD. DETAIL 5%.0
 FINISHED FLOOR ELEVATIONS SHALL BE MIN. 6" ABOVE FINISH GRADE.
 PROVIDE 24" DOWEL BETWEEN NEW AND EXISTING CONCRTE 12" ON CENTER. TYP.

 $\frac{3}{A7}$, 5" THICK CONC. SLAB REINF, W/#4 AT 15" O.C.E.W. EMBED @ MIDSLAB ON BUILDING PAD PER STRUCTURAL NOTES (2) A7) $\begin{pmatrix} 3 \\ A7 \end{pmatrix}$ (2) A7) (P)


18'-10"

9'-5"


9'-5"



FOUNDATION PLAN

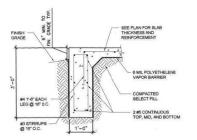

FOUNDATION SECTION

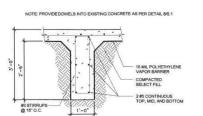

3 FOUNDATION SECTION



Structure and Environmental Engineers 28 Registered Engineering Firm F-4735 E. 274-2898 HTDS 7872-4288

REVISIONS

Salazar Residence 2810 Gonzoles St. Austin, Texos 78702 Details and Foundation Plan The

group design Austin, Mobile: e-mail:


ATX DATE: 10/8/2018

SCALE: VARIES DRAWN: MAD


FILE: C'ADMOS SALAZAR RES SHEET 7 A7


9 SHEETS

City of Austin REVIEWED FOR CODE COMPLIANCE

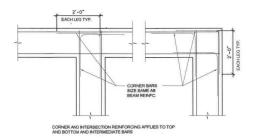

FOUNDATION SECTION

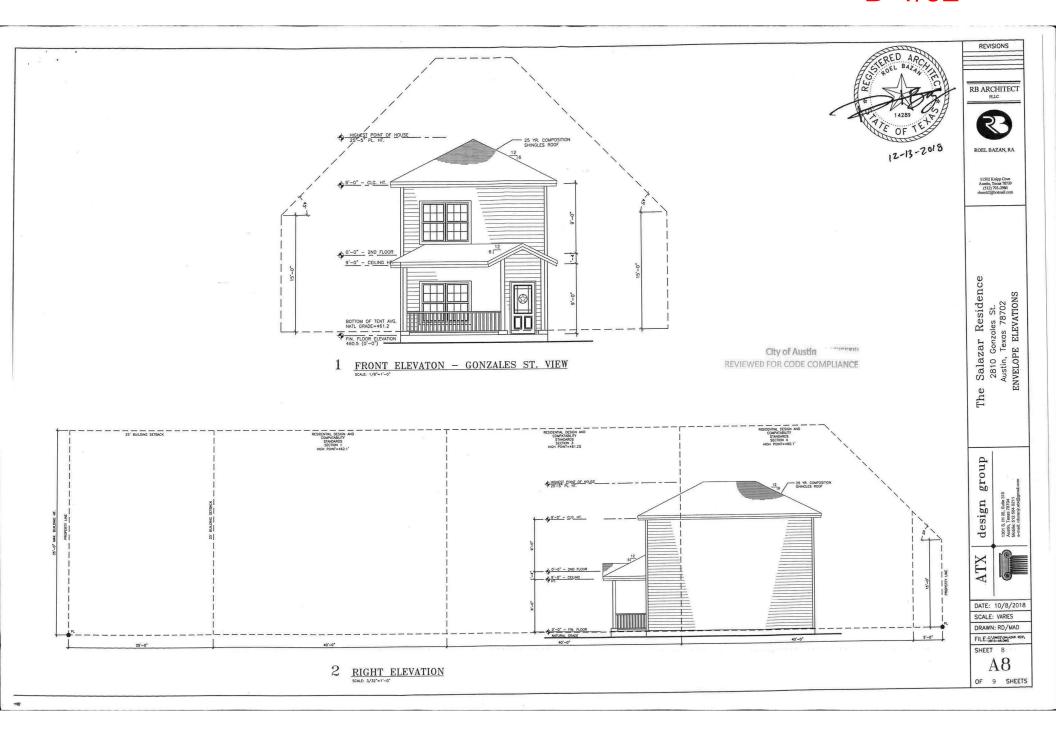

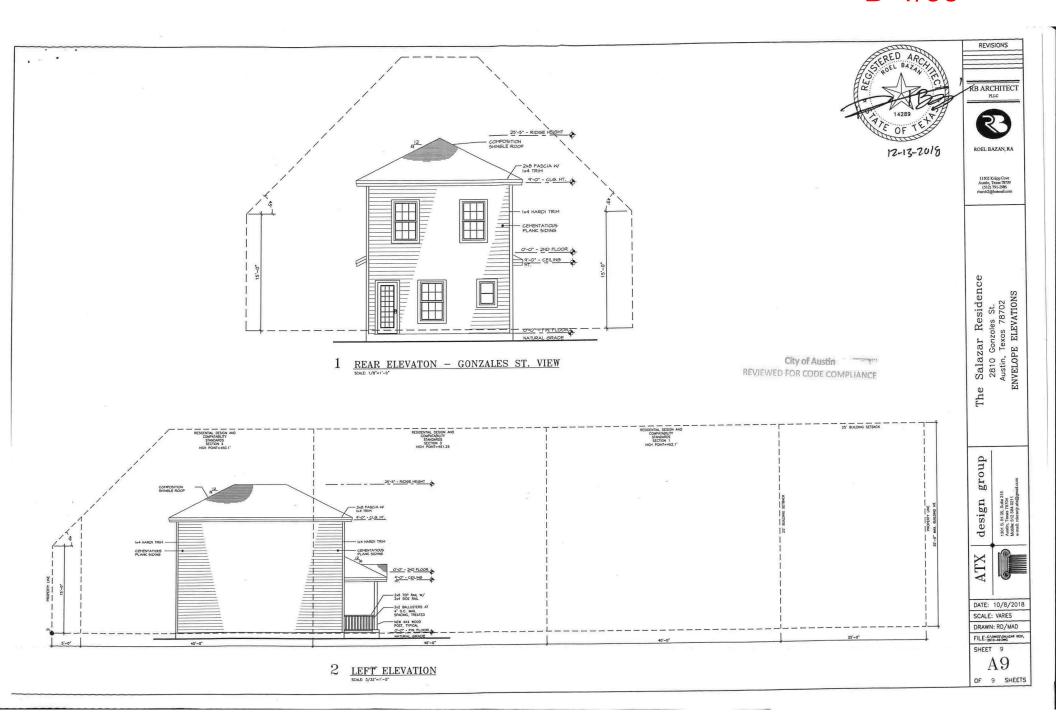

LEGEND OF ELECTRICAL SYMBOLS

5 PROVIDE WIRING FOR SPEAKER INSTALLATION CH-SMOKE DETECTOR (3) > TELEPHONE JACK 1-TV/CABLE OUTLET EP ELECTRIC PANEL

6M 110-120 VOLT RECEPTACLE

wp 年

GFCI D

110-120 VOLT RECEPTACLE WEATHER PROOF 110-120 VOLT GFI (44" AFF)

0 110-120 VOLT SURFACE MOUNTED RECEPTACLE 220-240 VOLT RECEPTACLE

0 RECESSED INCANDESCENT LIGHT

0 INCANDESCENT CEILING OUTLET FIXTURE INCANDESCENT WALL MOUNTED OUTLET FIXTURE

44 FLOOD LIGHT

HS MOTION SENSOR FLOOD LIGHT

ONE-WAY SHITCH

THO-WAY SHITCH

ONE-WAY SWITCH WITH DIMMER

ONE-WAY SWITCH FOR SPEAKER VOLUME CONTROL

EXHAUST FAN

CEILING FAN WITH LIGHT


HOUSE WIRE CONCEALED IN WALL OR CEILING

4' FLOURESCENT LIGHT D ID DISCONNECT

PREHIRE FOR (CAT 5) FOR ENTIRE HOUSE.

PREWIRE FOR (RG6) FOR ENTIRE HOUSE.


CONTRACTOR VERIFICATION RESPONSIBILITIES

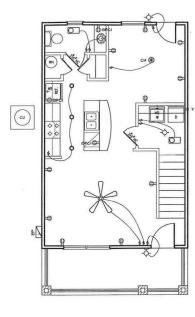

FIRST FLOOR PLAN



12-13-2018

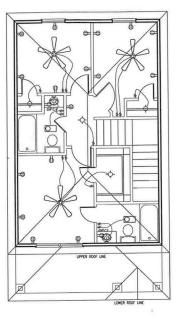

SECOND FLOOR PLAN

City of Austin REVIEWED FOR CODE COMPLIANCE

REVISIONS RB ARCHITECT

33

ROEL BAZAN, RA

11502 Knipp Cove Austin, Texas 78739 (512) 791-2985 charch Officemail.com

The Salazar Residence 2810 Gonzoles St. Austin, Texas 78702 ELECTRICAL FLOOR PLANS The

group design 1301 S. IH 35, Suite 31: Austin, Texas 78704 Mobile: 512 584 0211 e-mail: rduranjr.abc@gr

ATX DATE: 10/8/2018

SCALE: 1/8"=1'-0" DRAWN: MAD

FILE: C:\DWGS\SALAZAR RES SHEET 1 E1

OF 1 SHEETS

CITY OF AUSTIN Board of Adjustment Decision Sheet G-4

DATE:	Monday February 8, 2021	CASE NUMBER : C15-2020-0083
Y	Brooke Bailey	
Y	Jessica Cohen	
Y	Ada Corral	
Y	Melissa Hawthorne	
_	VACANT	
Y	Don Leighton-Burwell	
Y	Rahm McDaniel	
Y	Darryl Pruett	
Y	Veronica Rivera	
Y	Yasmine Smith	
Y	Michael Von Ohlen	
	Kelly Blume (Alternate)	
_	Vacant (Alternate)	
	Donny Hamilton (Alternate)	

APPLICANT: Daniel Salazar

OWNER: Enez Salinas

ADDRESS: 2810 GONZALES ST

VARIANCE REQUESTED: The applicant is requesting variance(s) from the Land Development Code, Section 25-2-774 (Two-Family Residential Use) (C) (2) (a) for a Two-Family Residential use location at least 10 feet to the rear or side of the principal structure (required) to 5 feet (requested) in order to erect a Secondary Dwelling Unit in an "SF-3-NP", Single-Family Residence-Neighborhood Plan zoning district. (Govalle Neighborhood Plan)

Note: Per LDC the second Dwelling Unit must be contained in a structure other than the principal structure and must be located at least 10 feet to the rear or side of the principal structure

BOARD'S DECISION: BOA MEETING JAN 11, 2021 Board Member Jessica Cohen motions to postpone to February 8, 2021 due to technical difficulties, Board member Michael Von Ohlen seconds on a 9-0 vote; POSTPONED TO February 8, 2021 DUE TO TECHNICAL DIFFICULTIES. February 8, 2021 The public hearing was closed by Chair Don Leighton-Burwell, Board Member Brooke Bailey motions to postpone to March 8, 2021; Board Member Darryl Pruett seconds on a 10-0 vote; POSTPONED TO MARCH 8, 2021.

FINDING:

1. The Zoning regulations applicable to the property do not allow for a reasonable use because:

- 2. (a) The hardship for which the variance is requested is unique to the property in that:
 - (b) The hardship is not general to the area in which the property is located because:
- 3. The variance will not alter the character of the area adjacent to the property, will not impair the use of adjacent conforming property, and will not impair the purpose of the regulations of the zoning district in which the property is located because:

Haine Ramirez

Executive Liaison

Diana Ramirez for


Don Leighton-Burwell

Chairman







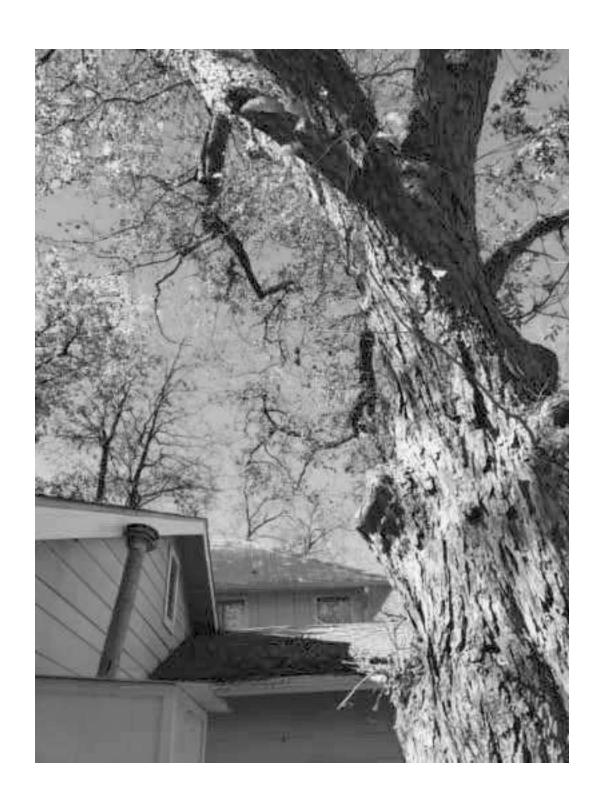





CITY OF AUSTIN Board of Adjustment Decision Sheet D-3

DATE: Monday January 11, 2021 CASE NUMBER: C15-2020-0083

	_Brooke Balley OUT	
Y	Jessica Cohen	
Y	Ada Corral	
Y	Melissa Hawthorne	
	_VACANT	
Y	Don Leighton-Burwell	
Y	Rahm McDaniel	
Y	Darryl Pruett	
	_Veronica Rivera OUT	
Y	Yasmine Smith	
Y	Michael Von Ohlen	
Y	Kelly Blume (Alternate)	
	_Vacant (Alternate)	
-	Donny Hamilton (Alternate) N	NOT AVAIL

APPLICANT: Daniel Salazar

OWNER: Enez Salinas

ADDRESS: 2810 GONZALES ST

VARIANCE REQUESTED: The applicant is requesting variance(s) from the Land Development Code, Section 25-2-774 (Two-Family Residential Use) (C) (2) (a) for a Two-Family Residential use location at least 10 feet to the rear or side of the principal structure (required) to 5 feet (requested) in order to erect a Secondary Dwelling Unit in an "SF-3-NP", Single-Family Residence-Neighborhood Plan zoning district. (Govalle Neighborhood Plan)

Note: Per LDC the second Dwelling Unit must be contained in a structure other than the principal structure and must be located at least 10 feet to the rear or side of the principal structure

BOARD'S DECISION: BOA MEETING JAN 11, 2021 Board Member Jessica Cohen motions to postpone to February 8, 2021 due to technical difficulties, Board member Michael Von Ohlen seconds on a 9-0 vote; POSTPONED TO February 8, 2021 DUE TO TECHNICAL DIFFICULTIES.

FINDING:

1. The Zoning regulations applicable to the property do not allow for a reasonable use because:

- 2. (a) The hardship for which the variance is requested is unique to the property in that:
 - (b) The hardship is not general to the area in which the property is located because:
- 3. The variance will not alter the character of the area adjacent to the property, will not impair the use of adjacent conforming property, and will not impair the purpose of the regulations of the zoning district in which the property is located because:

Executive Liaison

Diana Ramirez for

Don Leighton-Burwell

Chairman

Members of the Board of Adjustment

I would like to take this opportunity to speak on behalf of Daniel Salazar. I hope this can shed some light on why this variance is being sought.

For those of you that are unfamiliar with the building inspection process I would like to briefly explain the layout inspection. The layout inspection is the initial inspection for most projects and is when we verify site conditions are consistent with the approved plans. This is by far one of the most important inspections we do, and in this case if it had been done correctly, we would not be having this conversation.

When Mr Salazar was starting his project the building inspections division was in the middle of department wide re-organization, dealing with declining response times and an alarming number of backlogged inspections. We were eventually allocated seven new positions at the beginning of fiscal year to deal with the backlog. This coupled with the departure of three veteran inspectors left us with the arduous task of not only filing ten vacancies but also training them with our remaining staff while simultaneously catching up with a seemingly insurmountable inspection backlog.

The approval of the layout inspection for 2810 Gonzales was a biproduct of this tumultuous time. Under normal circumstances this oversight would have been identified and correcting it would have been as simple as moving some forms. This oversight has led us to re-evaluate the way we do conduct our inspections as well as who conducts those inspections. Mr. Salazar trusted the City of Austin to make sure his project was done correctly and due to some very unfortunate circumstances we failed to meet those expectations.

Sincerely,

Kelly Stilwell

Acting Chief Building Inspector, Division Manager

T.S.B.P.E License No. 2461

BOA GENERAL REVIEW COVERSHEET

CASE: C15-2021-0083 **BOA DATE:** January 11th, 2021

ADDRESS: 2810 Gonzales St

OWNER: Enez Salinas

COUNCIL DISTRICT: 3

AGENT: Daniel Salazar

ZONING: SF-3-NP (Govalle NP)

LEGAL DESCRIPTION: LOT 3 BLK 1 *LESS SW TRI OLT 26-27 DIV A CHERNOSKY NO 11

VARIANCE REQUEST: Two-Family Residential use location at least 10 feet to the rear or side of the principal

structure to 5 feet

SUMMARY: erect 2 story secondary dwelling unit

ISSUES: no alley and setback requirements

	ZONING	LAND USES
Site	SF-3-NP	Single-Family
North	SF-3-NP	Single-Family
South	P-NP	Public
East	SF-3-NP	Single-Family
West	CS-V-NP	General Commercial Services-Vertical Mixed
		Uses

NEIGHBORHOOD ORGANIZATIONS:

Austin Independent School District

Austin Lost and Found Pets

Austin Neighborhoods Council

Bike Austin

Del Valle Community Coalition

East Austin Conservancy

El Concilio Mexican-American Neighborhoods

Friends of Austin Neighborhoods

Govalle Neighborhood Association

Govalle/Johnston Terrace Neighborhood Plan Contact Team

Guadalupe Neighborhood Development Corporation

Homeless Neighborhood Association

Neighborhood Empowerment Foundation

Neighbors United for Progress

Parque Zaragosa Neighborhood Association

Preservation Austin

SELTexas

Sierra Club, Austin Regional Group



January 5, 2021

Daniel Salazar 2810 Gonzales St Austin TX, 78702

Property Description: LOT 3 BLK 1 *LESS SW TRI OLT 26-27 DIV A CHERNOSKY NO 11

Re: C15-2020-0083

Dear Daniel,

Austin Energy (AE) has reviewed your application for the above referenced property, requesting that the Board of Adjustment consider a variance(s) from the following section of the Land Development Code –

Section 25-2-774 (Two-Family Residential Use); (C) 2 a. The second dwelling unit must be located at least 10 feet to the rear or side of the principal structure; (required); to allow for a second dwelling unit to be five (5) ft. from the principal structure; (requested);

In order to erect a Secondary Dwelling Unit in an "SF-3-NP", Single-Family Residence-Neighborhood Plan zoning district. (Govalle Neighborhood Plan);

Austin Energy does not oppose the above variance request provided any proposed and existing improvements follow Austin Energy's clearance criteria requirements, the National Electric Safety Code and OSHA. Any removal or relocation of existing electric facilities will be at owners /applicants' expense.


Please use this link to be advised of our clearance and safety requirements which are additional conditions of the above review action: https://austinenergy.com/wcm/connect/8bb4699c-7691-4a74-98e7-56059e9be364/Design+Criteria+Manual+Oct+2015.pdf?MOD=AJPERES

If you require further information or have any questions regarding the above comments, please contact our office. Thank you for contacting Austin Energy.

Eben Kellogg, Property Agent


Austin Energy
Public Involvement | Real Estate Services
2500 Montopolis Drive
Austin, TX 78741
(512) 322-6050




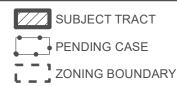

NOTIFICATIONS

CASE#: C15-2020-0083 LOCATION: ²⁸¹⁰ GONZALES STREET

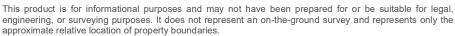

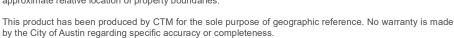





Board of Adjustment General/Parking Variance Application

<u>DevelopmentATX.com</u> | Phone: 311 (or 512-974-2000 outside Austin) For submittal and fee information, see <u>austintexas.gov/digitaldevelopment</u>

WARNING: Filing of this appeal stops all affected construction activity.

This application is a fillable PDF that can be completed electronically. To ensure your information is saved, <u>click here to Save</u> the form to your computer, then open your copy and continue.

The Tab key may be used to navigate to each field; Shift + Tab moves to the previous field. The Enter key activates links, emails, and buttons. Use the Up & Down Arrow keys to scroll through drop-down lists and check boxes, and hit Enter to make a selection.

The application must be complete and accurate prior to submittal. *If more space is required, please complete Section 6 as needed.* All information is required (if applicable).

For Office Use Only

Case #	ROW #	Tax #	!
Section 1: Appli	cant Statement		
	Gonzales St. Austin, TX 7870)2	
Subdivision Legal Desc LOT 3 BLK 1 *LES	ription: S SW TRI OLT 26-27 DIV A	CHERNOSKY NO 11	
Lot(s): 3		Block(s): 1	
Outlot:		_ Division:	
Zoning District:			
I/We Daniel Salazar		on be	ehalf of myself/ourselves as
Month November	Day 12 , Year	2020 , hereby ap	oply for a hearing before the
Board of Adjustment	for consideration to (select	appropriate option bel	ow):
○ Erect ○ Attach	n ○Complete ○Rem	odel O Maintain	Other:
Type of Structure: 1	New construction of 2-story s	econdary dwelling un	it.

D-1/50

Portion of the City of Austin Land Development Code applicant is seeking a variance from: I am requesting a variance from the Land Development Code section 25-2-774 Two-Family Residential Use (C) (2) (a) for a SF-3-NP Two-Family location at least 10ft. (required) to rear of principal structure to _5ft(requested).	_ _ _
Section 2: Variance Findings	
The Board must determine the existence of, sufficiency of, and weight of evidence supporting the findings described below. Therefore, you must complete each of the applicable Findings Statements as part of your application. Failure to do so may result in your application being rejected as ncomplete. Please attach any additional supporting documents.	
NOTE: The Board cannot grant a variance that would provide the applicant with a special privilege not enjoyed by others similarly situated or potentially similarly situated.	
contend that my entitlement to the requested variance is based on the following findings: Reasonable Use The zoning regulations applicable to the property do not allow for a reasonable use because: the setback requirements do not allow reasonable utilization of this lot and many of the other homes in the area have similar accessory structures that were built before the code went into effect.	
Hardship a) The hardship for which the variance is requested is unique to the property in that: All of the other commercial blocks on the south side of Cesar Chavez have an alley on the back side that would soften the compatibility standard. This block does not. This lot also has a 35" DBH tree on the property which all limit the development footprint. It is an over-mature, over extended tree with a spread about as wide as it is tall. The height is about'-35-40' tall.	
b) The hardship is not general to the area in which the property is located because: All other blocks on the south side of East Cesar Chavez have an alley. In addition the tree is located in the middle of the property.	

Area Character

The variance will not alter the character of the area adjacent to the property, will not impair the use of adjacent conforming property, and will not impair the purpose of the regulations of the zoning district in which the property is located because:

: : (1)	Due to the age of the neighborhood there are numerous other lots on this block that have imilarly configured accessory structures that are "existing non complying" so this accessory tructure will not affect the character of the neighborhood. In addition the zoning district Govalle Neighborhood Plan) only regulates property use and this variance would not impair nose regulations.
Reque a varia Apper	ng (additional criteria for parking variances only) est for a parking variance requires the Board to make additional findings. The Board may grant ance to a regulation prescribed in the City of Austin Land Development Code Chapter 25-6, adix A with respect to the number of off-street parking spaces or loading facilities required if it is findings of fact that the following additional circumstances also apply:
1. - -	Neither present nor anticipated future traffic volumes generated by the use of the site or the uses of sites in the vicinity reasonably require strict or literal interpretation and enforcement of the specific regulation because:
2. -	The granting of this variance will not result in the parking or loading of vehicles on public streets in such a manner as to interfere with the free flow of traffic of the streets because:
3.	The granting of this variance will not create a safety hazard or any other condition inconsistent with the objectives of this Ordinance because:
4.	The variance will run with the use or uses to which it pertains and shall not run with the site because:
_	

Section 3: Applicant Certificate

I affirm that my statements contained in the complete my knowledge and belief.	e application are true	and correct to the best of
Applicant Signature:	Mar	Date: 11/12/2020
Applicant Name (typed or printed): Daniel Salazar	V	
Applicant Mailing Address: 2810 Gonzales St		
City: Austin	State: TX	Zip: 78702
Phone (will be public information): 512-619-8154		
Email (optional – will be public information):		
Section 4: Owner Certificate		
I affirm that my statements contained in the complete my knowledge and belief.	application are true	and correct to the best of
Owner Signature:		Date: 11/12/2020
Owner Name (typed or printed): Enez Salinas		
Owner Mailing Address: 2810 Gonzales St.		
City: Austin	State: TX	Zip: 78702
Phone (will be public information): 512-619-8154		
Email (optional – will be public information):		
Section 5: Agent Information		
Agent Name:		
Agent Mailing Address:		
City:	State:	Zip:
Phone (will be public information):		
Email (optional – will be public information):		
Section 6: Additional Space (if applica	able)	
Please use the space below to provide additional inf referenced to the proper item, include the Section ar		