

32ND STREET RENOVATION ISSUED FOR PERMIT 8/19/2021




GRAPHIC SYMBOLS & CONVENTIONS

GRAPHIC SYMBOLS SHEET NO. ON WHICH ENLARGED DETAIL IS DRAWN - SECTION OR DETAIL NO. DETAIL NO. —— DRAWING TITLE View Name /SCALE: 1/8" = 1'-0" - AREA OF DETAIL ENLARGED ——— SCALE OF SECTION OR DETAIL - ELEVATION NUMBER - DIRECTION OF CUTTING PLANE SHEET NUMBER A101 SHEET NO. ON WHICH SECTION IS DRAWN LONGITUDINAL OR CROSS SECTION NO. **GRAPHIC CONVENTIONS** DOOR TYPE APPEARING ON SCHEDULE OF OPENING - REVISION NUMBER DOOR NUMBER HIDDEN LINE AND/OR LINE ABOVE _____ FLOOR PLANE WINDOW TYPE BOUNDARY LINE AND/OR FLOOR LINES IN В EXTERIOR ELEVATIONS DIMENSION LINE DESIGNATIONS



LOCATION MAP

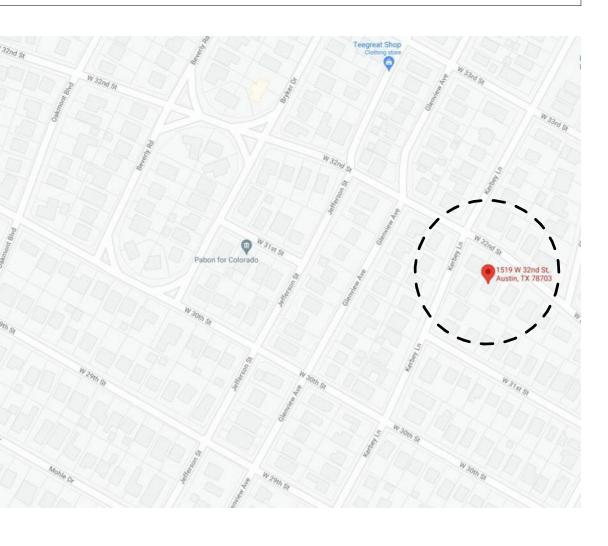

PROJECT DIRECTORY


<u>OWNER</u>	ROCKY MOUN ADDRESS TEL: EMAIL: CONTACT:	AUSTIN, TX 78703 512.560.5247 ROCKY.MOUNTAIN@OUTLOOK.COM" DWROWE2@ME.COM
<u>ARCHITECT</u>	EMAIL:	_ PARKWAY 11
<u>STRUCTURAL</u> ENGINEER	AUSTIN, TX 78 TEL: EMAIL:	SPRINGS ROAD, SUITE 250
<u>CONTRACTOR</u>	AUSTIN, TX 78	KE DR, SUITE 201

SCOPE OF WORK

RENOVATION AND ADDITION TO AN EXISTING SINGLE STORY RESIDENCE. WORK INCLUDES, BUT IS NOT LIMITED TO: RENOVATIONS ON THE FIRST LEVEL AND AN ADDITION OF A SECOND LEVEL, AS INDICATED IN THE DRAWINGS.

DRAWING INDEX

SHEET NO: DESCRIPTION ARCHITECTURAL A-001 COVER SHEET A-002 NOTES & SPECIFICATIONS A-100 SITE PLAN A-101 ENTRY LEVEL DEMOLITION FLOOR PLANS A-102 ENTRY LEVEL FLOOR PLAN UPPER LEVEL FLOOR PLAN A-103 A-110 ENTRY LEVEL LIGHTING PLAN A-111 UPPER LEVEL LIGHTING PLAN A-112 ENTRY LEVEL POWER PLAN A-113 UPPER LEVEL POWER PLAN A-200 DEMOLITION EXTERIOR ELEVATIONS A-201 EXTERIOR ELEVATIONS A-202 EXTERIOR ELEVATIONS A-301 BUILDING SECTIONS A-501 DOOR AND WINDOW TYPES AND WINDOW SCHEDULE STRUCTURAL S-001 STRUCTURAL NOTES S-002 STRUCTURAL NOTES S-101 FOUNDATION PLANS FLOOR FRAMING PLANS S-102 S-103 CEILING FRAMING PLAN ROOF FRAMING PLANS S-104 S-201 BRACED WALL PLANS S-301 CONCRETE DETAILS S-302 CONCRETE DETAILS S-303 CONCRETE DETAILS S-401 FRAMING DETAILS S-402 FRAMING DETAILS FRAMING DETAILS WOOD DETAILS - FROM CODE WOOD DETAILS - FROM CODE

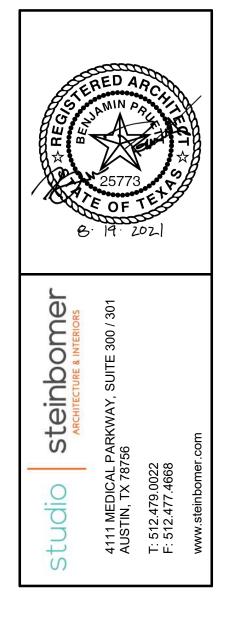

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ISSUED FOR PERMIT 8/19/2021

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No.	Desci	ription	Date
(COVER	SHEET	-
	4-()01	

S-403 S-501 S-502

ELECTRICAL NOTES

PROVIDE SOLAR-READY ZONE PER COA R701.1 ON UPPER ROOF

PROVIDE DUAL POLE CIRCUIT BREAKER FOR FUTURE SOLAR ELECTRIC INSTALLATION AND MUST BE LABELED "FOR SOLAR ELECTRIC"

IECC 2015 NOTES

REFER TO SECTION 402.1.2 CLIMATE ZONE 2

FENESTRATION U-FACTOR SKYLIGHT U-FACTOR GLAZED ShGC CEILING R-VALUE

27.	TABLE R402.1.2(2) INSULATION AND FENESTRATION REQUIREMENTS BY COMPONENT ^a FOR NEW CONSTRUCTION									
CLIMATE ZONE	FENESTRATION U-FACTOR ^b	SKYLIGHT U- FACTOR ^b	GLAZED FENESTRATION SHGC	CEILING R- VALUE	WOOD FRAME WALL R-VALUE	MASS WALL R- VALUE	FLOOR R-VALUE	BASEMENT WALL R-VALUE	SLAB R-VALUE & DEPTH ^c	CRAWL SPACE WALL R-VALUE
2	.35	.60	0.25	38 ^{d, g}	19, 15+2 or 13+3 e, f	4/6	13	0	0	0

REFER TO SECTION R4202.4 AIR LEAKAGE (MANDATORY)

THE BUILDING THERMAL ENVELOPE SHALL BE CONSTRUCTED TO LIMIT AIR LEAKAGE IN ACCORDANCE WITH THE REQUIREMENTS OF SECTIONS R402.4.1 THROUGH R402.4.5

REFER TO SECTION R402.4.1 BUILDING THERMAL ENVELOPE.

THE BUILDING THERMAL ENVELOPE SHALL COMPLY WITH SECTIONS R402.4.1 AND R402.4.1.2. THE SEALING METHODS BETWEEN DISSIMILAR MATERIALS SHALL ALLOW FOR DIFFERENTIAL EXPANSION AND CONTRACTION.

REFER TO SECTION R402.4.1.1 INSTALLATION.

THE COMPONENTS OF THE BUILDING THERMAL ENVELOPE AS LISTED IN TABLE R402.4.1.1 SHALL BE INSTALLED IN ACCORDANCE WITH THE MANUFACTURER'S INSTRUCTIONS AND THE CRITERIA LISTED IN TABLE R402.4.1.1, AS APPLICABLE TO THE METHOD OF CONSTRUCTION. WHERE REQUIRED BY THE CODE OFFICIAL, AN APPROVED THIRD PARTY SHALL INSPECT ALL COMPONENTS AND VERIFY COMPLIANCE.

REFER TABLE R402.41.1


AIR BARRIER AND INSULATION INSTALLATION *NOTE - AIR SEALING SHALL BE PROVIDED BETWEEN THE GARAGE AND CONDITIONED SPACED

REFER TO SECTION R403.6 MECHANICAL VENTILATION (MANDATORY)

THE BUILDING SHALL BE PROVIDED WITH VENTILATION THAT MEETS THE REQUIREMENTS OF THE INTERNATIONAL RESIDENTIAL CODE OR INTERNATIONAL MECHANICAL CODE, AS APPLICABLE, OR WITH OTHER APPROVED MEANS OF VENTILATION. OUTDOOR AIR INTAKES AND EXHAUST SHALL HAVE AUTOMATIC OR GRAVITY DAMPERS THAT CLOSE WHEN THE VENTILATION SYSTEM IS NOT OPERATING.

CITY OF AUSTIN TREE PROTECTION

TO INSURE THAT TRESS ARE ADEQUATELY PRESERVED, TREE PROTECTION FENCING IS REQUIRED FOR TREES WITHIN THE LIMITS OF CONSTRUCTION. FENCING SHOULD PROTECT THE ENTIRE CRITICAL ROOT ZONE (CRZ) AREA . FENCING IS REQUIRED TO BE CHAIN-LINK MESH AT A MINIMUM HEIGHT OF FIVE FEET. A 6-INCH LAYER OF MULCH WITHIN THE ENTIRE AVAILABLE ROOT ZONE AREA IS REQUIRED FOR TREES WHICH HAVE ANY DISTURBANCE INDICATED WITHIN ANY PORTION OF THE CRITICAL ROOT ZONE.

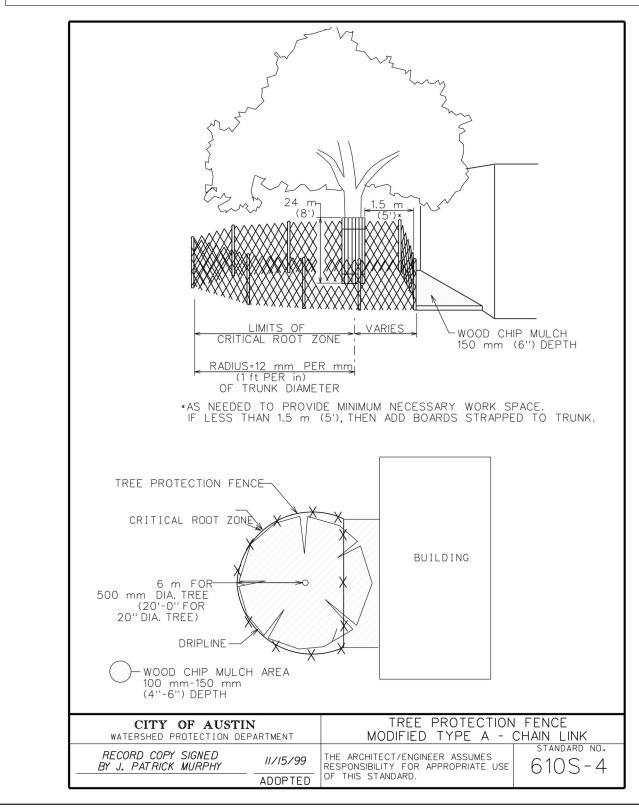

GENERAL MEP NOTES

- ARCHITECTURAL DRAWINGS ARE DIAGRAMMATIC IN NATURE AND ARE NOT INTENDED TO INDICATE ALL ASPECTS REQUIRED OF A COMPLETE AND SAFE, CODE-COMPLIANT INSTALLATION. THE DRAWINGS ARE PROVIDED TO INDICATE GENERAL SCOPE OF WORK AND OBVIOUS NEEDS FOR THIS BUILDING. THE OWNER AND THE ARCHITECT AND THE REGULATORY AUTHORITIES RELY UPON THE SKILLS AND EXPERIENCE OF SKILLED TRADESPEOPLE, INCLUDING THE MASTER ELECTRICIAN; MASTER PLUMBER; AND MASTER MECHANICAL CONTRACTORS, TO COMPLY WITH ALL APPLICABLE ASPECTS OF CURRENT CODES AND REGULATIONS.
- CONTRACTOR IS RESPONSIBLE FOR ENSURING CODE COMPLIANCE WITH ALL NEW MEP WORK. CONTRACTOR SHALL COORDINATE ALL NEW HVAC AND ELECTRICAL LOCATIONS WITH THESE DOCUMENTS. IF CONFLICTS BETWEEN SITE CONDITIONS AND THESE DOCUMENTS ARISE, CONTRACTOR SHALL NOTIFY ARCHITECT IMMEDIATELY PRIOR TO PROCEEDING WITH WORK. ALL HVAC INDICATED IS FOR DESIGN INTENT ONLY AND SHALL BE ENGINEERED BY HVAC CONTRACTOR.
- DRAWINGS REPRESENT ASSUMPTIONS OF EXISTING CONDITIONS BASED ON THE BEST AVAILABLE INFORMATION, INCLUDING FIELD MEASUREMENTS AND PRIOR CONSTRUCTION DOCUMENTATION. MANY EXISTING CONDITIONS CANNOT BE VERIFIED UNTIL WALLS, FLOORS AND/OR CEILINGS ARE OPENED UP FOR CONSTRUCTION. DRAWINGS INDICATE INTENT AND SCOPE OF WORK. THE CONTRACTOR SHALL VERIFY ALL EXISTING CONDITIONS IN THE FIELD AND NOTIFY THE ARCHITECT OF ANY DISCREPANCIES PRIOR TO PROCEEDING WITH WORK.
- ALL PLUMBING AND APPLIANCE SELECTIONS BY OWNER. CONTRACTOR SHALL COORDINATE ROUGH OPENING SIZES AND SHALL CONFIRM POWER OR PLUMBING REQUIREMENTS AND APPROPRIATENESS OF FIXTURE SELECTION WITH OWNER AND ARCHITECT. PROVIDE BLOCKING IN WALLS FOR ALL WALL-MOUNTED ACCESSORIES, TYPICALLY CONFIRM EXACT LOCATIONS WITH OWNER.
- WHERE APPLICABLE, BANK ALL EXTERIOR SWITCHES TOGETHER AND ALL INTERIOR SWITCHES TOGETHER.
- CONTRACTOR/INSTALLER TO CONFIRM ALL LOCATIONS AND APPROPRIATENESS OF FIXTURES AND SUPPLY TO EACH APPLIANCE OR FIELD OF EQUIPMENT. ANY HVAC INDICATED IS FOR DESIGN INTENT ONLY AND SHALL BE ENGINEERED BY HVAC CONTRACTOR.
- RESIDENTIAL SPRINKLER SYSTEM IS REQUIRED BASED ON THE FIREFLOW OF THE NEAREST EXT'G. HYDRANT; CONTRACTOR IS REPONSIBLE FOR ENSURING SYSTEM IS CODE COMPLIANT; SYSTEM SHOULD BE ENGINEERED BY PLUMBING AND/OR SPRINKLER CONTRACTOR

GENERAL NOTES

ALL DIMENSIONS OF NEW CONSTRUCTION ARE TO FACE OF ROUGH FRAME UNLESS NOTED OTHERWISE.
 ALL FINISHES, APPLIANCES, PLUMBING FIXTURES, AND LIGHTING FIXTURE SELECTIONS PER DRAWINGS. CONTRACTOR SHALL

- COORDINATE ROUGH OPENING SIZES AND SHALL CONFIRM POWER REQUIREMENTS AND APPROPRIATENESS OF FIXTURE SELECTION. PROVIDE BLOCKING IN WALLS FOR ALL WALL-MOUNTED ACCESSORIES, TYPICALLY - CONFIRM EXACT LOCATIONS WITH OWNER.
- DO NOT SCALE DRAWINGS FOR CONSTRUCTION OR COORDINATION PURPOSES. USE INDICATED DIMENSIONS. IF QUESTIONS ARISE, CONTACT ARCHITECT FOR CLARIFICATION.
- CONTRACTOR SHALL INSTALL ALL FIREBLOCKING AND FIRESTOPPING IN ACCORDANCE WITH AND AS REQUIRED BY BUILDING
 CODE.
- DRAWINGS REPRESENT THE GENERAL INTENT AND SCOPE OF WORK. HOWEVER, NOT ALL PRODUCTS AND INSTALLATIONS ARE DETAILED AND ARE LEFT TO THE DISCRETION OF THE OWNER. CONTRACTOR SHALL CONSULT AND COORDINATE W/OWNER REGARDING ANY ADDITIONAL PRODUCT SELECTIONS AND INSTALLATIONS THAT MAY BE REQUIRED AS PART OF THIS PROJECT, AND CONSULT W/ARCHITECT IF ANY CONFLICTS BETWEEN THESE DOCUMENTS AND OWNER SELECTIONS SHOULD ARISE.
- IT IS THE INTENT OF THESE DOCUMENTS TO PROVIDE A COMPLETE INSTALLATION IN EVERY RESPECT. IF ADDITIONAL DETAILS OF SPECIAL CONSTRUCTION ARE REQUIRED FOR WORK INDICATED OR SPECIFIED, THE CONTRACTOR SHALL PROVIDE THE MATERIALS, EQUIPMENT AND LABOR REQUIRED TO COMPLETE SUCH INSTALLATION AND CONSTRUCTION. AT NO ADDITIONAL COST TO OWNER.
- THE ARCHITECT WILL NOT BE LIABLE OR RESPONSIBLE FOR ANY CLAIMS, DAMAGES, LOSSES OR EXPENSES ARISING FROM, IN CONNECTION WITH, OR RESULTING FROM THE PERFORMANCE (OR THE FAILURE TO PERFORM) OF ANY ASPECT OF CONSTRUCTION OF THIS PROJECT, WHERE THE OWNER OR CONTRACTOR HAS KNOWINGLY AUTHORIZED OR PERMITTED A DEVIATION FROM ANY DOCUMENT PREPARED BY THE ARCHITECT OR WHERE THE OWNER OR CONTRACTOR HAS ELECTED NOT TO FOLLOW ANY WRITTEN RECOMMENDATION OF THE ARCHITECT.
- ALL CONSTRUCTION WORK SHALL COMPLY WITH THE INTERNATIONAL RESIDENTIAL CODE, 2015, AND ALL CITY OF AUSTIN
 DEVELOPMENT ORDINANCES AND ALL APPLICABLE BUILDING CODES.
- THIS SHEET AND THE INFORMATION CONTAINED HEREIN IS PART OF A COMPLETE SET OF DRAWINGS. THIS SHEET SHALL NOT BE SEPARATED FROM THIS SET FOR THE PURPOSES OF REGULATORY APPROVAL, PERMITTING, BIDDING, OR CONSTRUCTION.
- USE CARE SO AS TO PROTECT TREES, VEGETATION AND OTHER NATURAL FEATURES INCLUDING THOSE NOTED TO BE PROTECTED DURING CONSTRUCTION. CONSULT WITH LANDSCAPE DESIGNER FOR TREE AND PLANT PROTECTION PRIOR TO WORK COMMENCEMENT.
- USE CARE WHEN PLACING RETAINING WALL AND FOUNDATION FOOTINGS IN THE VICINITY OF UNDERGROUND PIPES AND UTILITIES. HAND DIG AREAS TO AVOID DAMAGE TO UNDERGROUND LINES. IF UNDERGROUND LINES ARE DAMAGED, CONTRACTOR SHALL REPAIR AT NO ADDITIONAL COST TO OWNER.
- CONTRACTORS AND SUBCONTRACTORS SHALL KEEP SITE FREE OF DEBRIS AT ALL TIMES.
- SIZES FOR DOORS ARE NOMINAL AND CONTRACTOR SHALL VERIFY ACTUAL SIZES AND SUITABILITY FOR OPENING LOCATION WITH THE PRODUCT MANUFACTURER PRIOR TO ORDERING. SIZES FOR WINDOWS ARE ROUGH OPENINGS. ANY DISCREPANCIES SHALL BE BROUGHT TO ARCHITECT'S ATTENTION IMMEDIATELY

GENERAL DEMOLITION NOTES

- DRAWINGS REPRESENT ASSUMPTIONS OF EXISTING CONDITIONS BASED ON THE BEST AVAILABLE INFORMATION, INCLUDING FIELD MEASUREMENTS AND PRIOR CONSTRUCTION DOCUMENTATION. MANY EXISTING CONDITIONS CANNOT BE VERIFIED UNTIL WALLS, FLOORS AND/OR CEILINGS ARE OPENED UP FOR CONSTRUCTION. DRAWINGS INDICATE INTENT AND SCOPE OF WORK. THE CONTRACTOR SHALL VERIFY ALL EXISTING CONDITIONS IN THE FIELD AND NOTIFY THE ARCHITECT OF ANY DISCREPANCIES PRIOR TO PROCEEDING WITH WORK.
- DEMOLITION IS INDICATED BY DASHED LINES. ANY ADDITIONAL DEMOLITION REQUIRED SHALL BE APPROVED BY THE ARCHITECT PRIOR TO PROCEEDING WITH WORK. COORDINATE DEMOLITION PLAN WITH NEW PLAN FOR EXACT EXTENT OF DEMOLITION REQUIRED.
- DISPOSAL OF ANY REMOVED ITEMS SHALL BE COORDINATED WITH AND APPROVED BY THE OWNER.
- USE CARE SO AS TO PROTECT TREES, VEGETATION, AND OTHER NATURAL FEATURES INCLUDING THOSE NOTED TO BE PROTECTED DURING DEMOLITION.
- REPAIR ALL SURFACES AFFECTED BY DEMOLITION (FLOORS, WALLS, CEILINGS) AS REQUIRED AND PREP FOR NEW FINISHES UNLESS NOTED OTHERWISE.
- PROTECT ALL SURFACES AND ITEMS NOT SLATED FOR DEMOLITION FROM DAMAGE. CONTRACTOR SHALL REPAIR ANY DAMAGES AT NO ADDITIONAL COST TO OWNER.
- CONTRACTORS AND SUBCONTRACTORS SHALL KEEP SITE FREE OF DEBRIS AT ALL TIMES.
- DO NOT SCALE DRAWINGS FOR CONSTRUCTION OR COORDINATION PURPOSES. USE INDICATED DIMENSIONS. IF QUESTIONS ARISE CONTACT ARCHITECT FOR CLARIFICATION PRIOR TO PROCEEDING WITH WORK.
- THE ARCHITECT WILL NOT BE LIABLE OR RESPONSIBLE FOR ANY CLAIMS, DAMAGES, LOSSES OR EXPENSES ARISING FROM, IN CONNECTION WITH, OR RESULTING FROM THE PERFORMANCE (OR THE FAILURE TO PERFORM) OF ANY ASPECT OF CONSTRUCTION OF THIS PROJECT, WHERE THE OWNER OR CONTRACTOR HAS KNOWINGLY AUTHORIZED OR PERMITTED A DEVIATION FROM ANY DOCUMENT PREPARED BY THE ARCHITECT OR WHERE THE OWNER OR CONTRACTOR HAS ELECTED NOT TO FOLLOW ANY WRITTEN RECOMMENDATION OF THE ARCHITECT.
- ALL CONSTRUCTION WORK SHALL COMPLY WITH THE INTERNATIONAL RESIDENTIAL CODE, 2015, AND ALL CITY OF AUSTIN
 RESIDENTIAL DEVELOPMENT ORDINANCES.

TYP. CONSTRUCTION NOTES

- PROVIDE WIRING AND POWER FOR NEW SECURITY SYSTEM. LOCATE W/ OWNER.
- PROVIDE WIRING FOR SPEAKERS THROUGHOUT. LOCATE W/ OWNER.
- PROVIDE SMOKE DETECTORS W/ CARBON MONOXIDE DETECTOR (HARDWIRED) THROUGHOUT HOUSE AS REQUIRED BY CODE.
- ALL INTERIOR DRYWALL SURFACES TO BE MIN. LEVEL 5 FINISH ALL INTERIOR FLOORING TRANSITIONS TO BE FLUSH, U.N.O.
- PROVIDE BLOCKING FOR ALL BATHROOM ACCESSORIES. COORDINATE LOCATIONS WITH OWNER.
- TYPICAL ROOF ASSEMBLY: STANDING SEAM ROOFING OVER 5/8" CDX PLYWOOD SHEATHING OVER RAFTERS PER STRUCTURAL. PROVIDE MIN R-38 BIBS INSULATION.
- INSTALL TILE OVER HARDIEBACKER BOARD IN ACCORDANCE W/ HARDIEBACKER INSTALLATION INSTRUCTIONS, TCNA (TILE COUNCIL OF NORTH AMERICA) AND IRC 2015. TAPE ALL JOINTS.
- PROVIDE NEW HEAT PUMP WATER HEATER REFER TO MECHANICAL.
- PROVIDE NEW GUTTERS AND DOWNSPOUTS AROUND HOUSE. DOWNSPOUT LOCATIONS ARE SHOWN FOR DESIGN INTENT ONLY -SIZES AND LOCATIONS SHOULD BE CONFIRMED WITH CALCULATED WATER RUN-OFF. (REFER TO A-201 AND A-202, EXTERIOR ELEVATIONS)


TYP. BUILDING ENCLOSURE NOTES

•	ENVELO	PE ASSEMBLY OPTION 01: PROVIDE DELTA-VENT AS WATER & AIR BARRIER SYSTEM OVER ALL EXTERIOR SHEATHING.
	USE ONL	Y INTEGRAL DELTA PRODUCTS PER MANUFACTURER'S INSTRUCTION.
	•	PROVIDE (1.25" ROCKWOOL COMFORTBOARD 80) CONTINUOUS INSULATION OVER ALL EXTERIOR WALLS

- **ENVELOPE ASSEMBLY OPTION 02:** PROVIDE ZIP R-6 PANEL SHEATHING AND CONTINUOUS INSULATION. USE INTEGRAL HUBER/ZIP TAPES AND FLASHINGS. PROVIDE KEENE EASY-FUR 10MM FURRING STRIPS BETWEEN WRB AND EXTERIOR FINISH.
- INSTALL AERO BARRIER (HTTPS://AEROBARRIER.NET) CONTACT SEAN HARRIS AT IAQ TEXAS FOR INSTALLATION.
- INSTALL BIBS (BLOWN-IN BLANKET SYSTEM) BETWEEN ALL WOOD STUDS AND ROOF RAFTERS.

AS-BUILT NOTE

AS-BUILT DRAWINGS WERE CREATED BY JAROD HARMEIER WITH AUSTIN FLOOR PLANS. AS-BUILT DRAWINGS WERE PROVIDED TO ARCHITECT BY OWNERS ROCKY MOUNTAIN AND DAVID ROWE.

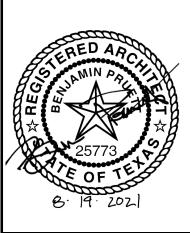



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A-002					

CITY OF AUSTIN - SITE DEVELOPMENT INFORMATION **MOUNTAIN - ROWE RESIDENCE** ROOF GABLE 1519 W. 32ND ST., AUSTIN, TX 78703 EXCEPTION (3.b.ii) LEGAL DESCRIPTION: <u>LOT SIZE = 11,074 SQ. FT.</u> CITY OF AUSTIN ZONING SF-3-NP 25'-0" FRONT YARD SETBACK 45% MINIMUM IMPERVIOUS COVER 5'-0" SIDE YARD SETBACK, 15'-0" STREET SIDEYARD SETBACK 40% MAXIMUM BUILDING COVER FAR: .4:1 10'-0" REARYARD SETBACK LOCATED WITHIN THE DESIGN AND COMPATIBILITY ORDINANCE AREA **BUILDING & SITE AREA** EXISTING SQ. FT. NEW/ADDED SQ. FT. TOTAL SQ FT AREA DESCRIPTION NOTE MEASUREMENTS ARE TO THE OUTSIDE SURFACE OF EXTERIOR WALL TO REMAIN └── TENT 2 = 619.8' 1,933 a) 1ST FLOOR CONDITIONED AREA 1,578 355 b) 2ND FLOOR CONDITIONED AREA N/A 1,637 1,637 c) 3RD FLOOR CONDITIONED AREA N/A N/A N/A N/A d) BASEMENT N/A N/A e) DETACHED COVERED PARKING (GARAGE OR CARPORT) 521 521 0 f) COVERED PATIO, DECK, PORCH, AND/OR BALCONY AREAS (FRONT) 419 0 419 g) COVERED PATIO, DECK, PORCH, AND/OR BALCONY AREAS (REAR) 266 231 497 h) COVERED WOOD DECKS N/A N/A N/A MAX BUILDING HT (650.13') <u>27' - 10"</u> 2,784 5,007 TOTAL BUILDING AREA (TBA) (TOTAL a THRU h) 0 (SUBTRACT b, c, d, AND h) TOTAL BUILDING COVERAGE (TBC) 2,784 0 3,370 $\frac{\text{UPPER LEVEL CLG}}{\underline{20' - 0''}} \quad \textcircled{\bullet}$ 1,071 1,576 -505 j) DRIVEWAY -96 k) SIDEWALKS 96 0 I) UNCOVERED WOOD DECK (GARAGE) 0 0 0 9 12 n) A/C PADS AND OTHER CONCRETE FLATWORK 21 o) OTHER (STONE WALL) 0 0 0 NEW UPPER LEVEL <u>11' - 0"</u> TOTAL SITE IMPERVIOUS COVERAGE (ADD TBC AND I THRU q) 4,455 -3 4,462 p) POOL N/A 550 550 ENTRY LEVEL (622.3') <u>0"</u> q) SPA N/A N/A N/A BUILDING COVERAGE INFORMATION AVG. NATURAL GRADE Note: Building Coverage means the area of a lot covered by buildings or roofed areas, but excludes ground level paving, landscaping, open recreational facilities, (618.13') <u>618' - 1 1/2"</u> incidental projecting eaves, balconies, and similar features. Pools, ponds, and fountains are not included in this measurement (LDC 25-1-21). LOT AREA (SQ. FT.): 11,074 S.F. EXISTING BUILDING COVERAGE (SQ. FT.) <u>2,784</u> % OF LOT SIZE 25.1% (SQ. FT.) 3,370 % OF LOT SIZE <u>30.4%</u> PROPOSED BUILDING COVERAGE IMPERVIOUS COVERAGE INFORMATION Note: Impervious cover is the total horizontal area of covered spaces, paved areas, walkways, and driveways. The term excludes pools, ponds, fountain, and DO NOT DIG MORE THAN THE areas with gravel placed over pervious surFaces that are used only for landscaping or by pedestrians (LDC 25-1-23). ALLOWED 4" MAX. FOR NEW CONCRETE RIBBON DRIVE WITHIN EXISTING IMPERVIOUS COVER (SQ. FT.) 4,465 % OF LOT SIZE <u>40.3%</u> THE 1/2" CRITICAL ROOT ZONE PROPOSED IMPERVIOUS COVER (SQ. FT.) <u>4,462</u> % OF LOT SIZE 40.3% CITY OF AUSTIN - SUBCHAPTER F **GROSS FLOOR AREA** EXTEND STONE CHIMNEY AND ∉LUÉ This section is only required for projects located within the Residential Design and Compatibility Standards Ordinance Boundaries as defined and illustrated WITH SECOND LEVEL ADDITION in Title 25-2 Subchapter F of the Land Development Code. The Gross Floor Area of each floor is measured as the area contained within the outside edge of REFER TO EXTERIOR ELEVATION the exterior walls. TOTAL EXISTING EXEMPTION NEW ST 32ND

9' - 8 7/16"

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5

NEW GRAVEL WALKWA

6" HALF ROUNØ GØTTER

NEW STANDING/SEAM

AND DOWNSPOU[†], T**Y**₽ICAL

METAL ROOF OVER EXISTING

(PERVIDUS)

/ /porch

4 34 E 49°18'

1ST FLOOR	1,578 SQ. FT.	355		1,933 SQ.FT.
2ND FLOOR	N/A	1,637		1,637
3RD FLOOR	N/A	N/A		N/A
AREA W/ CEILINGS > 15'	N/A	N/A		N/A
GROUND FLOOR PORCH	685 SQ.FT.	241	926 SQ. FT.	0 SQ. FT.
BASEMENT	N/A	N/A	N/A	N/A
ATTIC	N/A	N/A	N/A	N/A
GARAGE (ATTACHED)	N/A	N/A	N/A	N/A
GARAGE (DETACHED)	521 SQ. FT.	N/A	450 SQ. FT.	71 SQ. FT.
CARPORT (ATTACHED)	N/A	N/A	N/A	N/A
CARPORT (DETACHED)	N/A	N/A	N/A	N/A
ACCESSORY BUILDINGS (DETACHED)	N/A	N/A		N/A
TOTALS	2,784 SQ. FT.	2,233	1366 SQ.FT.	3,641 SQ. FT.
(TOTAL GROSS	FLOOR AREA/LOT SIZE) X 100	<u>32.9</u>	FLOOR-TO-AREA-RATIO (FAR)	

TREE PERMIT NOTES

THE SCOPE OF WORK OUTLINED IN THESE DOCUMENTS DOES NOT INTERFERE WITH THE 1/2 CRITICAL ROOT ZONES OF THE EXISTING PROTECTED TREES ON THIS LOT, EXCEPT WHERE NEW CONCRETE RIBBON DRIVEWAY IS PROPOSED. ANY DIGGING REQUIRED FOR NEW CONCRETE DRIVEWAY IS NOT TO EXCEED 4" WHERE IN THE 1/2 CRIICAL ROOT ZONE OF ADJACENT PROTECTED TREES.

SITE PLAN REFLECTS SURVEY INFORMATION PROVIDED BY DAVID L. ELZY R.P.LS. # 4675 AT WESTAR ALAMO LAND SURVEYORS, LLC. DATED 11/10/2020. SURVEY WAS PROVIDED TO ARCHITECT BY OWNERS DAVID ROWE AND ROCKY MOUNTAIN


HIGH POINT OF GRADE

LOW POINT OF GRADE UTILITY TRENCHING AS REQUIRED FOR THE SCOPE OF WORK PROPOSED IN THESE DOCUMENTS SHALL AVOID ALL PROTECTED TREE 1/2 CRZS

AVERAGE NATURAL GRADE = (620' + 616.25') /2 = 618.13'

= 620'

= 616.25'

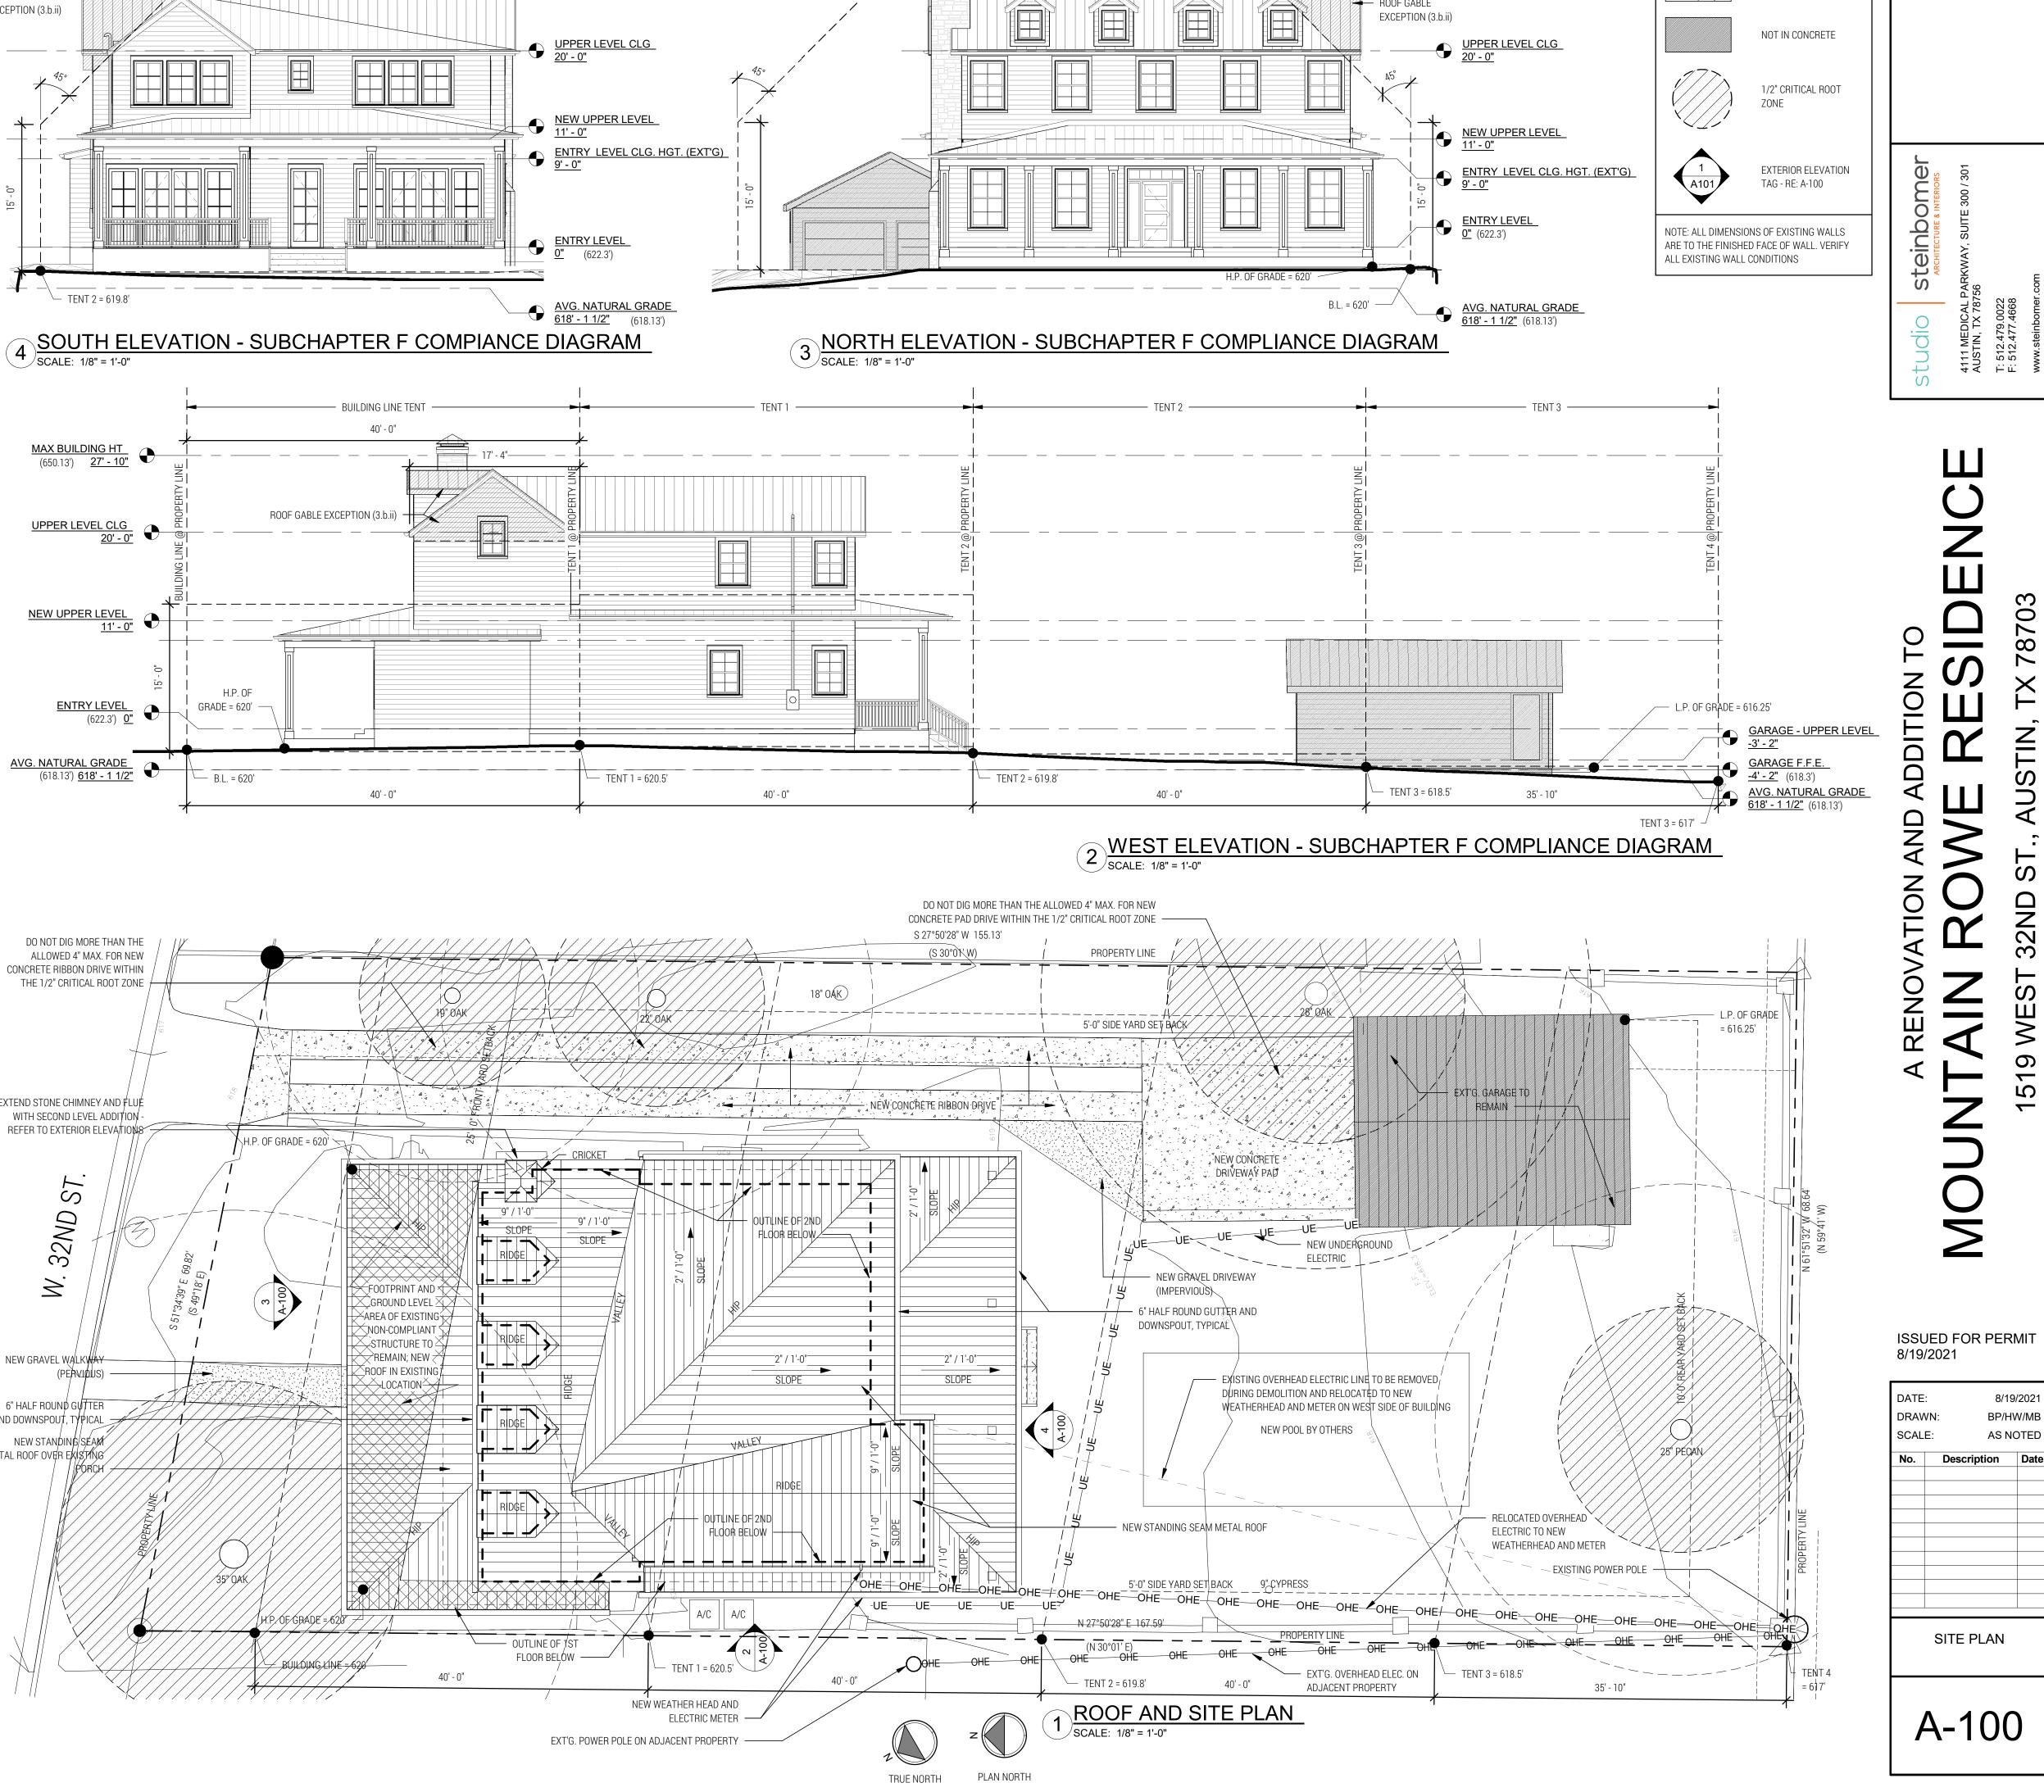

CHIMNEY EXEPTION

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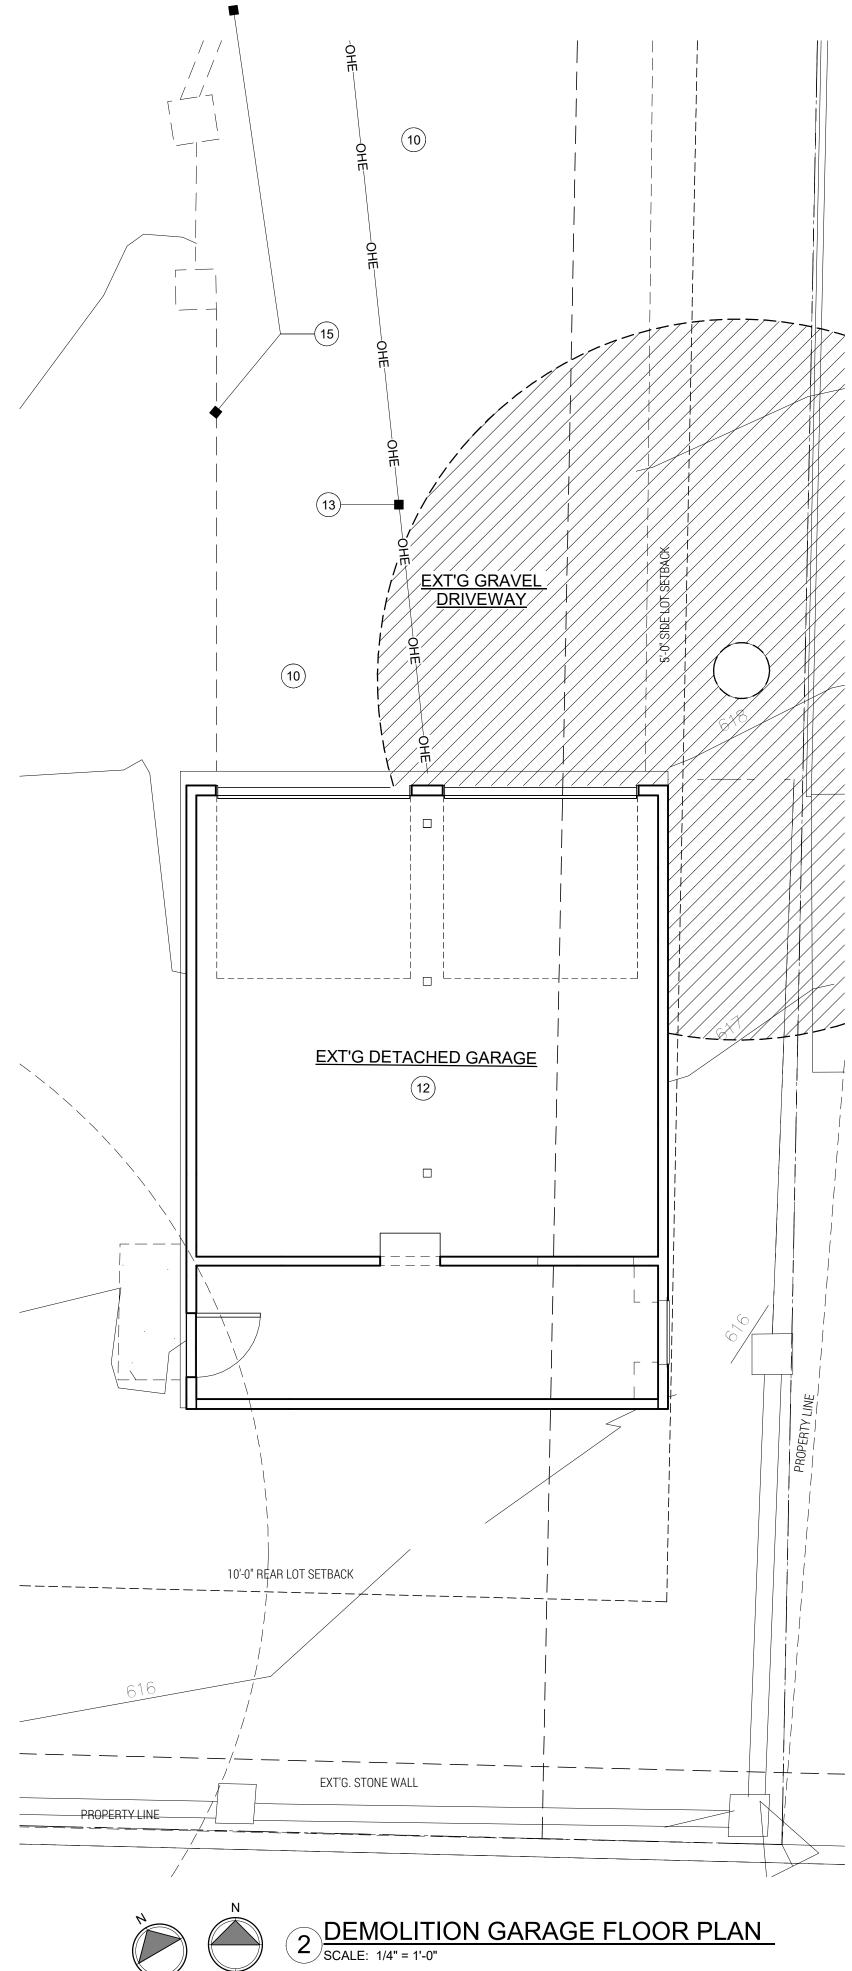
NEW CONCRETE

LEGEND


8' - 8 5/16"


🗕 ROOF GABLE


- MAX BUILDING HT 27' - 10" (650.13')




TRUE NORTH PLAN NORTH

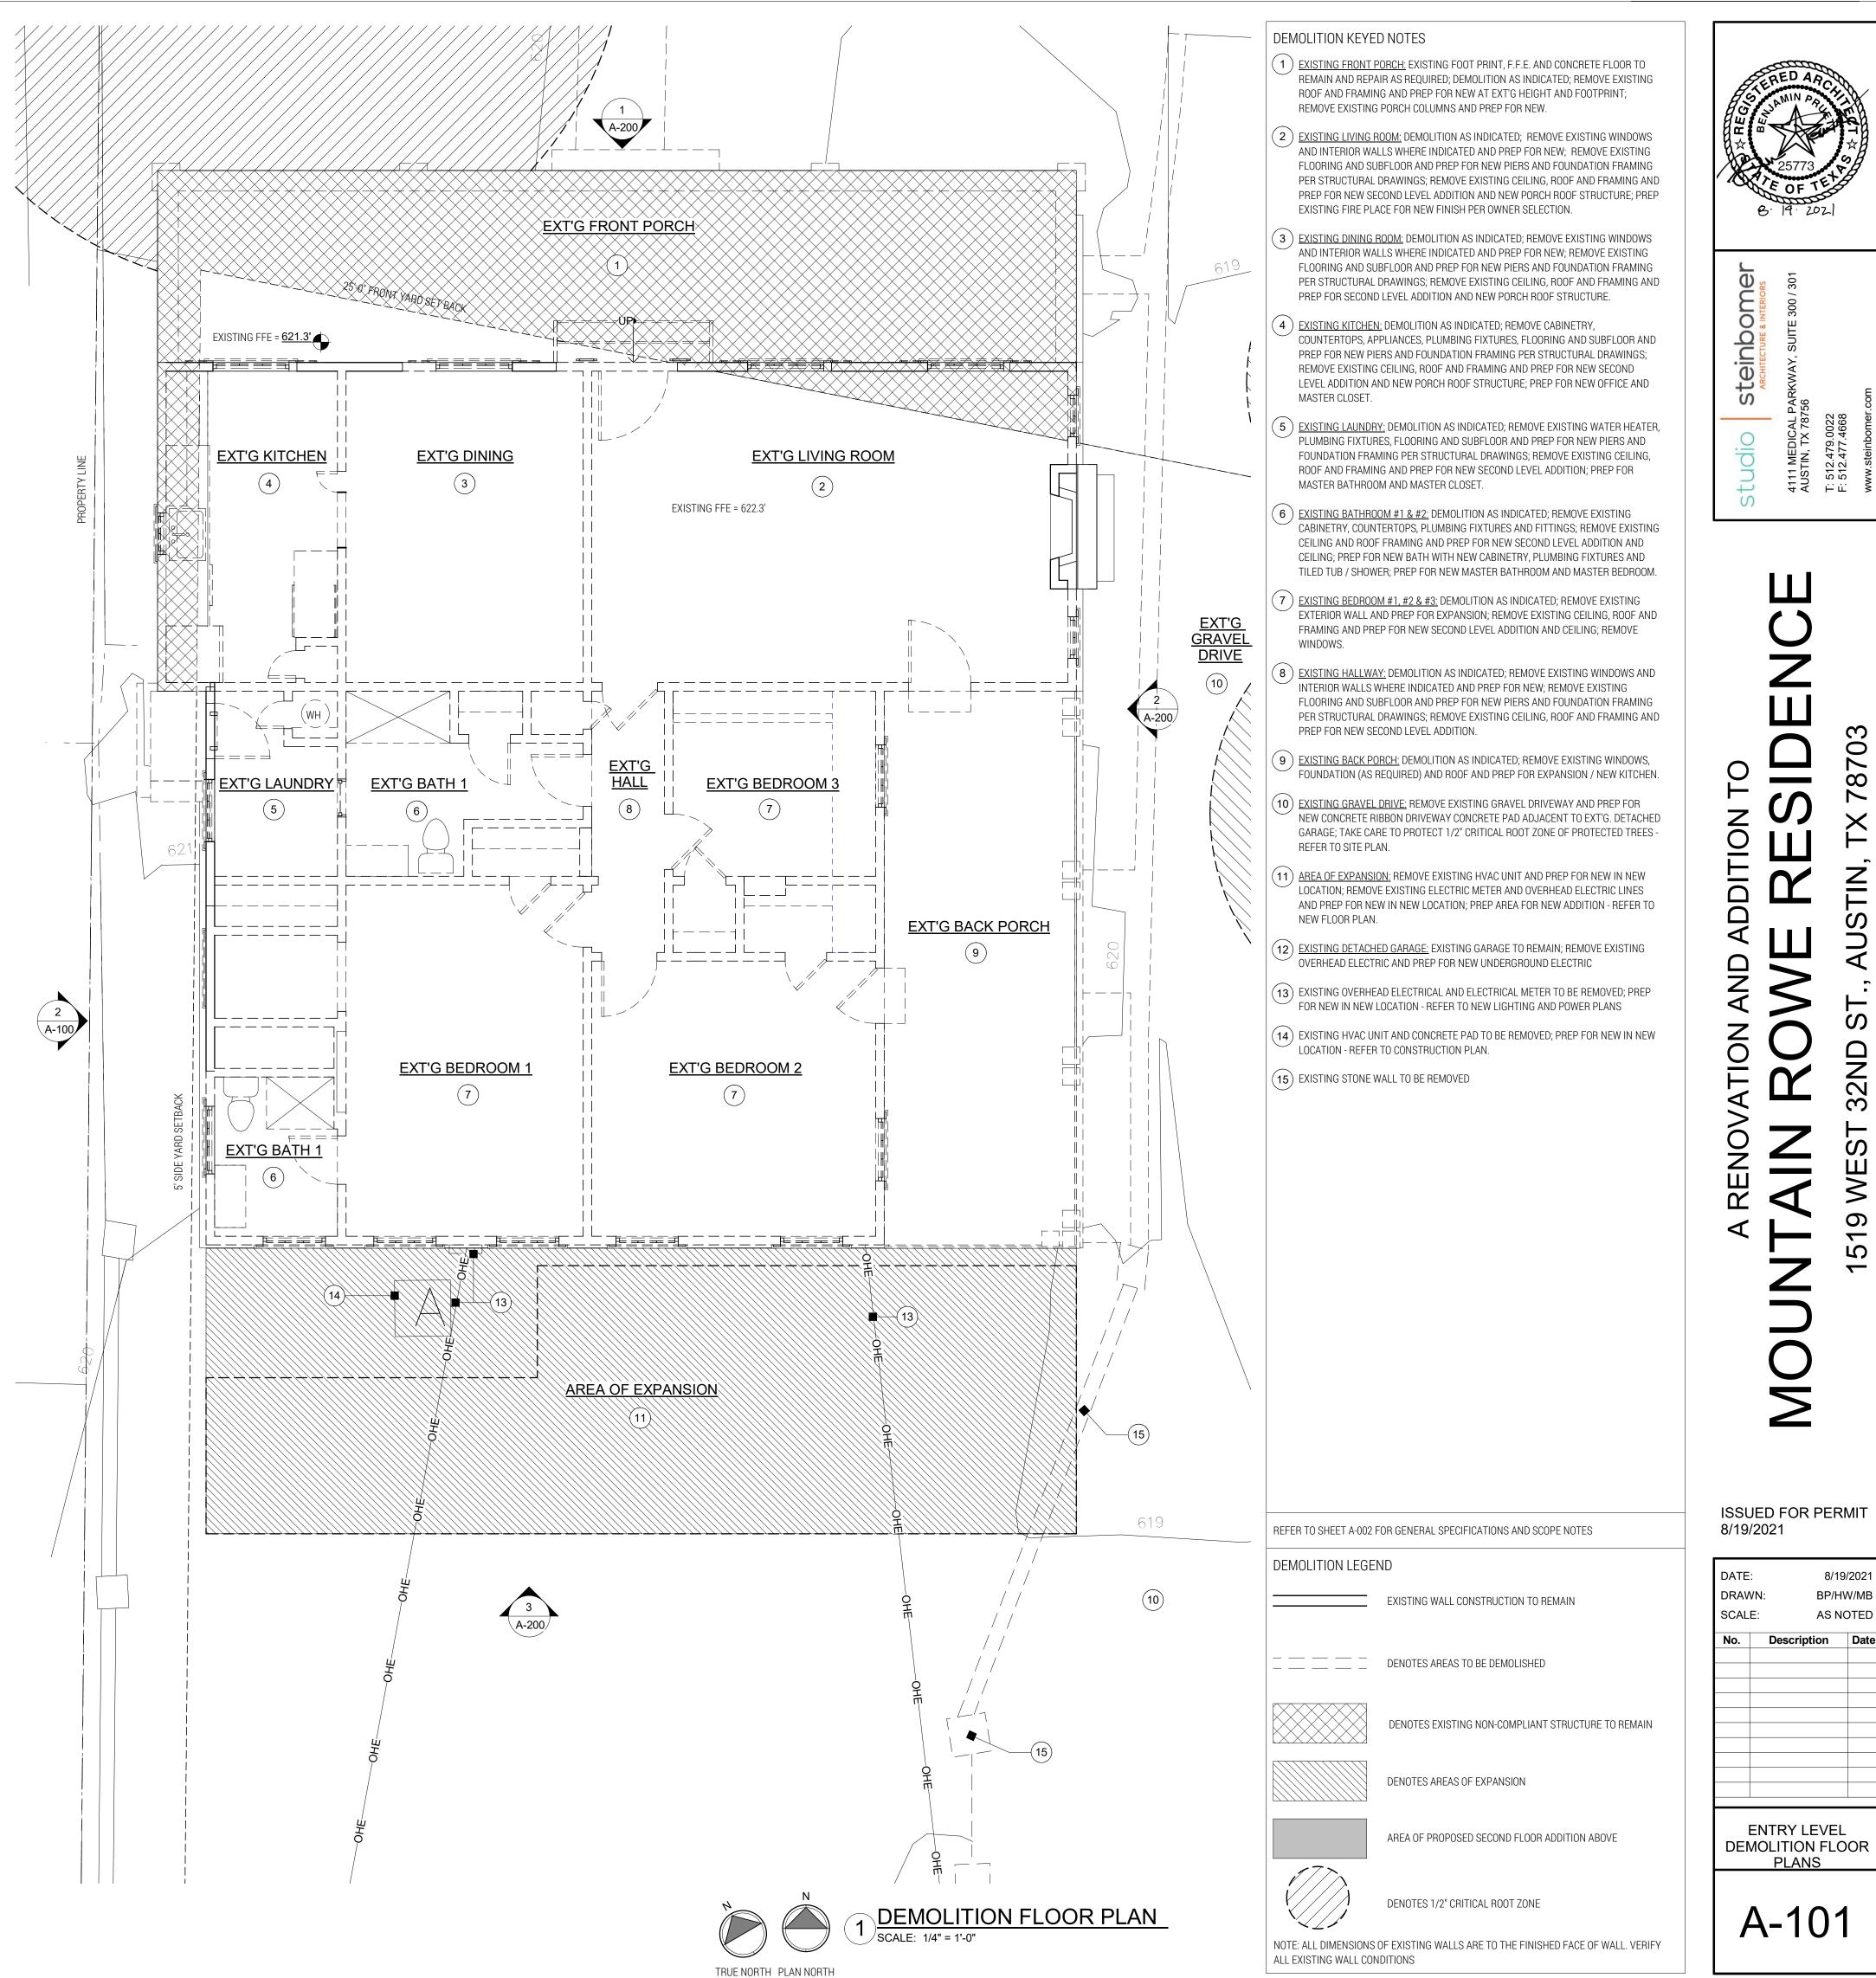


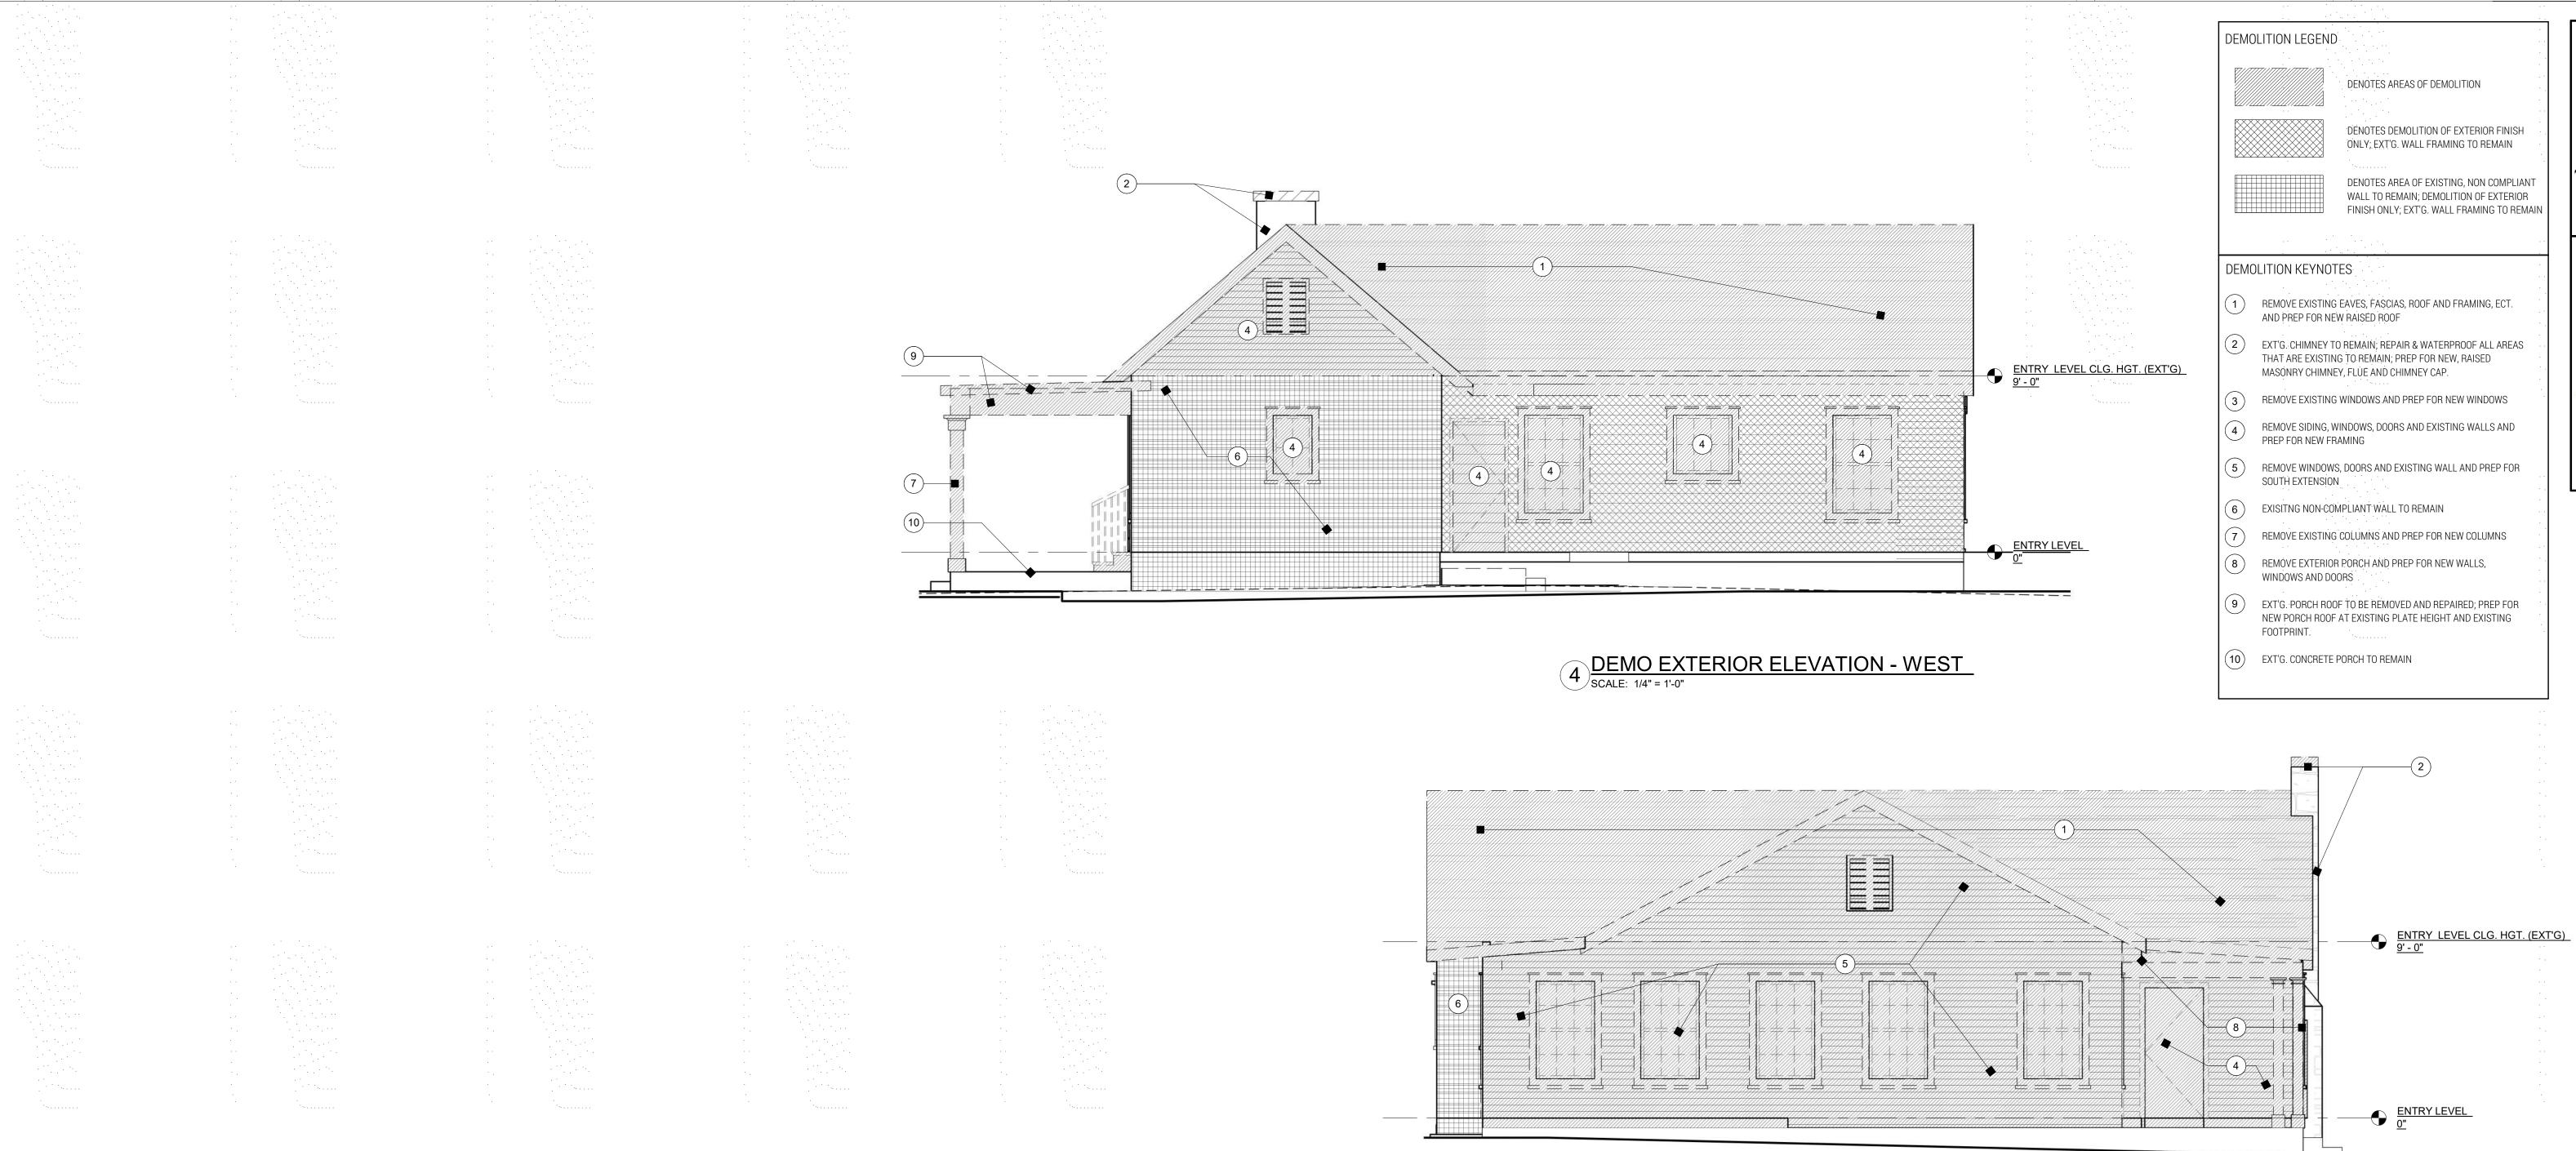


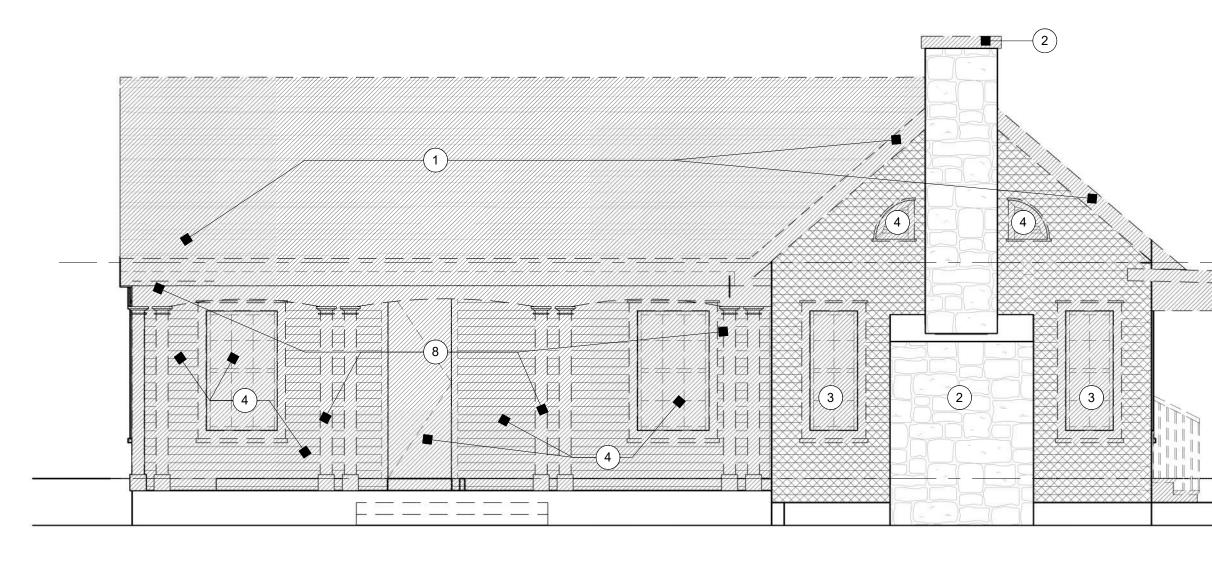

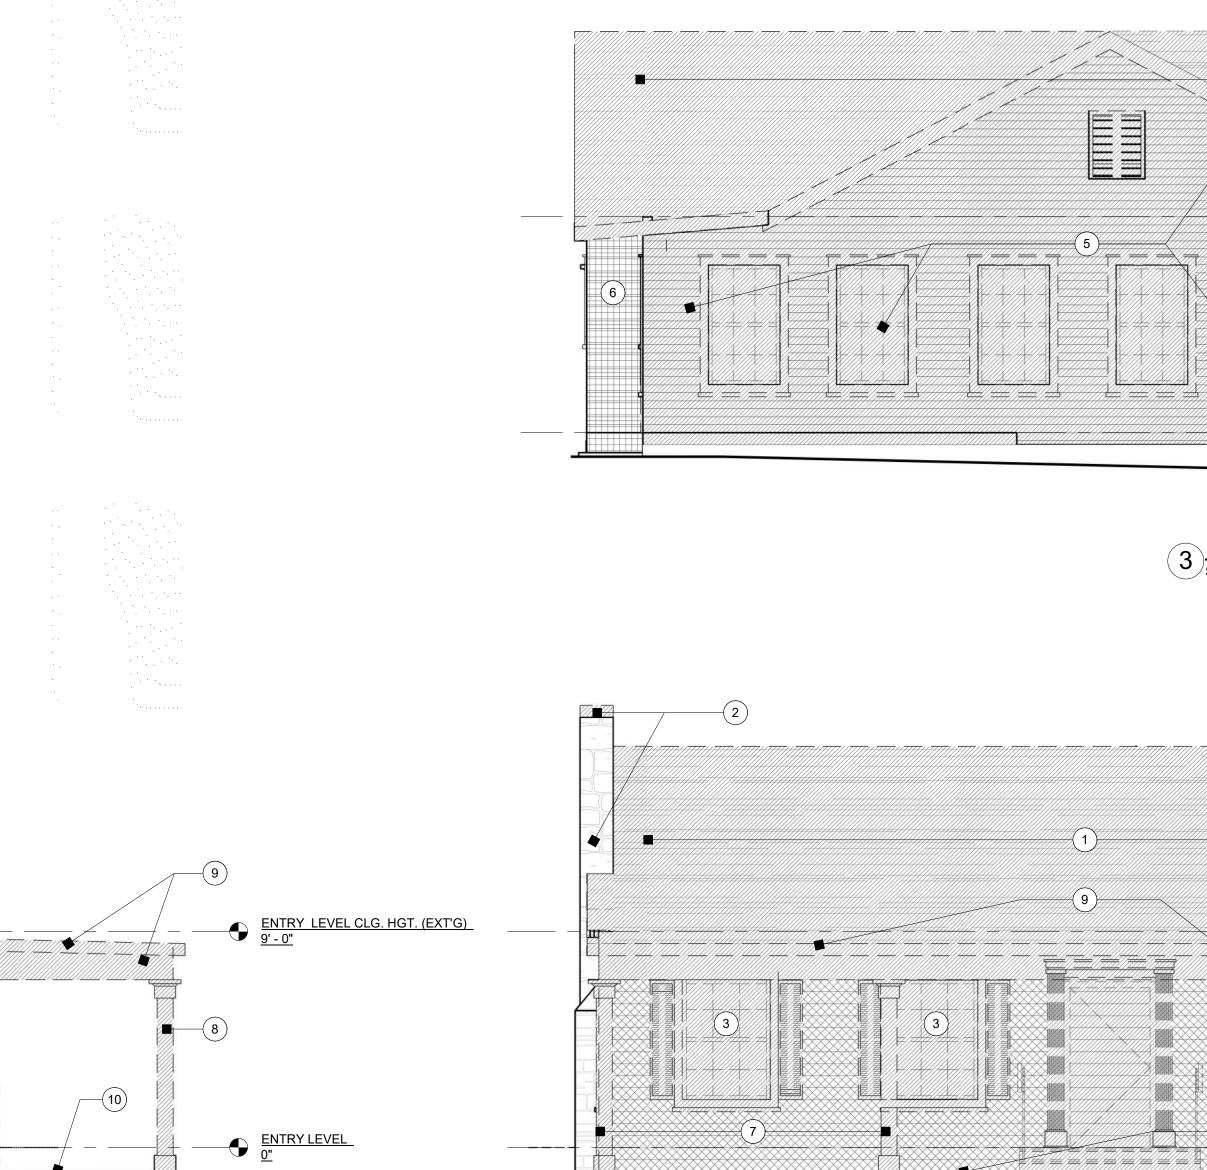

1 DEMO EXTERIOR ELEVATION - NORTH SCALE: 1/4" = 1'-0"

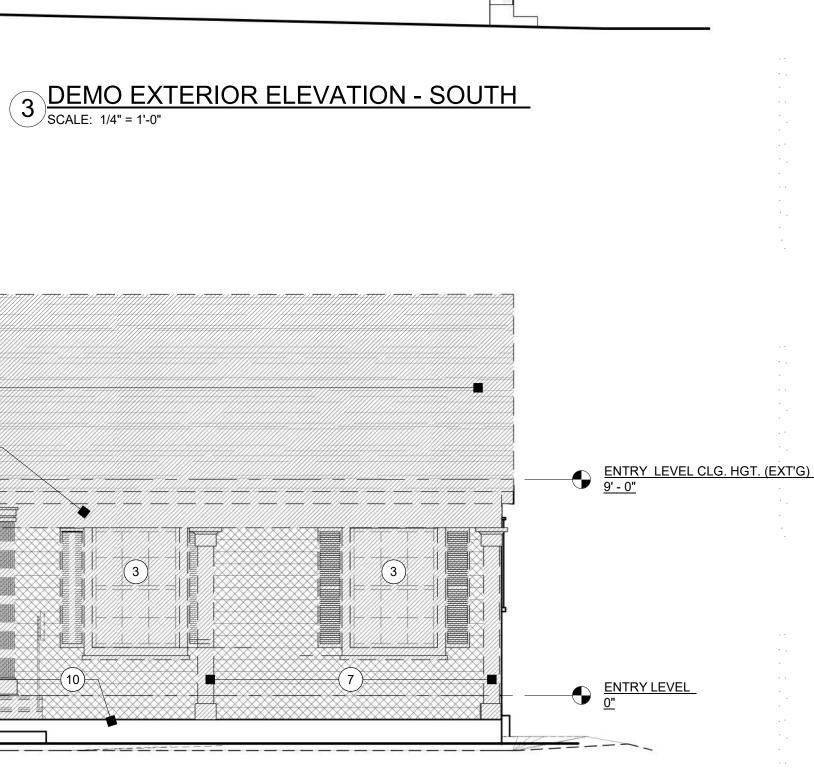

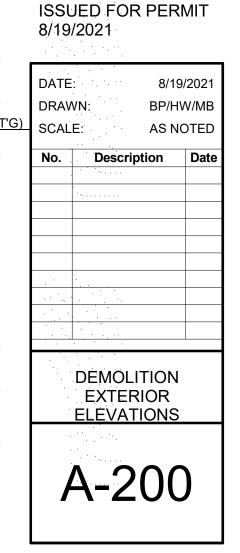



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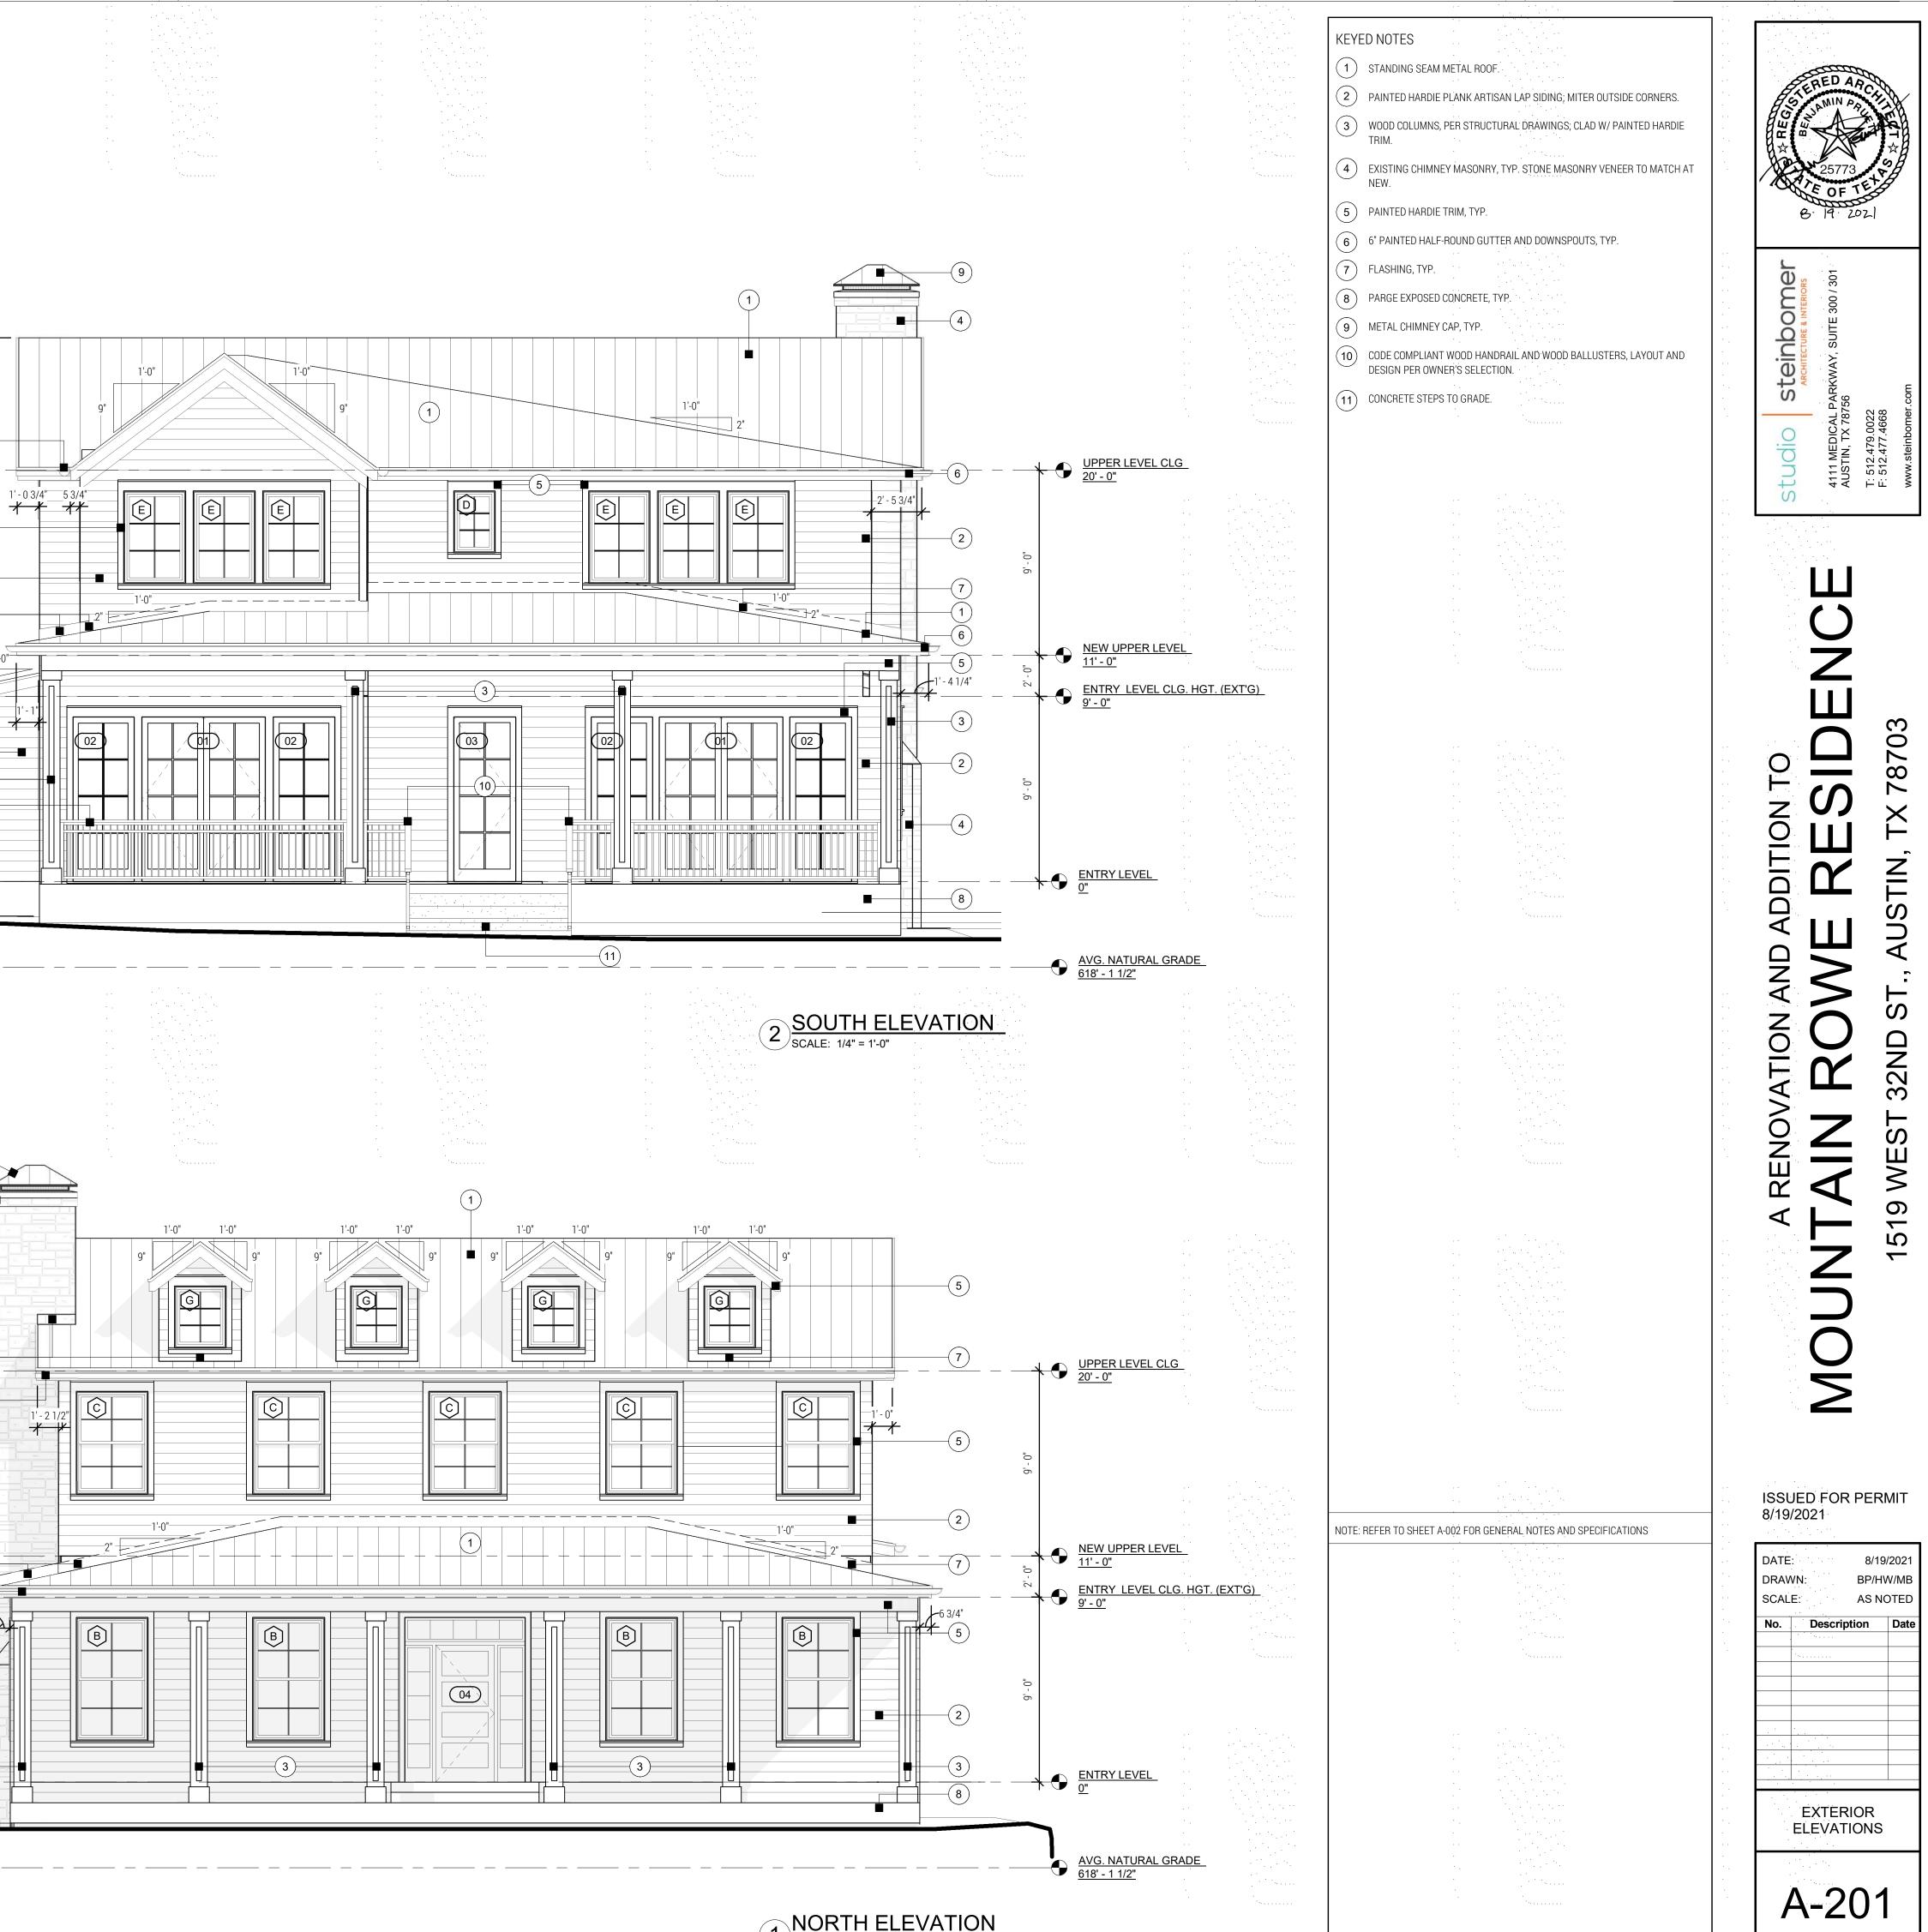
6


3


6 3/4"**--**

RIDGE

1 NORTH ELEVATION SCALE: 1/4" = 1'-0"



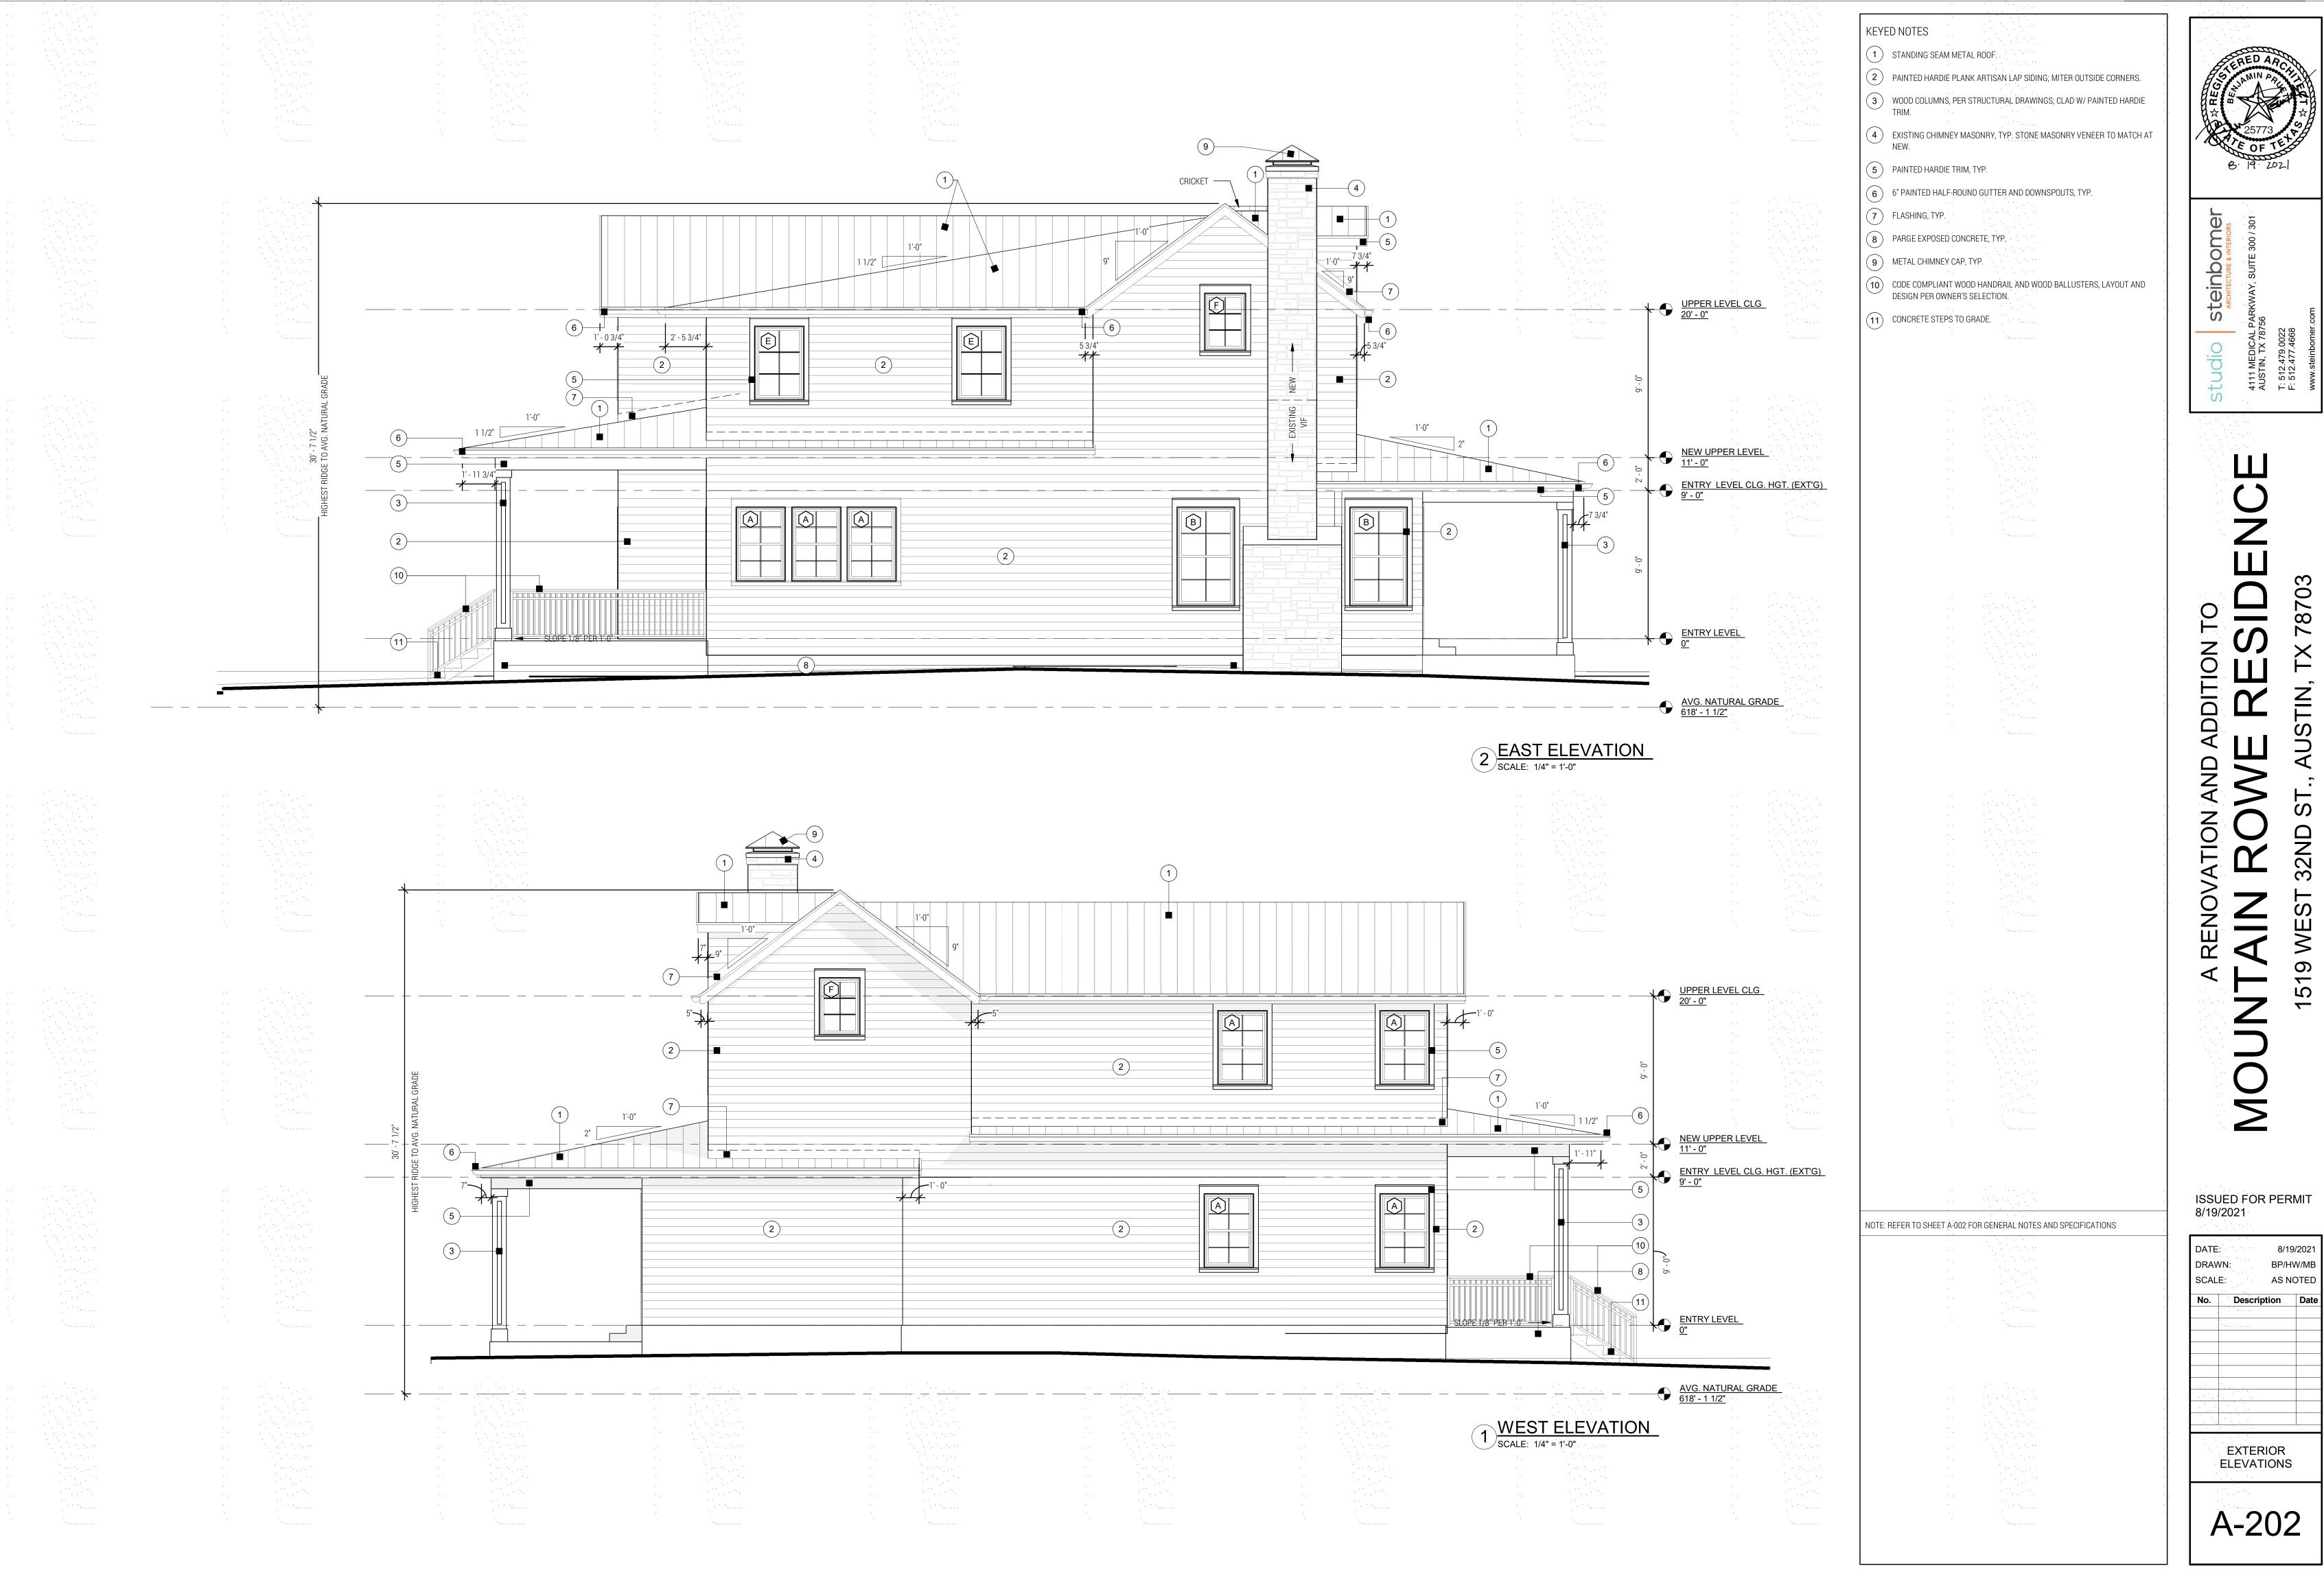


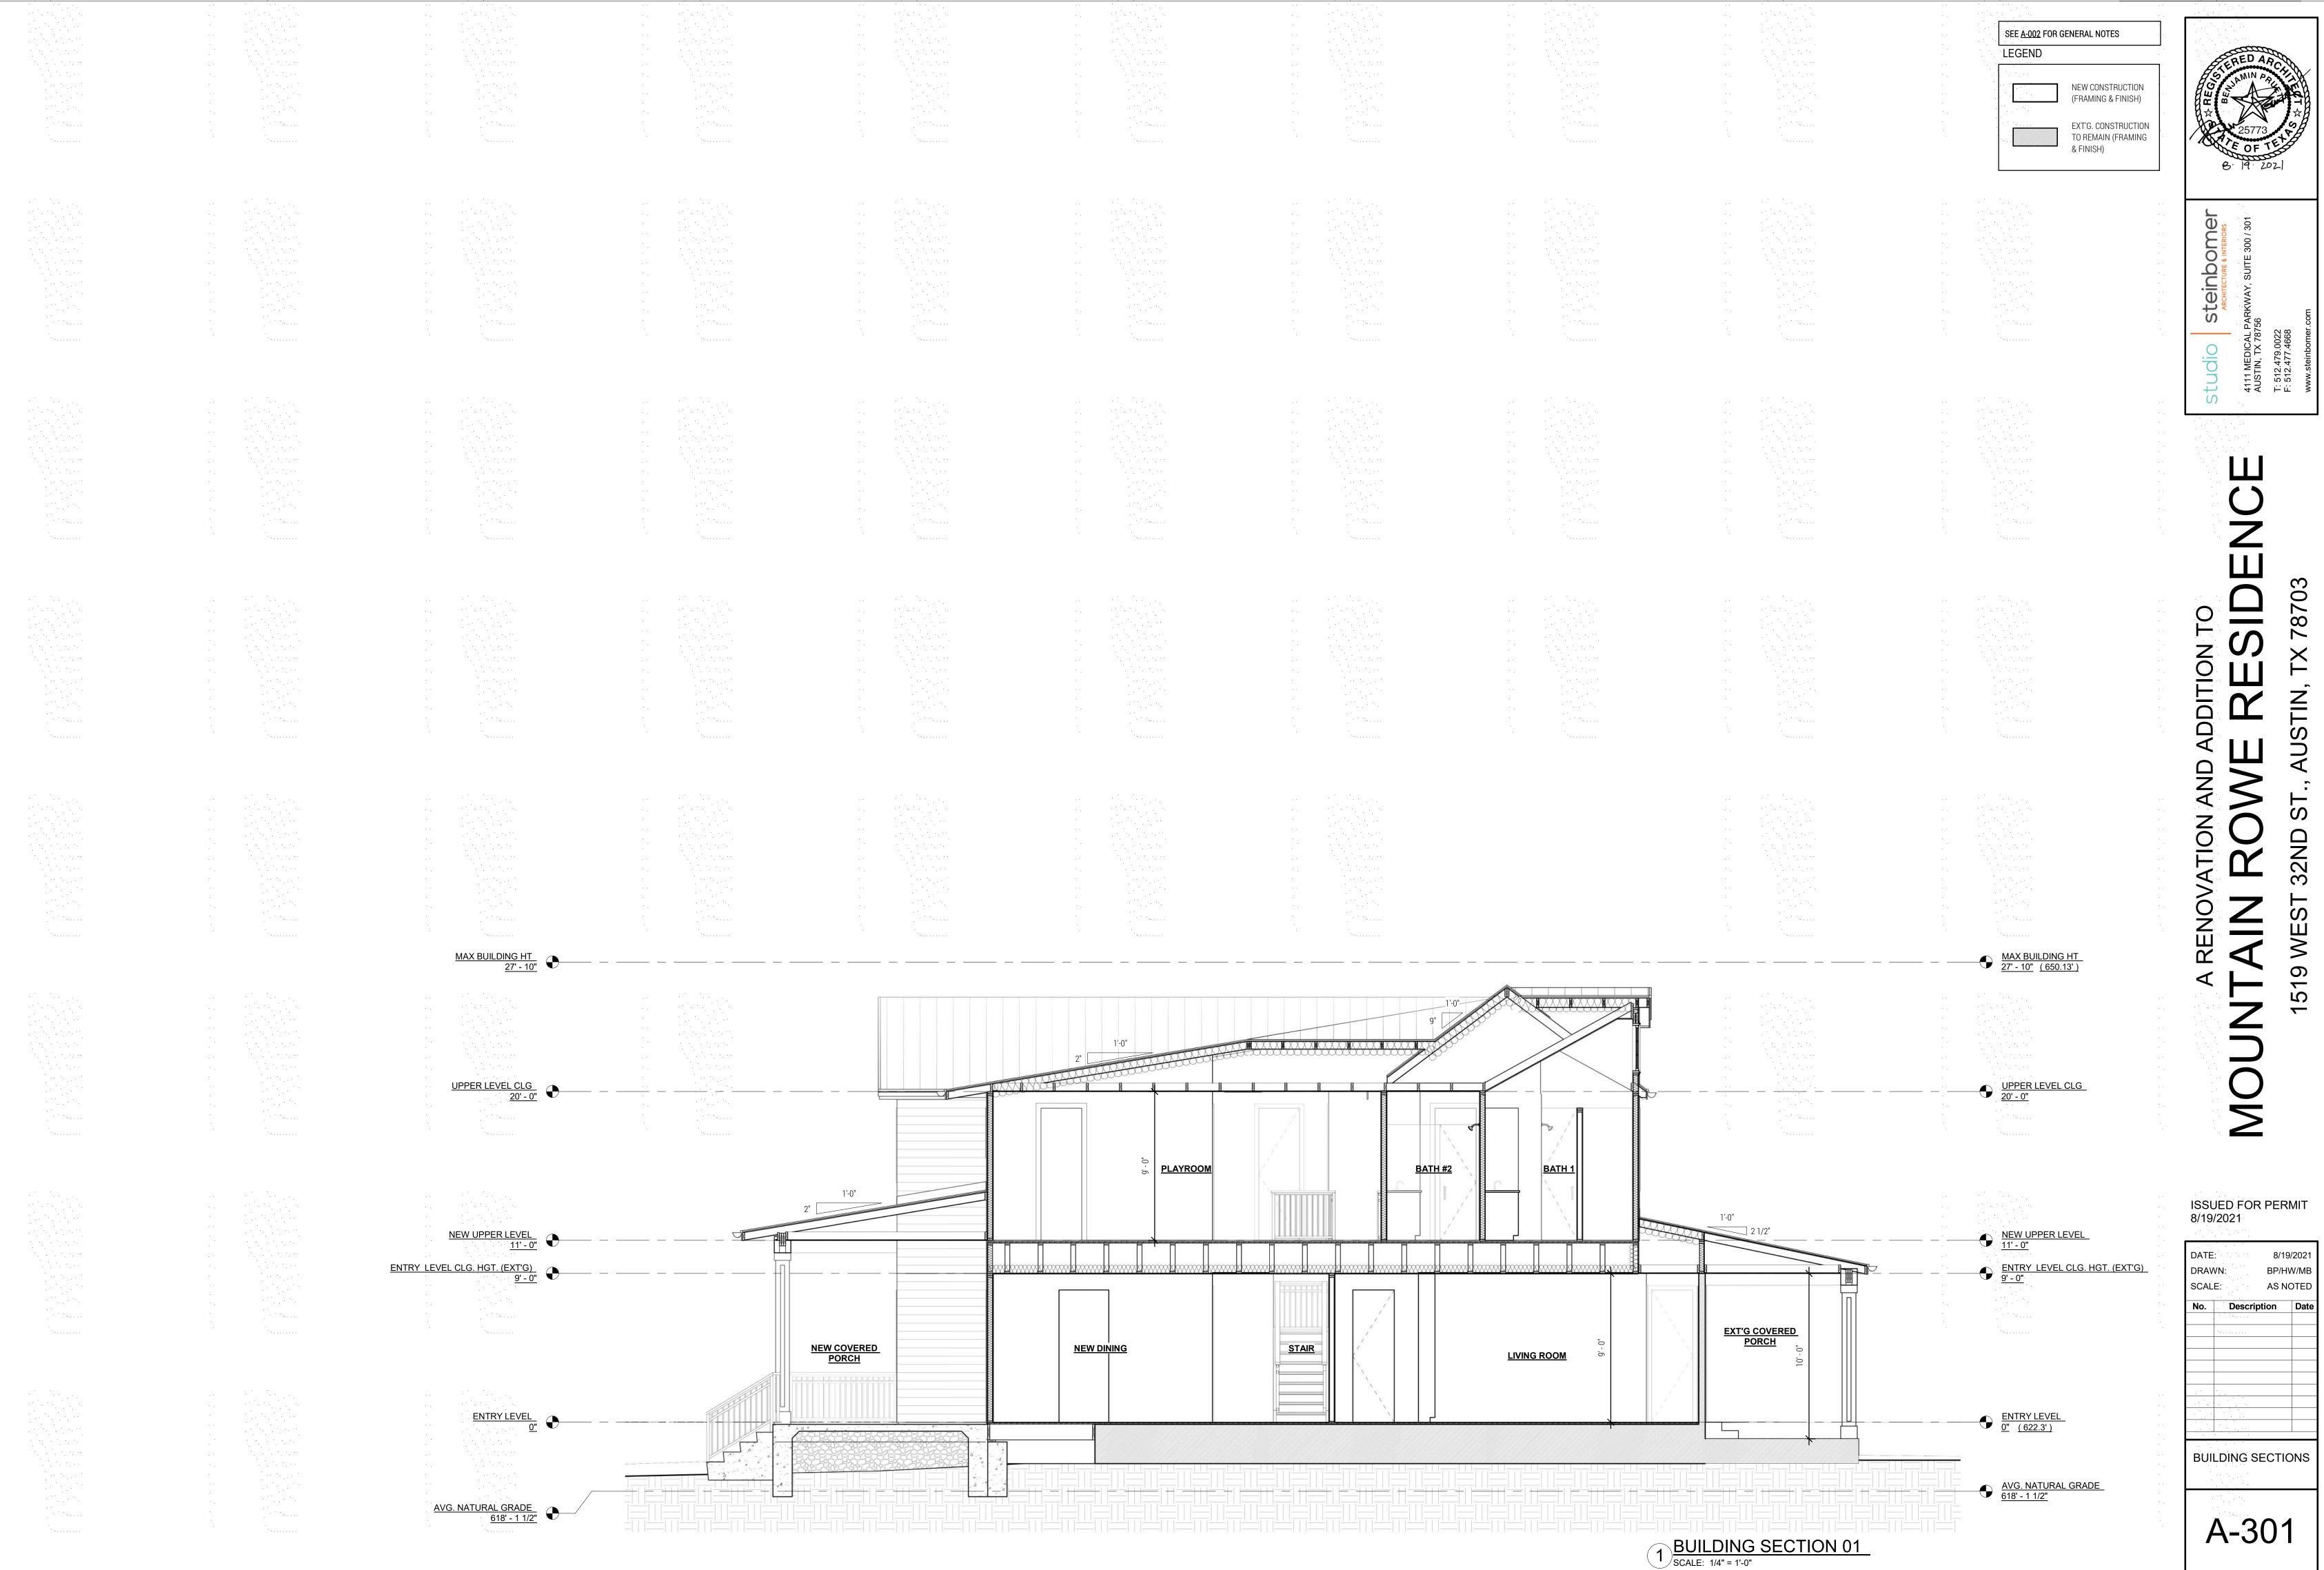


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<u>(06A</u>)	2 ⁴ 8 ⁰ PA POCKE OWNEF
(06B)	2 ⁶ 8 ⁰ PA POCKE OWNEF
060	3 ⁰ 8 ⁰ PA POCKE OWNEF
(06D)	2 ⁴ 6 ⁸ P/ POCKE OWNEF




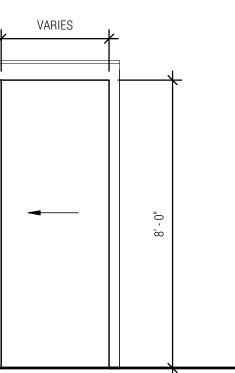


- PAINTED, SOLID CORE INTERIOR, KET DOOR; STYLE AND FINISH PER ER SELECTION
- ^D PAINTED, SOLID CORE INTERIOR, :KET DOOR; STYLE AND FINISH PER NER SELECTION
-) PAINTED, SOLID CORE INTERIOR, KET DOOR; STYLE AND FINISH PER NER SELECTION
- ³ PAINTED, SOLID CORE INTERIOR, :KET DOOR; STYLE AND FINISH PER NER SELECTION

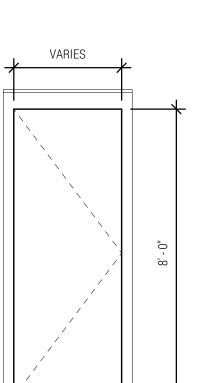


- **05A** 2⁶8⁰ PAINTED, SOLID CORE INTERIOR, SWING DOOR; STYLE AND FINISH PER OWNER SELECTION
- **05B** 2⁴8⁰ PAINTED, SOLID CORE INTERIOR, SWING DOOR; STYLE AND FINISH PER OWNER SELECTION
- **05C** 2⁸8⁰ PAINTED, SOLID CORE INTERIOR, SWING DOOR; STYLE AND FINISH PER OWNER SELECTION
- **05D** 3⁰8⁰ PAINTED, SOLID CORE INTERIOR, SWING DOOR; STYLE AND FINISH PER OWNER SELECTION

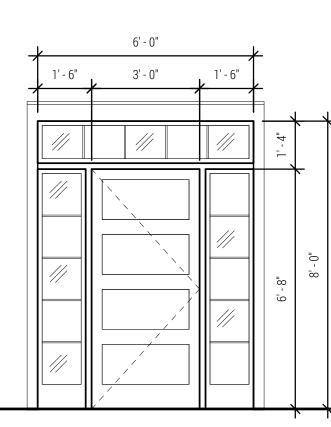



04 3⁰6⁸ EXTERIOR, SOLID CORE, WOOD, SWING DOOR W/ SIDELITES AND TRANSOM ABOVE W/ DIVIDED LITES; STYLE AND FINISH PER OWNER SELECTION

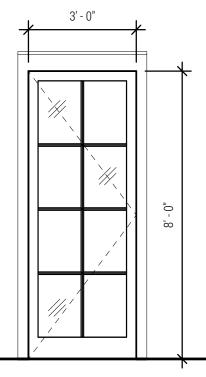


03 3⁰8⁰ EXTERIOR, FULL-LITE GLASS, SWING DOOR WITH DIVIDED LITES; STYLE AND FINISH PER OWNER SELECTION

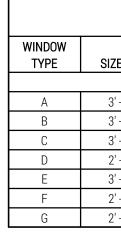

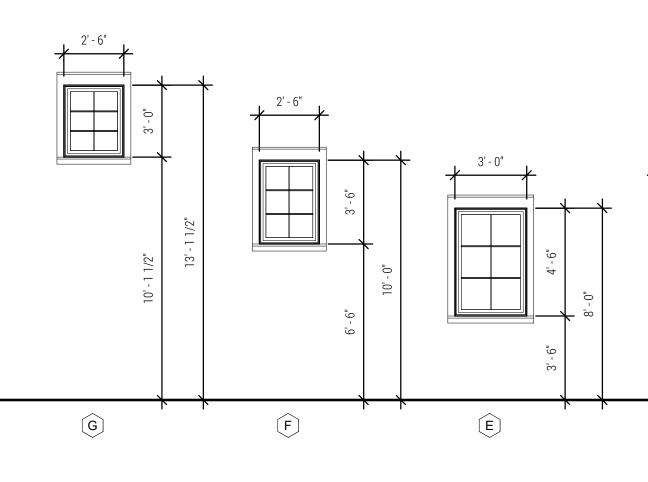

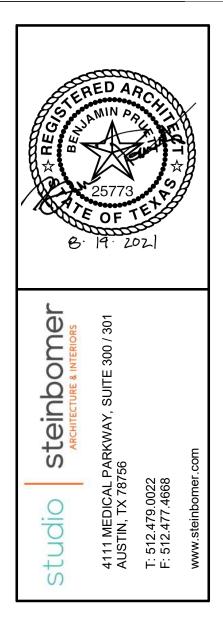

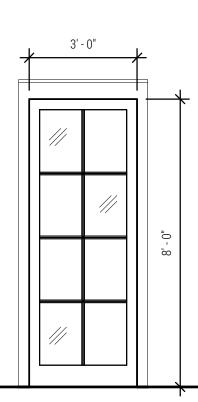


3080 EXTERIOR, FULL-LITE GLASS, FIXED DOOR WITH DIVIDED LITES; STYLE AND FINISH PER OWNER SELECTION

6' - 0"

01 6⁰8⁰ PAIR OF (3'-0" X 8'-0") EXTERIOR, FULL-LITE GLASS SWING DOORS WITH DIVIDED LITES; STYLE AND FINISH PER OWNER SELECTION


> DOOR TYPES SCALE: 3/8" = 1'-0"


WINDOW LEGEND						
SIZE (NOMINAL)	MANUF.	STYLE	MODEL	OPERATION		
3' - 0" X 4' - 6"	JELD-WEN	SITELINE: ALUMINUM CLAD, WOOD WINDOW W/DIVIDED LIGHTS	SCD3552	DOUBLE HUNG		
3' - 6" X 6' - 0"	JELD-WEN	SITELINE: ALUMINUM CLAD, WOOD WINDOW W/ DIVIDED LIGHTS	SCD4172	DOUBLE HUNG		
3' - 6" X 5' - 0"	JELD-WEN	SITELINE: ALUMINUM CLAD, WOOD WINDOW W/ DIVIDED LIGHTS	SCD4160	DOUBLE HUNG		
2' - 0" X 3' - 0"	JELD-WEN	SITELINE: ALUMINUM CLAD, WOOD WINDOW W/ DIVIDED LIGHTS	SCDP2536	FIXED		
3' - 0" X 4' - 6"	JELD-WEN	SITELINE: ALUMINUM CLAD, WOOD WINDOW W/ DIVIDED LIGHTS	SCDP3552	FIXED		
2' - 6" X 3' - 6"	JELD-WEN	SITELINE: ALUMINUM CLAD, WOOD WINDOW W/ DIVIDED LIGHTS	SCDP3152	FIXED		
2' - 6" X 3' - 0"	JELD-WEN	SITELINE: ALUMINUM CLAD, WOOD WINDOW W/ DIVIDED LIGHTS	SCDP3136	FIXED		

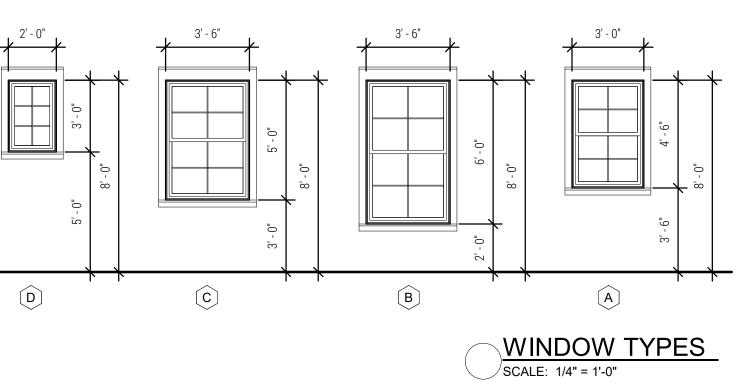

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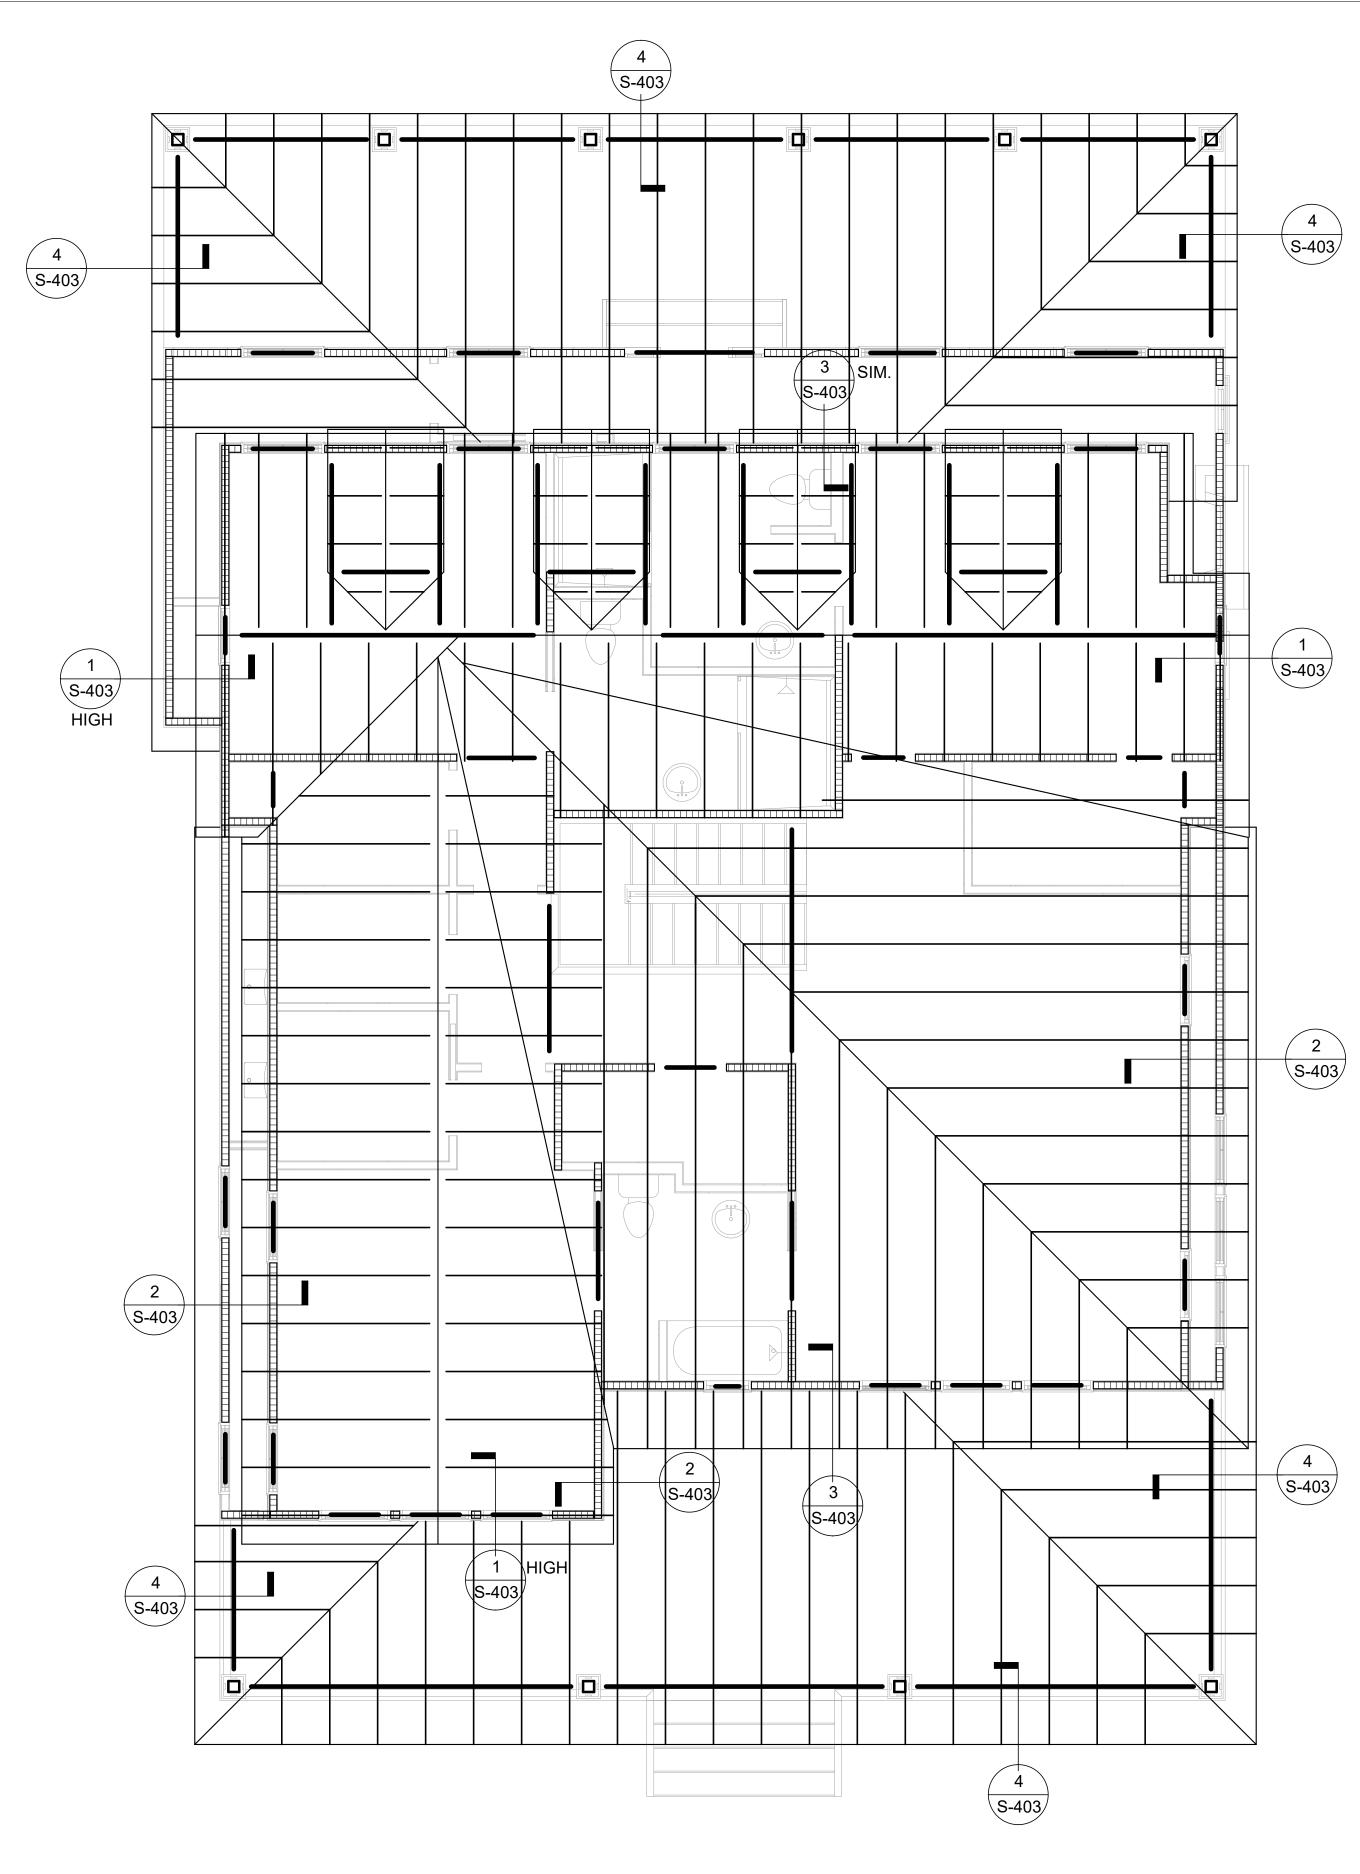


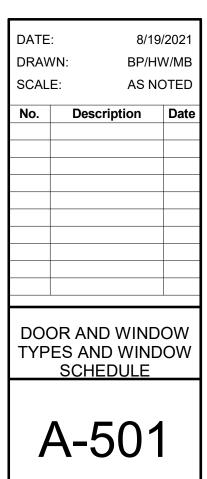

ROOF FRAMING PLAN - GARAGE SCALE: 1/4" = 1'-0"

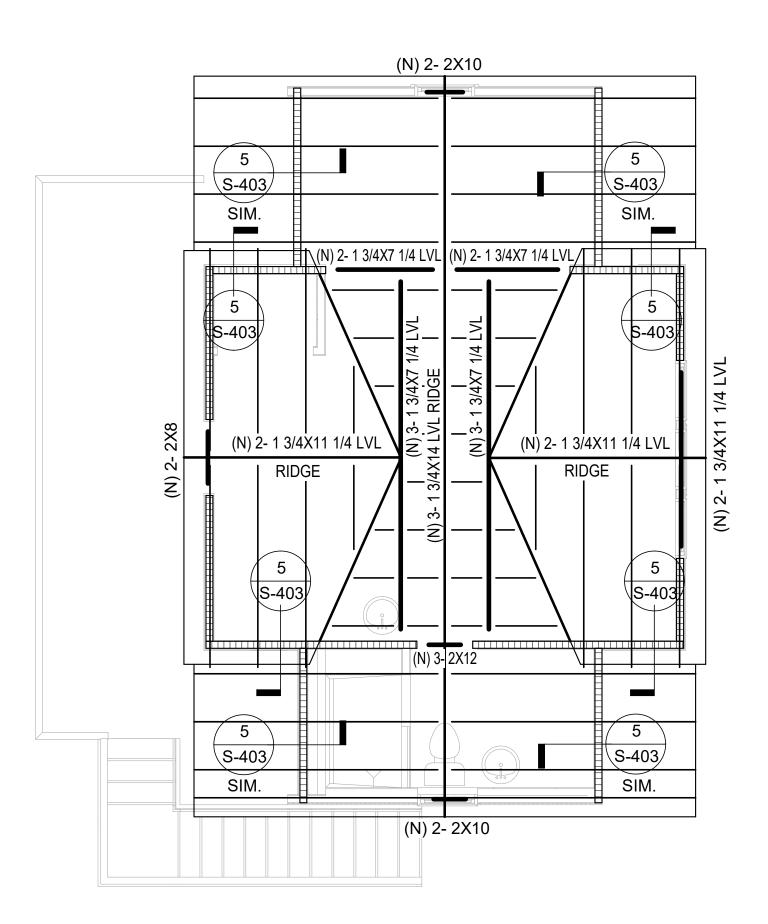PLAN NOTES:

- SEE ARCHITECTURAL DRAWINGS FOR EXACT LOCATIONS OF ROOF SLOPES, HIPS, VALLEYS, AND RIDGES NOT SPECIFICALLY DIMENSIONED.
- 2. VERIFY AND COORDINATE ALL DIMENSIONS W/ ARCHITECTURAL DRAWINGS.
- 3. SEE STRUCTURAL NOTES FOR WALL FRAMING SIZES, SPACING, AND SPECIES.
- ALL STICK FRAMING FOR CANOPIES, PORCHES, AND OVERHANGS ARE 2x6 @ 24"O.C., UNLESS NOTED OTHERWISE.
- ALL OVERBUILD FRAMING MEMBERS ARE 2x6 @ 24"O.C., UNLESS NOTED OTHERWISE.
- 6. ROOF DIAPHRAM SHALL BE INSTALLED AS DIAPHRAM AS DEFINED BY BUILDING CODE.



2 ROOF FRAMING PLAN - HOUSE SCALE: 1/4" = 1'-0" PLAN NOTES:

- 1. SEE ARCHITECTURAL DRAWINGS FOR EXACT LOCATIONS OF ROOF SLOPES, HIPS, VALLEYS, AND RIDGES NOT SPECIFICALLY DIMENSIONED.
- 2. VERIFY AND COORDINATE ALL DIMENSIONS W/ ARCHITECTURAL DRAWINGS.
- 3. SEE STRUCTURAL NOTES FOR WALL FRAMING SIZES, SPACING, AND SPECIES.
- ALL STICK FRAMING FOR CANOPIES, PORCHES, AND OVERHANGS ARE 2x6 @ 24"O.C., UNLESS NOTED OTHERWISE.
- ALL OVERBUILD FRAMING MEMBERS ARE 2x6 @ 24"O.C., UNLESS NOTED OTHERWISE.
- 6. ROOF DIAPHRAM SHALL BE INSTALLED AS DIAPHRAM AS DEFINED BY BUILDING CODE.



TPBE Firm F-12778 210 Barton Springs Rd. Ste. 250 Austin, TX 78704 (512) 474 4001 Project # **9210007**



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