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Project

Elisabet Ney Museum
Building, ADA Accessibility and
Landscape Improvements

CIP 7551.002

304 East 44th Street
Austin, Texas

Client



Managing Department:
Public Works Department
Project Management Division

505 Barton Springs Road, Suite 900
Austin, Texas
Ph: (512) 974-7830 / Fax: (512) 974-7203

Robin A. Camp - Project Manager

Mark	Date	Description

Project No. 2008.2954.0

Date April 14, 2009

Drawn DMC

Checked CJL


Scale As Noted

Exterior Elevations:
Flashing Schematics


Sheet Title

W3.0

Sheet No.

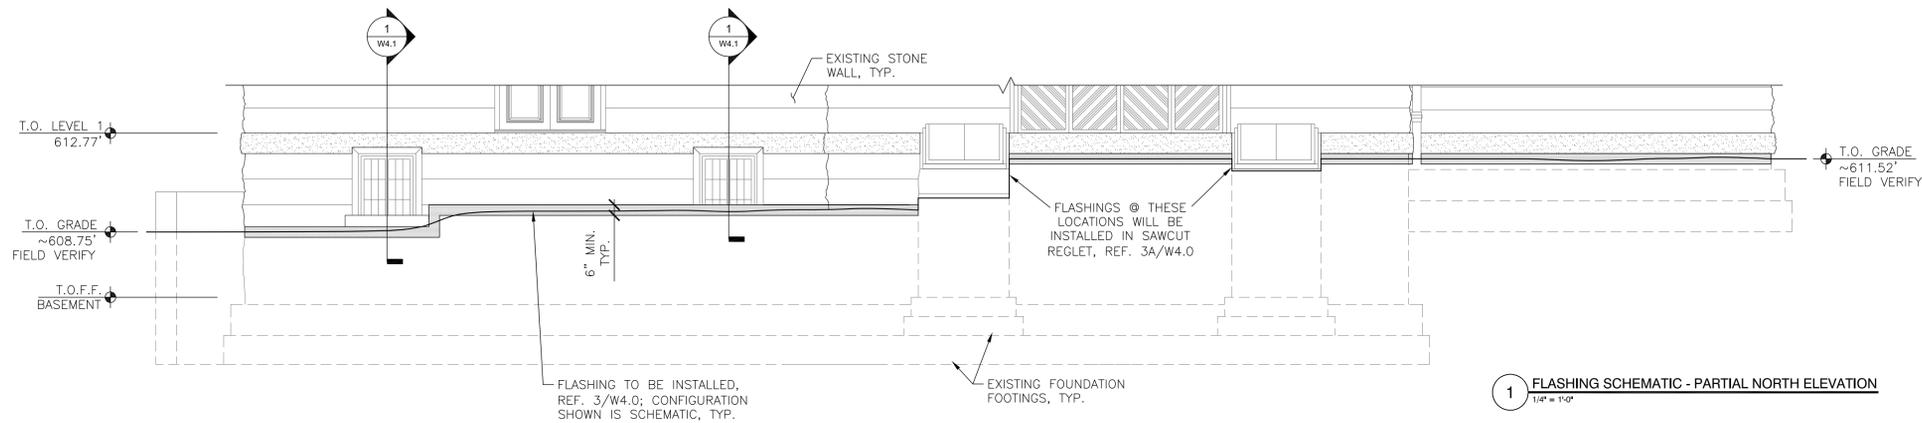


1 FLASHING SCHEMATIC - PARTIAL NORTH ELEVATION
1/4" = 1'-0"

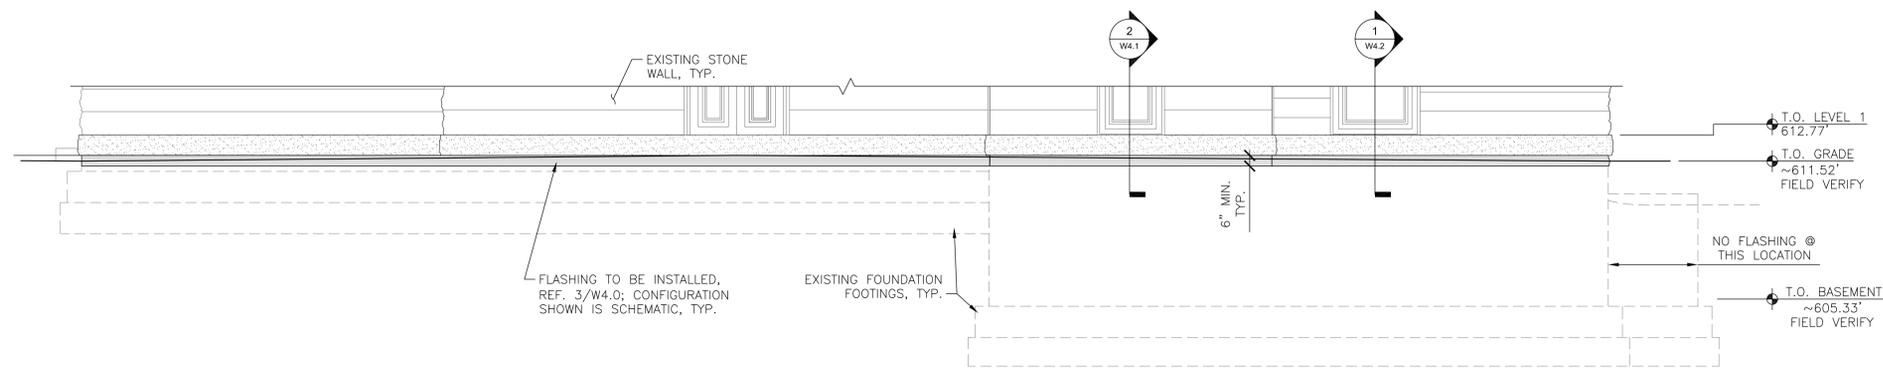


2 FLASHING SCHEMATIC - PARTIAL SOUTH ELEVATION
1/4" = 1'-0"

SHEET NOTES


- FLASHING ELEVATIONS SHOWN ARE SCHEMATIC FOR ILLUSTRATION.
- TOP OF METAL FLASHING SHALL BE INSTALLED AT BED JOINT NEAR FINISH GRADE ELEVATION.
- REF. LANDSCAPE ARCHITECT'S PLANS FOR FINAL GRADE ELEVATIONS ADJACENT TO THE STRUCTURE.
- FLASHING LOCATION SHALL BE APPROVED BY OWNER & PROJECT ARCHITECT PRIOR TO INSTALLATION.
- CONTRACTOR SHALL PROVIDE 5'-0" FLASHING INSTALLATION MOCK-UP PRIOR TO THE START OF THE WORK. MOCK-UP SHALL INCORPORATE A CORNER AND AN EXPANSION JOINT CONDITION. CONTRACTOR MAY SELECT THE LOCATION OF THE MOCK-UP. MOCK-UP LOCATIONS MAY BE INCORPORATED INTO THE WORK UPON ACCEPTANCE.

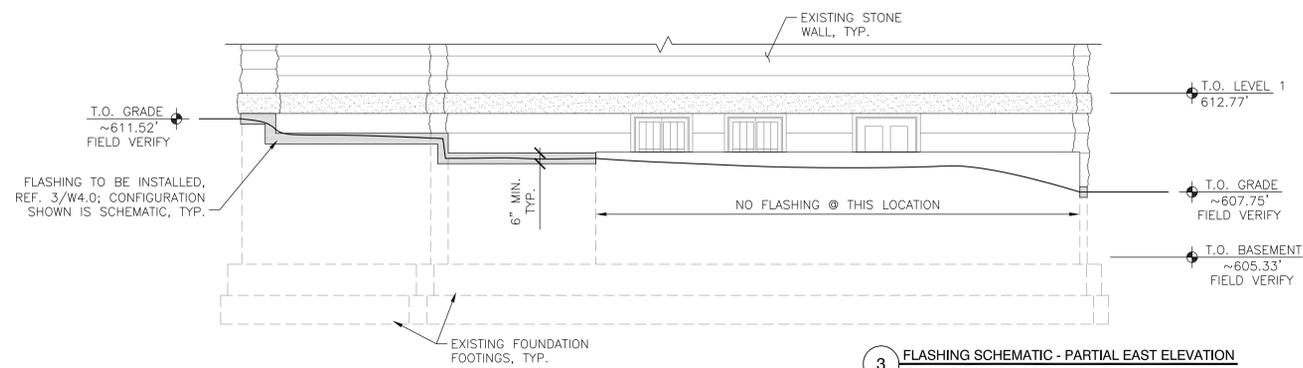

3 FLASHING SCHEMATIC - PARTIAL EAST ELEVATION
1/4" = 1'-0"

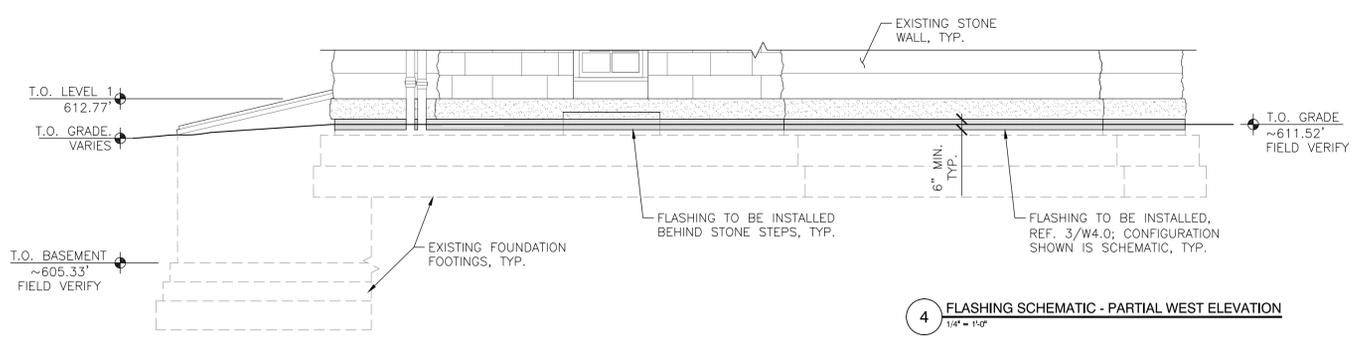

4 FLASHING SCHEMATIC - PARTIAL WEST ELEVATION
1/4" = 1'-0"

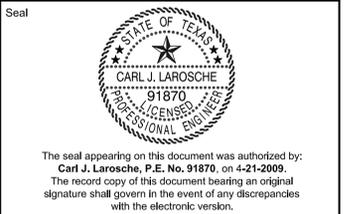


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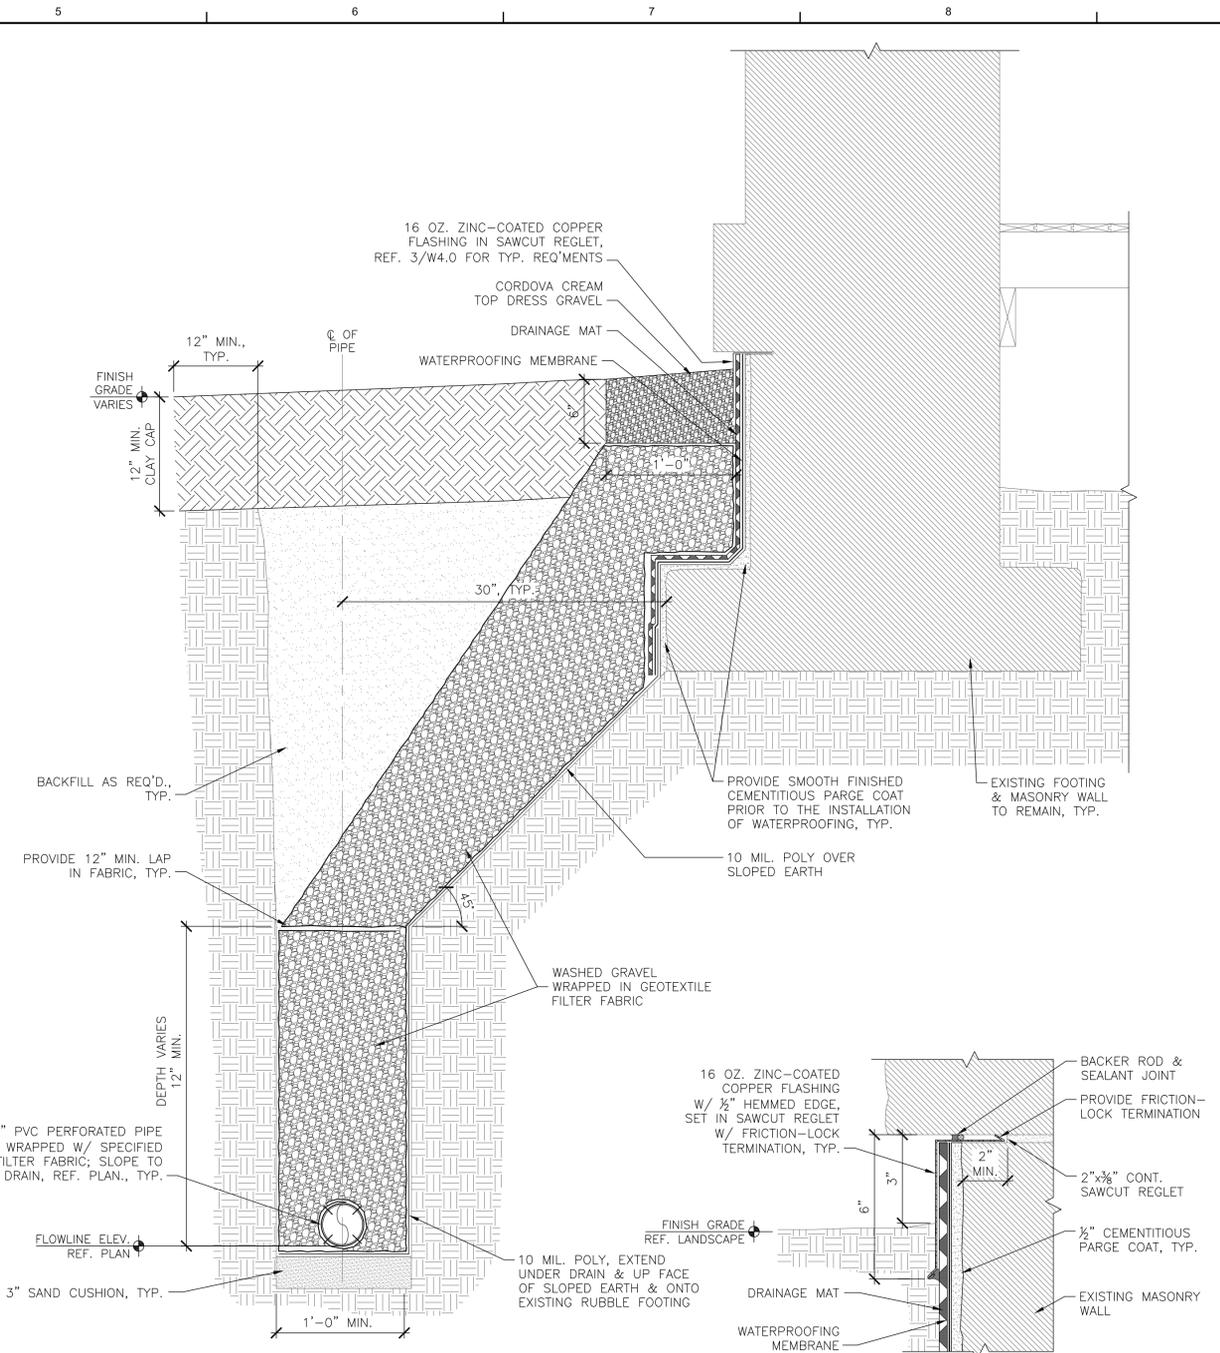


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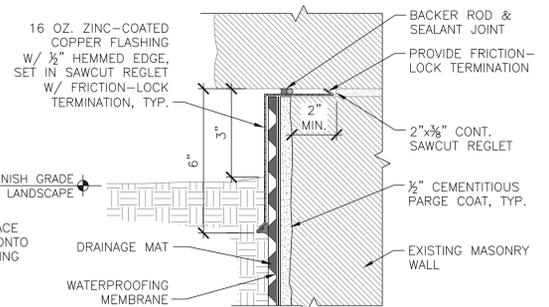
Waterproofing Sections & Details




1 DRAIN INSTALLATION AT FOUNDATION WALL, TYP.
 1/12" = 1'-0"

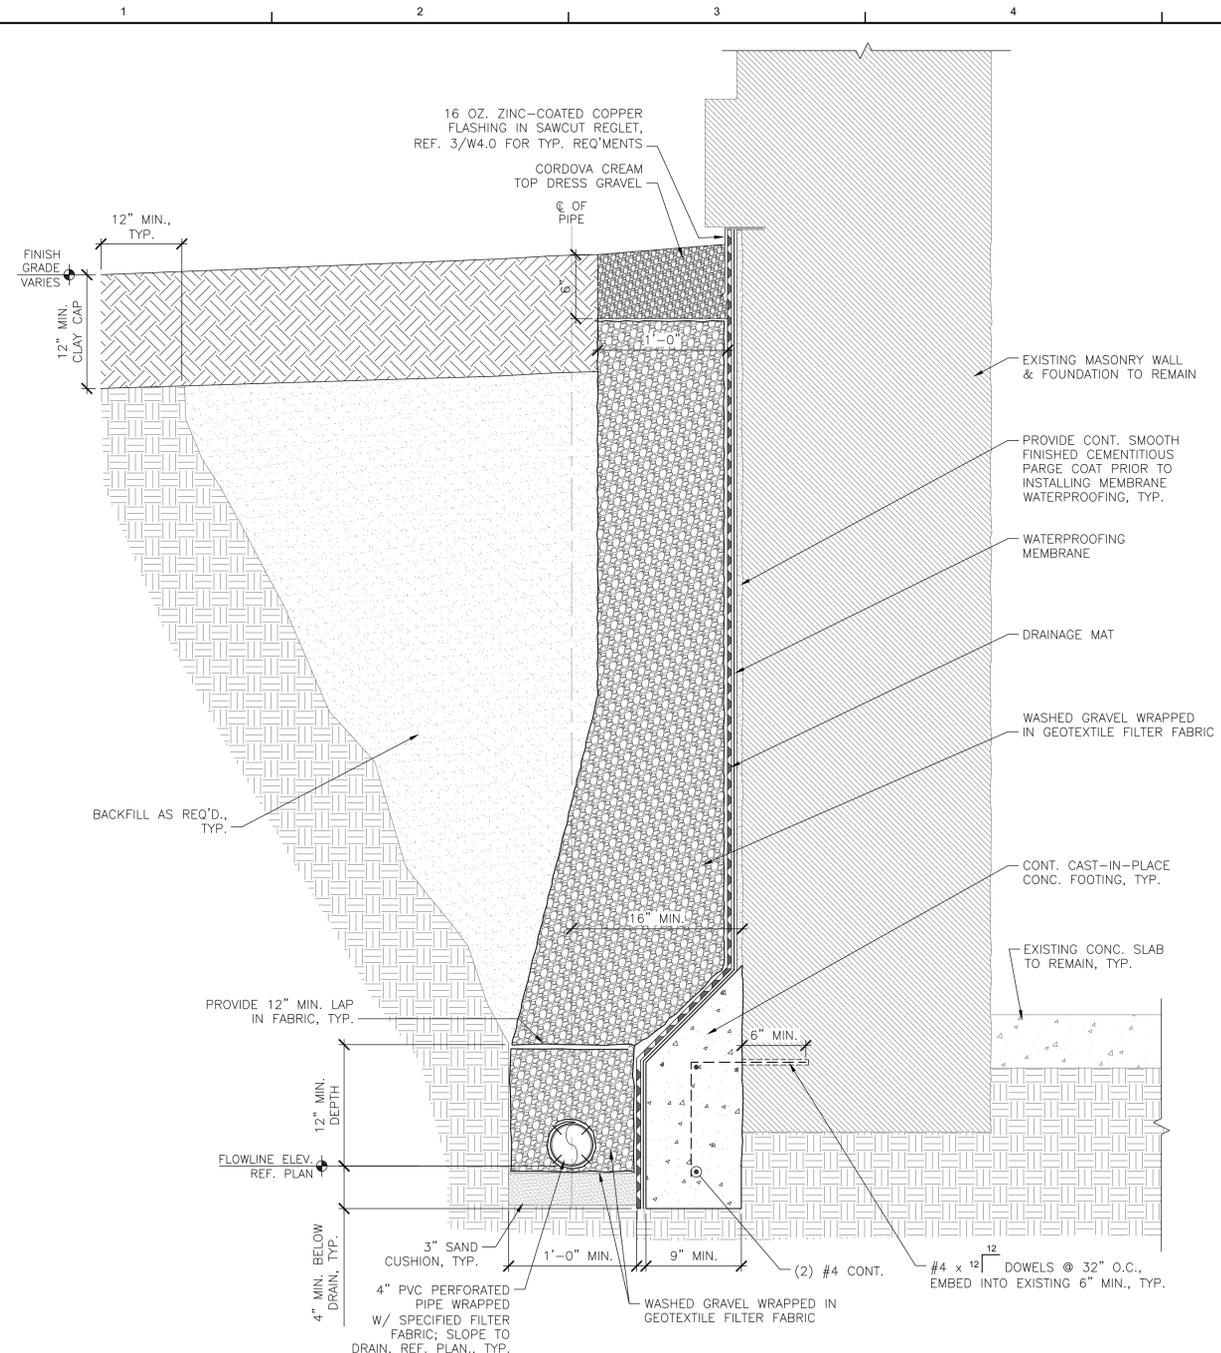


2 DRAIN INSTALLATION AT FOUNDATION WALL WITH FOOTING, TYP.
 1/12" = 1'-0"




3 FLASHING INSTALLATION AT HEAD JOINT, TYP.
 3/8" = 1'-0"

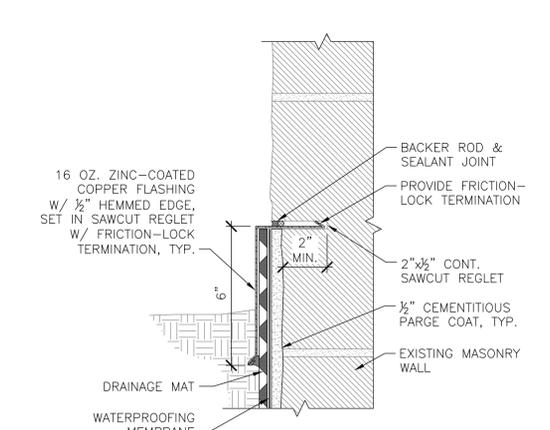


3A FLASHING INSTALLATION NON-HEAD JOINT, TYP.
 3/8" = 1'-0"

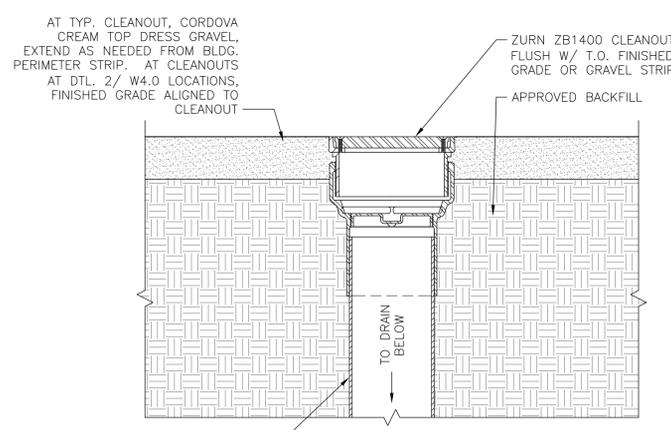

4 CLEANOUT SECTION, TYP.
 3/8" = 1'-0"

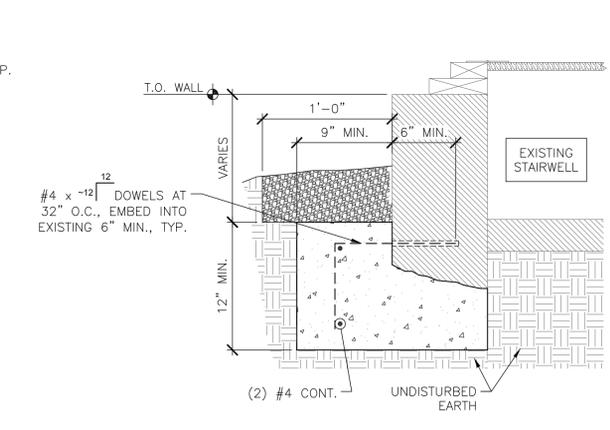


5 CONCRETE UNDERPINNING BEAM
 1/12" = 1'-0"

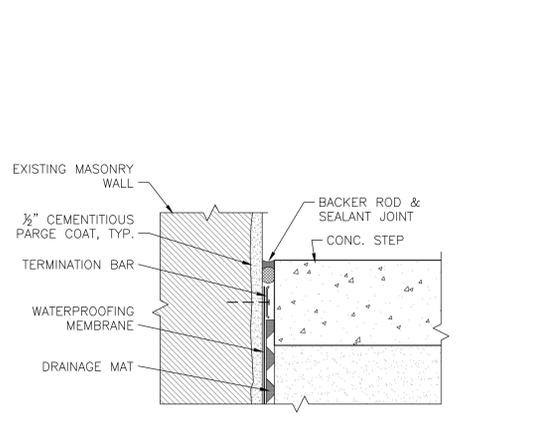

6 WATERPROOFING TERMINATION DETAIL
 3/8" = 1'-0"


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Project
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Building, ADA Accessibility and
Landscape Improvements

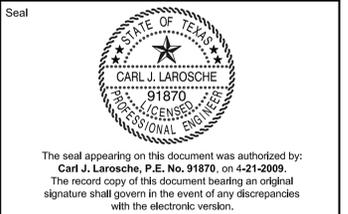CIP 7551.002


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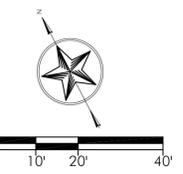
PLANTING NOTES:

1. STAKE PLANT LOCATIONS ON SITE AND REVIEW WITH LANDSCAPE ARCHITECT. MAKE ADJUSTMENT AS REQUESTED.
2. ASHE JUNIPERS TO BE PLANTED IN THEIR HISTORIC LOCATIONS. MEASURE STUMP LOCATION FROM FIXED POINTS AND PROVIDE DIMENSIONED PLAN FOR RECORD PRIOR TO THEIR REMOVAL.
3. REMOVE ASHE JUNIPER STUMPS IN THEIR ENTIRETY. REPLANT JUNIPERS IN THE HISTORIC LOCATIONS.
4. SEE DRAWING L3.2 FOR SEEDING OF NATIVE TEXAS GRASS AREAS.
5. GRUB TO REMOVE SOD AND MISCELLANEOUS VEGETATION IN AREAS TO BE PLANTED INCLUDING VEGETABLE GARDEN.
6. REMOVE TURF AND INSTALL MULCH AT THE BASE OF INDIVIDUAL EXISTING TREES.

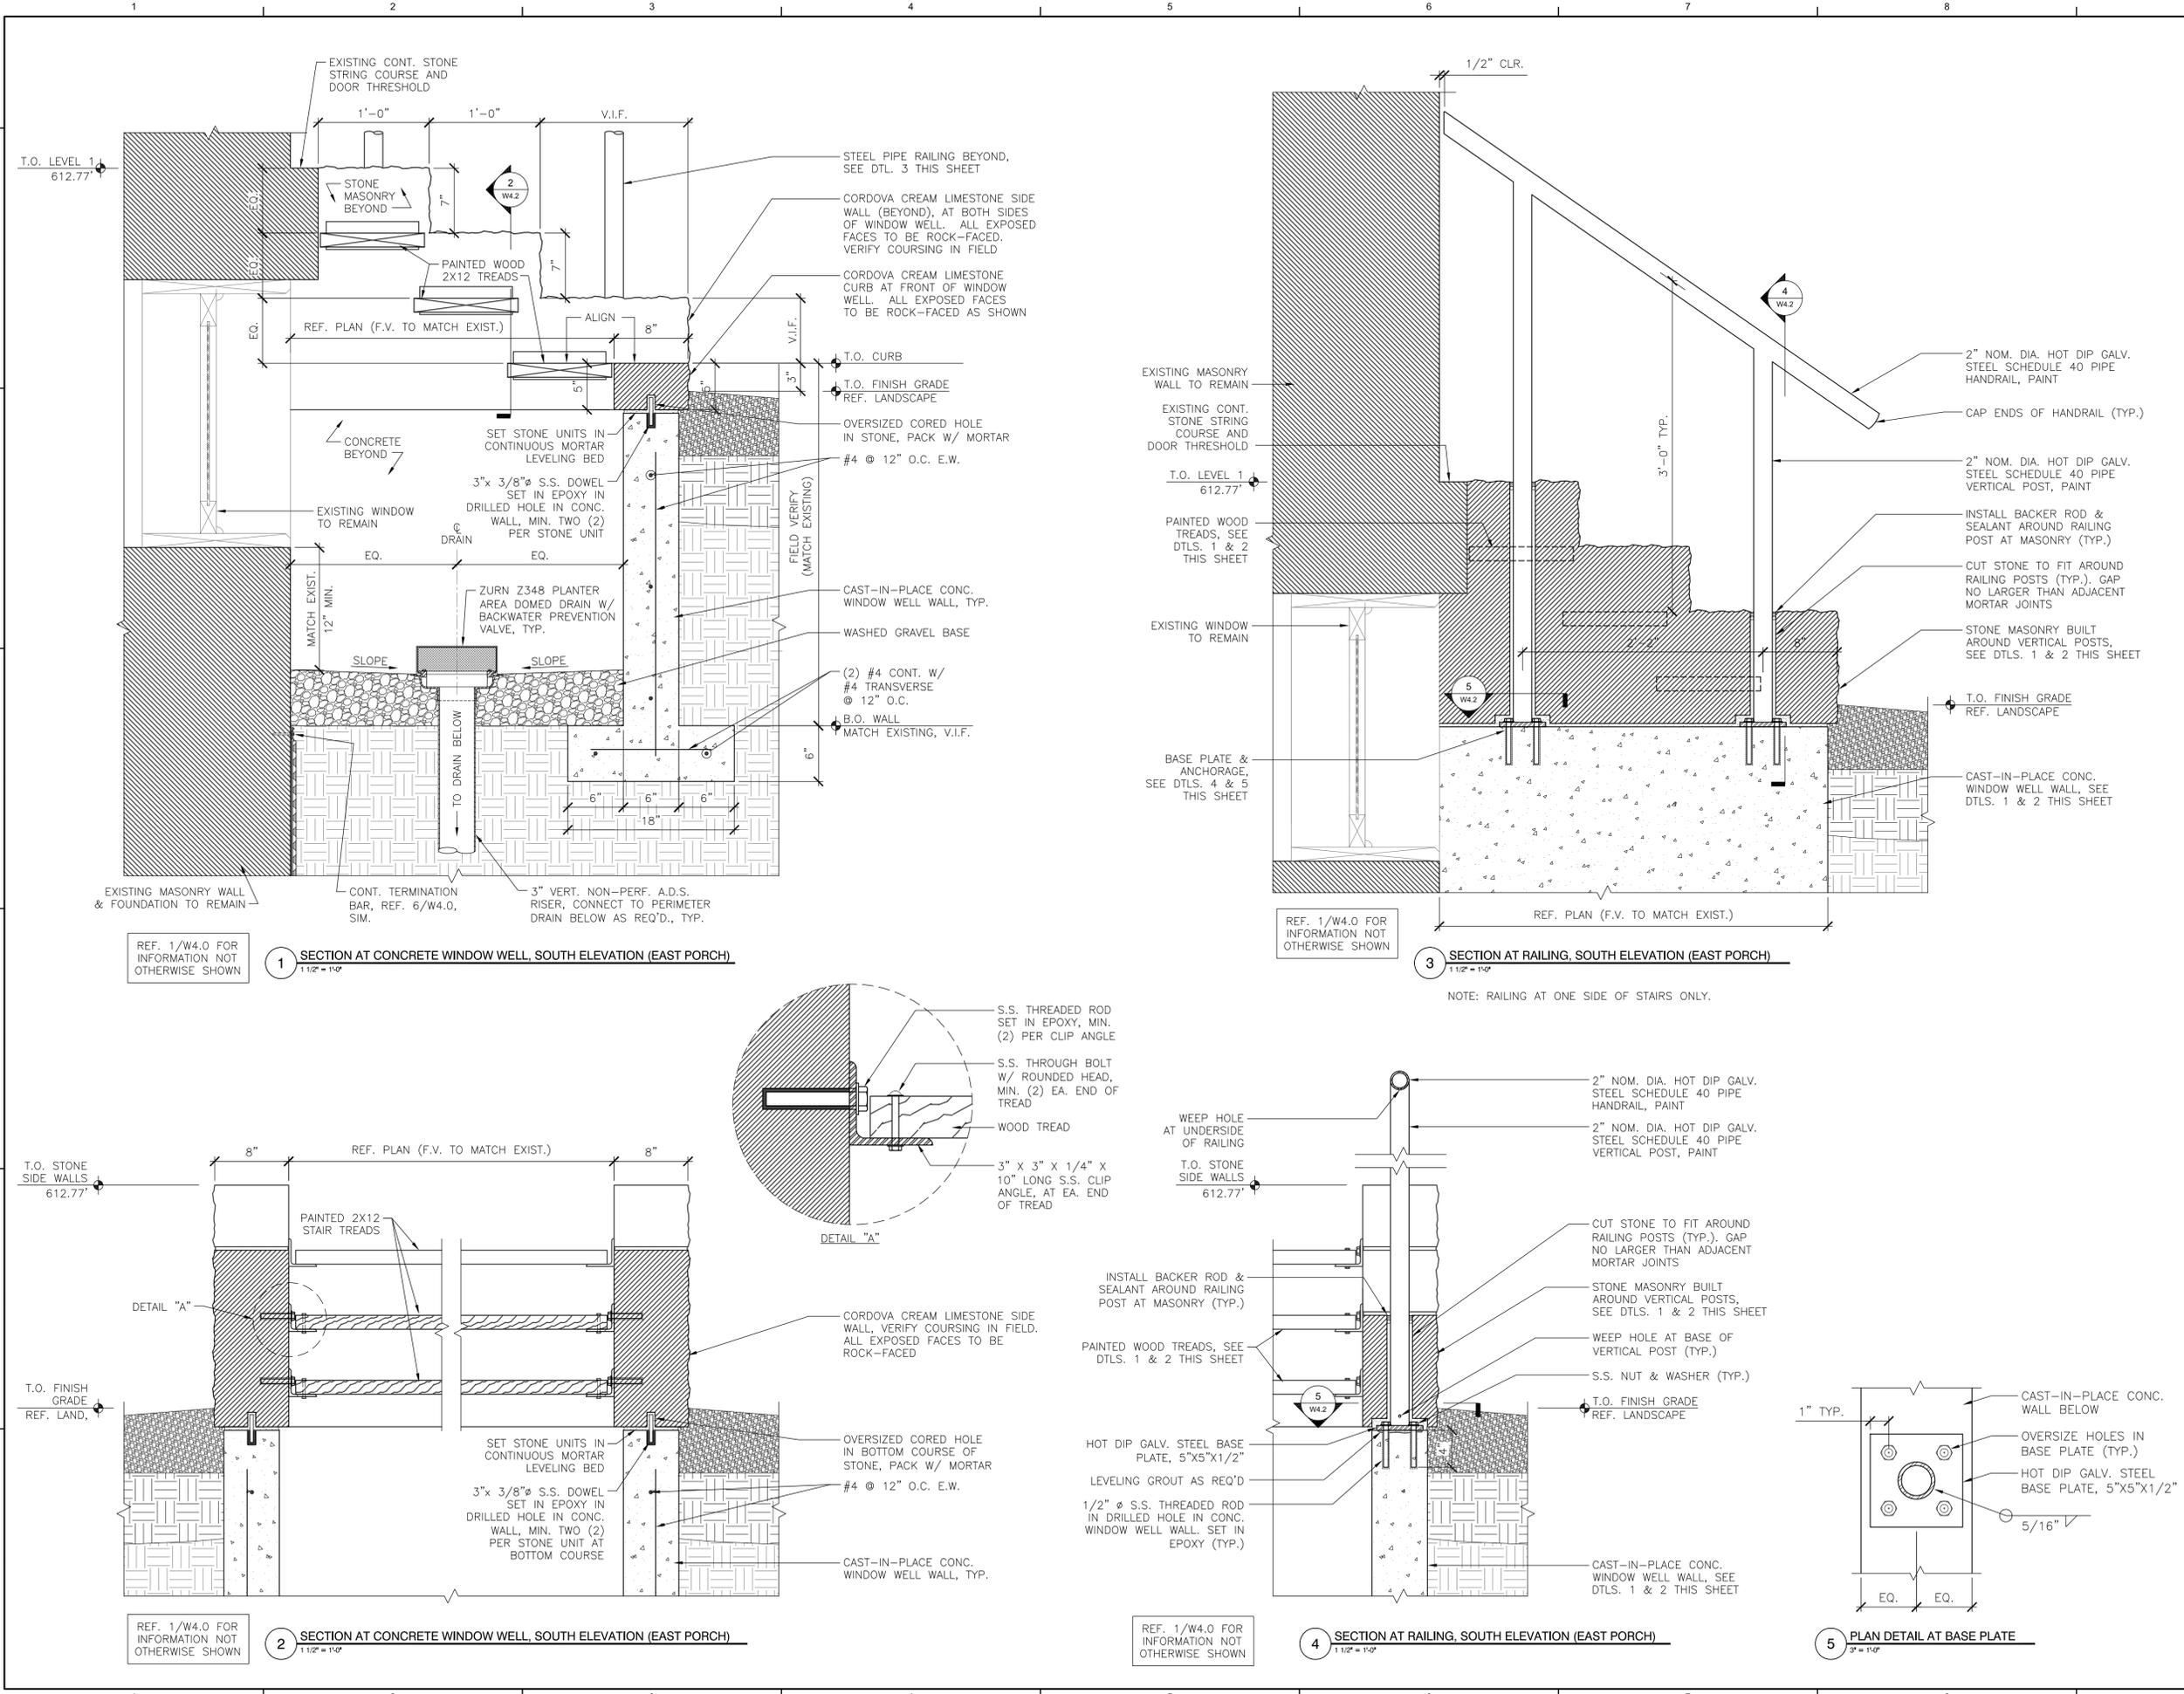

Plant List

CODE	SCIENTIFIC NAME	COMMON NAME	QTY	SIZE	COMMENTS
Deciduous Tree					
Qs	<i>Quercus stellata</i>	Post Oak	5	2 to 2-1/2" cal.	B&B SPECIMEN
Ci	<i>Carya illinoensis</i>	Pecan	1	2 to 2-1/2" cal.	B&B SPECIMEN
Cc	<i>Cercis canadensis</i>	Eastern redbud	3	1 to 1-1/2" cal.	B&B SPECIMEN/FULL HEAD
Evergreen Tree					
Ja	<i>Juniperus ashei</i>	Ashe Juniper	13	3' to 3 1/2' Ht.	cont.
Shrub Planting					
Aa	<i>Agave americana</i>	Agave	4	2 gal. cont.	Standard Green Leaved, Specimens Only, Not Variegated
Ms	<i>Musa sapienta</i>	Banana	4	3 gal. cont.	Standard Green Leaved, Specimens Only, Not Variegated
Yf	<i>Yucca filamentosa</i>	Yucca	6	1 gal. cont.	Standard Green Leaved, Specimens Only, Not Variegated

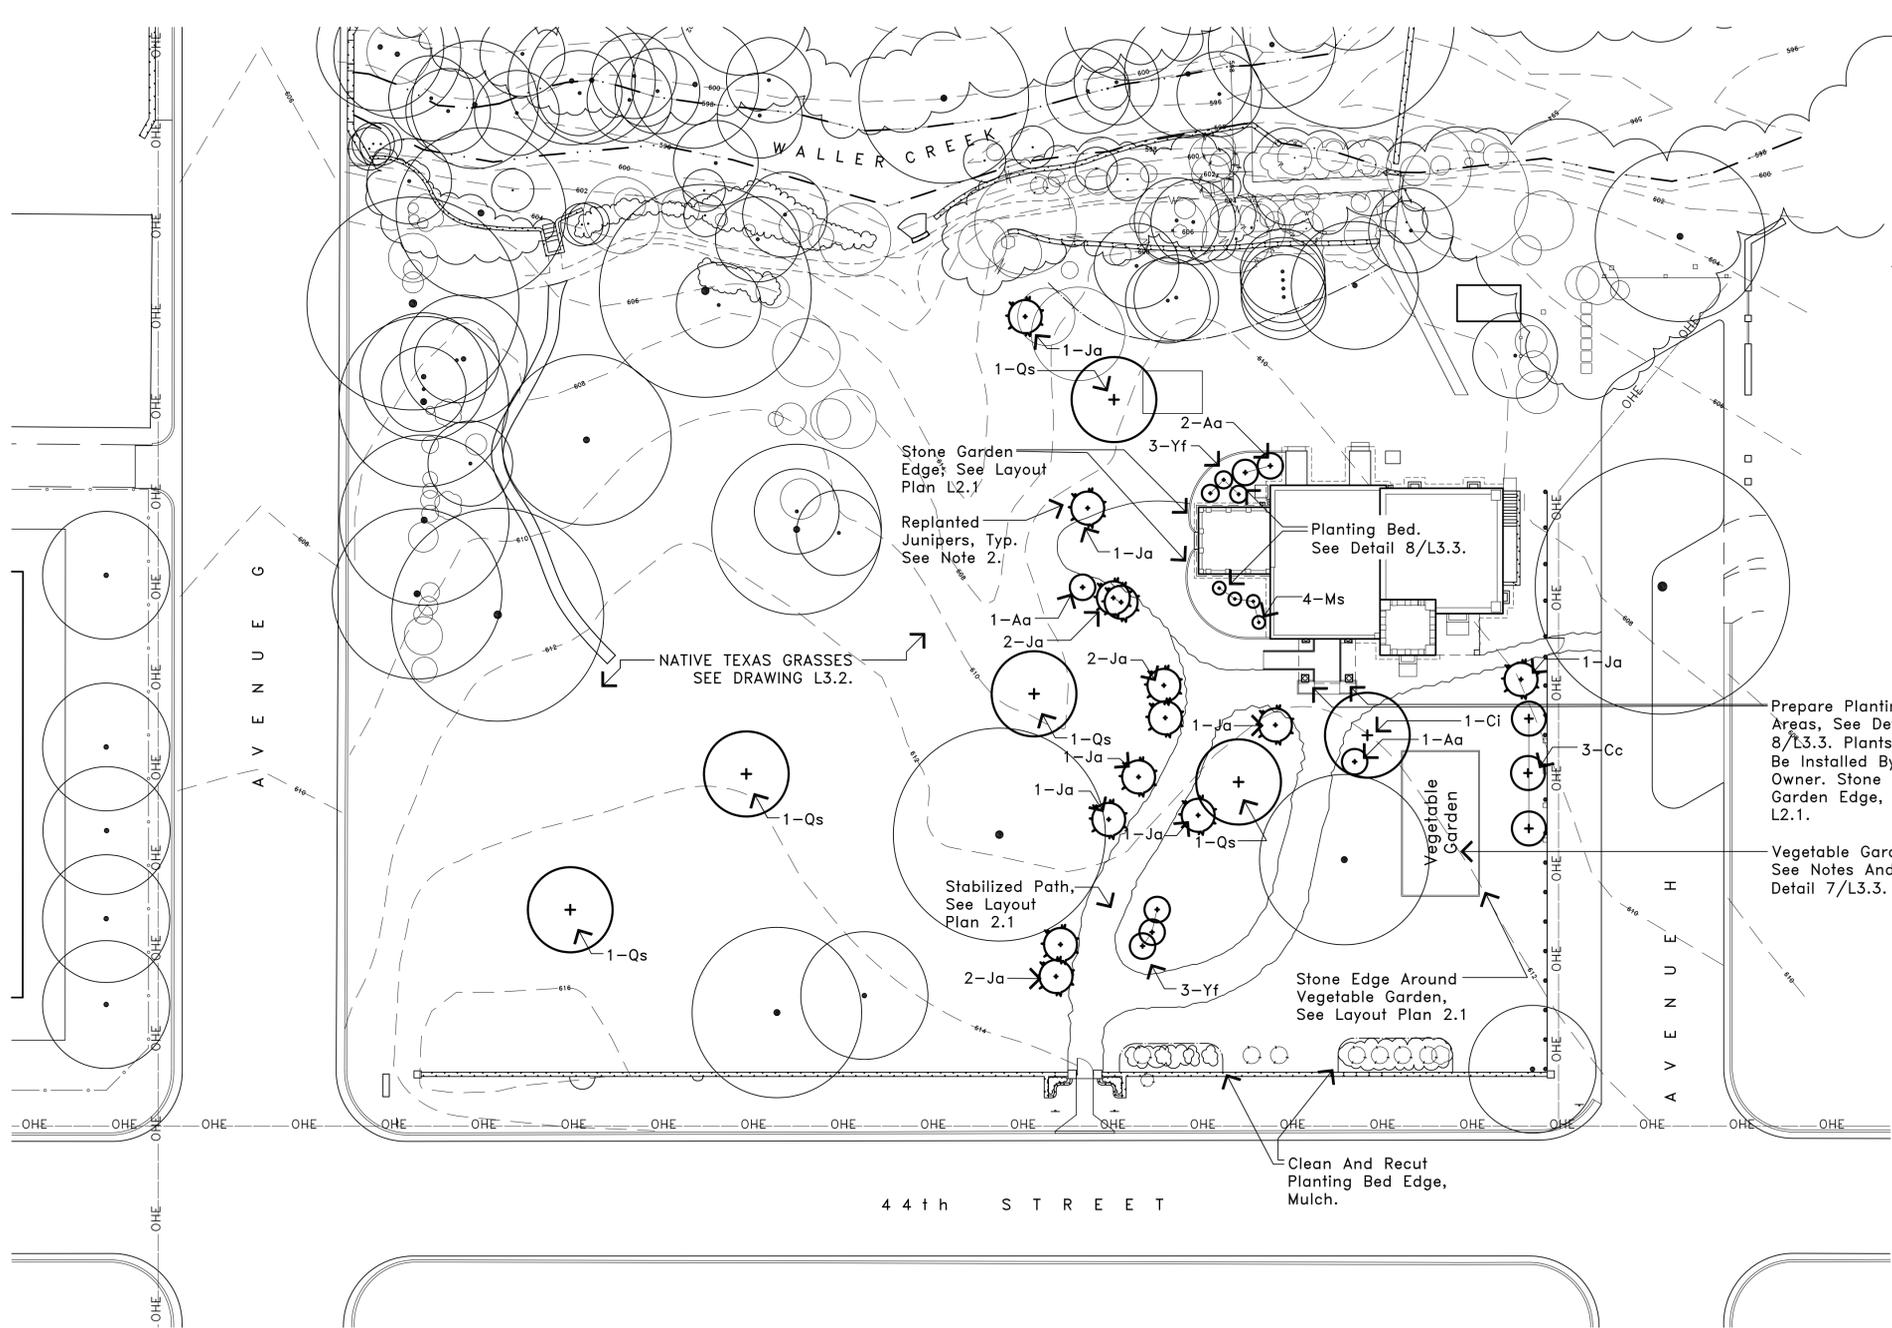


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Mark	Date	Description
Project No.	2008.2954.0	
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Planting Plan		
Sheet Title	L3.1	
Sheet No.		



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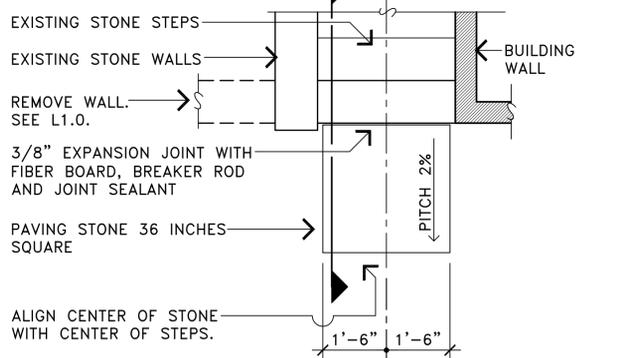


12 SECTION: LANDING
 L4.1 SCALE - 1"=1'-0"

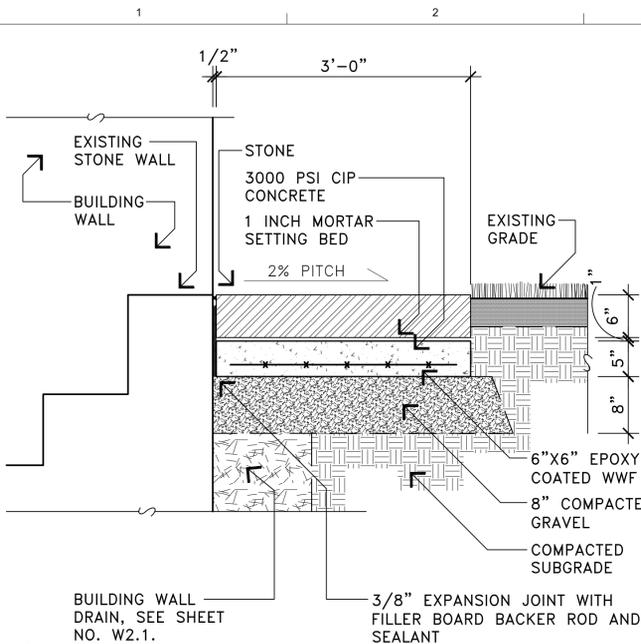
SCHEDULE FOR STONE PAVING AT AREA WELLS

LOCATION A. 3'-0" X 4'-2 1/4" BY 6" THICK
 LOCATION B. 3'-0" X 5'-2 3/4" BY 6" THICK


- NOTES:
- FIELD VERIFY WIDTH OF STONE TO MATCH WIDTH OF AREA WELL MASONRY.
 - SET STONE ATOP CONCRETE SLAB. SEE DETAIL 12/L4.1 S.I.M.




11 PLAN - STONE LANDING
 L4.1 SCALE - 4.1"=1'-0"

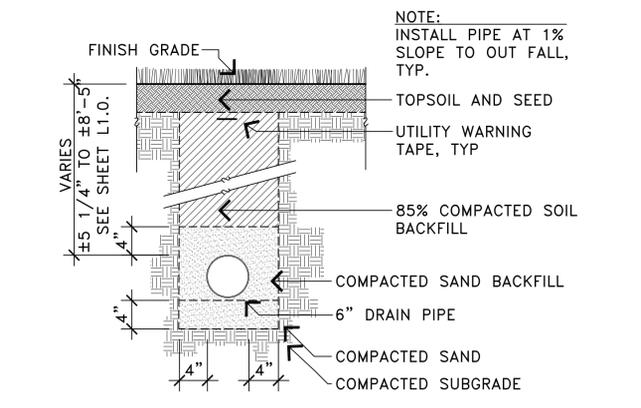


10 SECTION - 6" DIA DRAINAGE PIPE TRENCH
 L4.1 SCALE - 1"=1'-0"

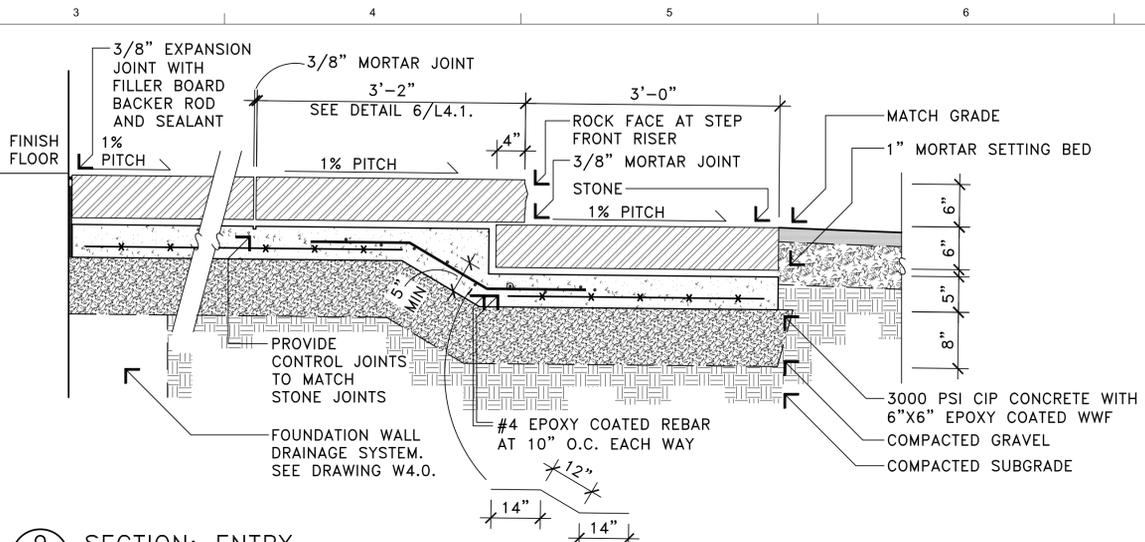


9 SECTION: ENTRY
 L4.1 SCALE - 1"=1'-0"

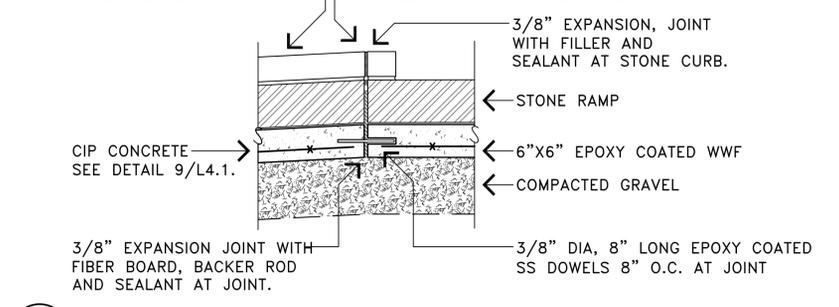


8 SECTION: EXPANSION JOINT
 L4.1 SCALE - 1"=1'-0"

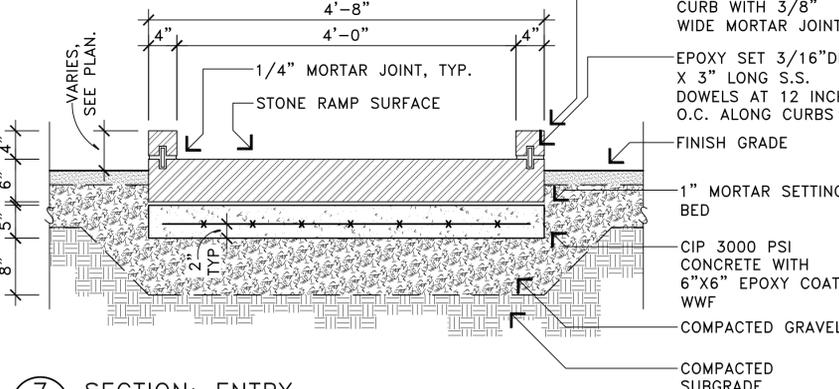


7 SECTION: ENTRY
 L4.1 SCALE - 1"=1'-0"

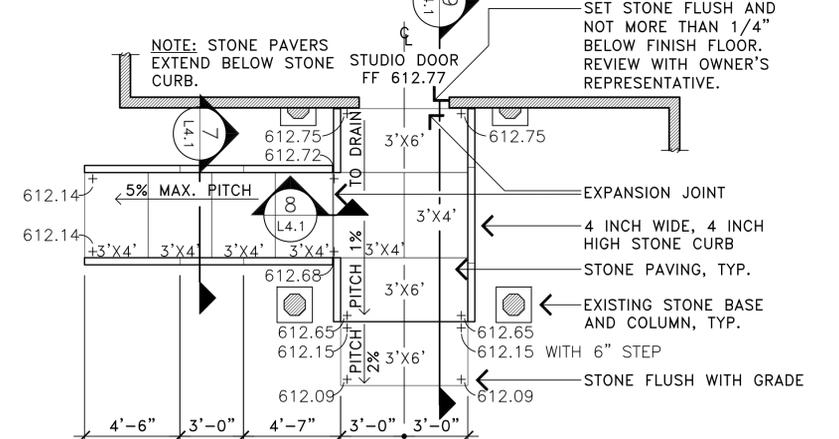

6 PLAN: ENTRY
 L4.1 SCALE - 1/4"=1'-0"

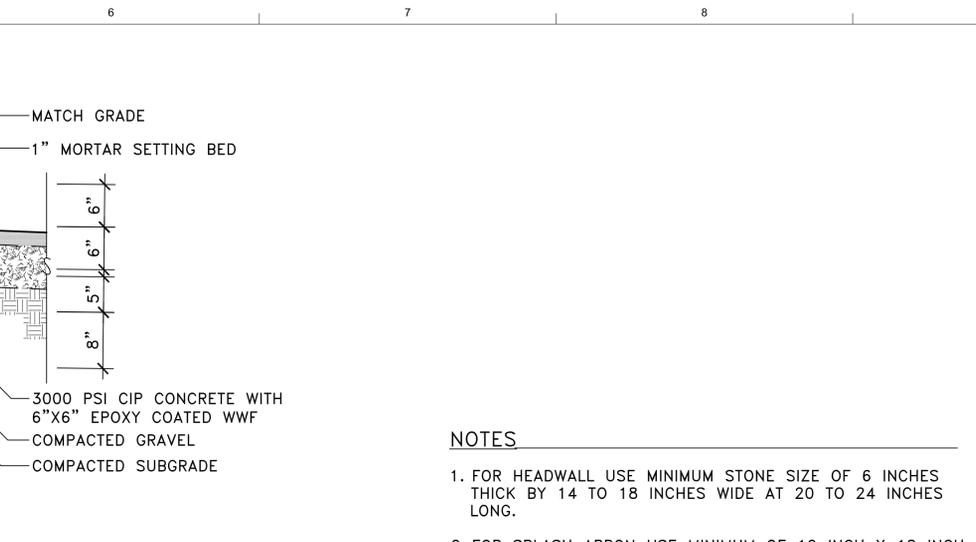


2 SECTION - STONE HEADWALL & SPLASH APRON
 L4.1 SCALE - 1"=1'-0"

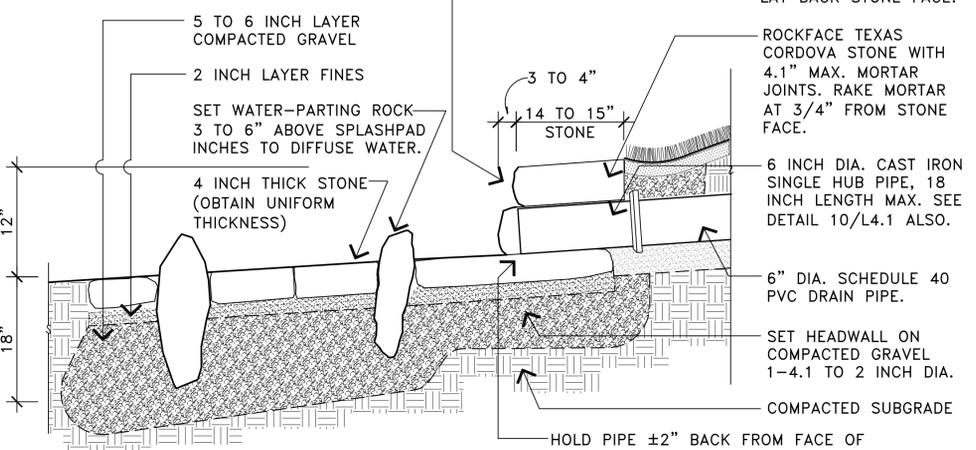

1 PLAN - STONE HEADWALL & SPLASH APRON
 L4.1 SCALE - 1"=1'-0"


- NOTES**
- FOR HEADWALL USE MINIMUM STONE SIZE OF 6 INCHES THICK BY 14 TO 18 INCHES WIDE AT 20 TO 24 INCHES LONG.
 - FOR SPLASH APRON USE MINIMUM OF 12 INCH X 18 INCH RELATIVELY FLAT STONE.

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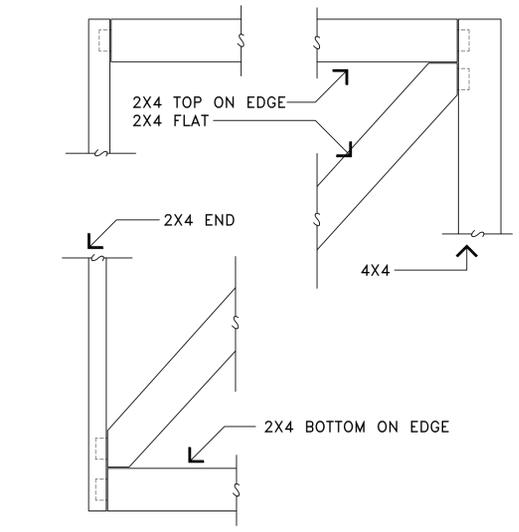


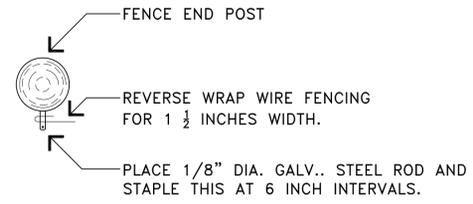14 END POST PLAN
L4.2 SCALE - 1 1/2"=1'-0"


- NOTE**
- FASTEN WOOD WITH ADHESIVE AND GALV.. SCREWS AT ALL CONNECTIONS AND JOINTS.
 - ALL THROUGH CONNECTIONS TO BE MADE WITH 3/8 INCH DIA. GALV. HEXAGONAL HEAD BOLT ASSEMBLY WITH WASHER AND NUT. COUNTERSINK AT FRONT AND BACK.
 - USE HEAVY DUTY J-BOLT PIVOT HINGE GALV.. WITH BLACK FINISH.
 - INSTALL GATE BOLT SLIDE STYLE LATCH, STAINLESS STEEL FINISH.

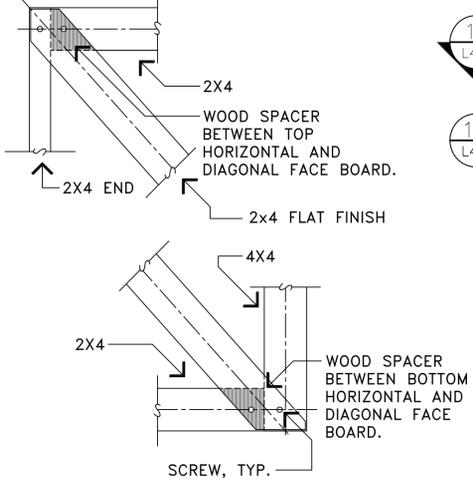


13 GATE JOINTS FRONT ELEVATION
L4.2 SCALE - 1 1/2"=1'-0"



12 GATE JOINTS REAR ELEVATION
L4.2 SCALE - 1 1/2"=1'-0"

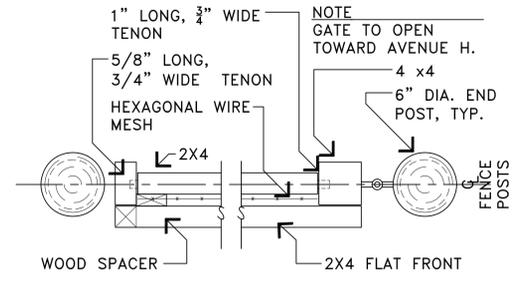


11 GATE SECTION
L4.2 SCALE - 1 1/2"=1'-0"

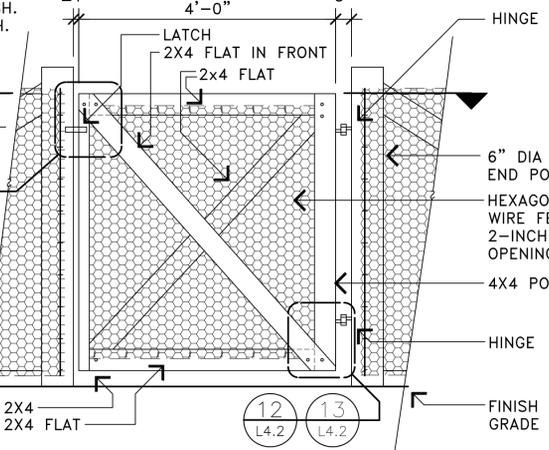


10 GATE ELEVATION
L4.2 SCALE - 3/4"=1'-0"


- NOTES:**
- DISTANCE BETWEEN FENCE POSTS TO BE BASED ON EXISTING HISTORIC FENCE POSTS REMAINING ON SITE. PROTECT & RETAIN HISTORIC FENCE POSTS IN PLACE.
 - INSTALL FENCE ALONG ORIGINAL FENCE LOCATION AS INDICATED BY THE REMAINING FENCE POSTS. DO NOT REMOVE FENCE POSTS. RUN NEW WIRE FABRIC ACROSS FACE OF HISTORIC POSTS. DO NOT ATTACH WIRE FENCE TO HISTORIC FENCE POSTS.

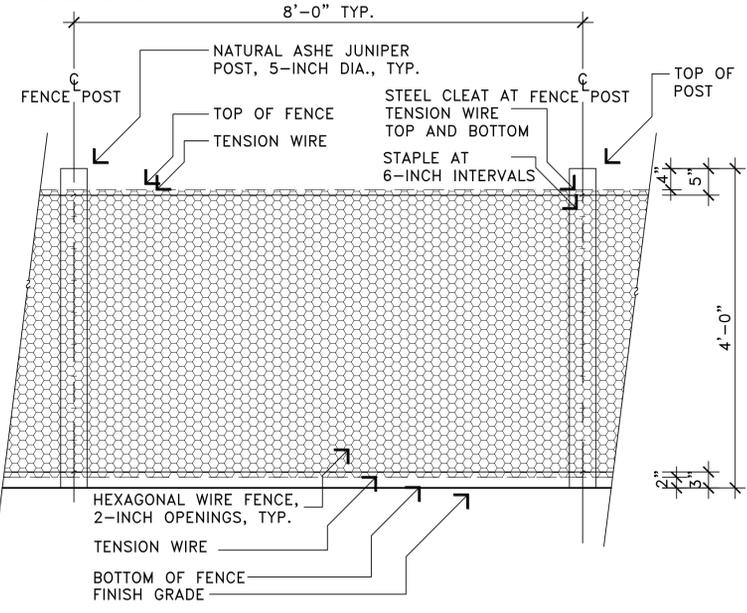


9 FENCE ELEVATION
L4.2 SCALE - 3/4"=1'-0"

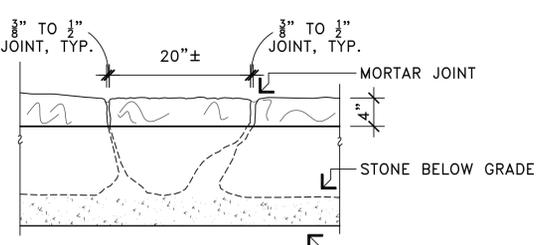


8 GARDEN EDGE CURB ELEVATION
L4.2 SCALE - 1"=1'-0"

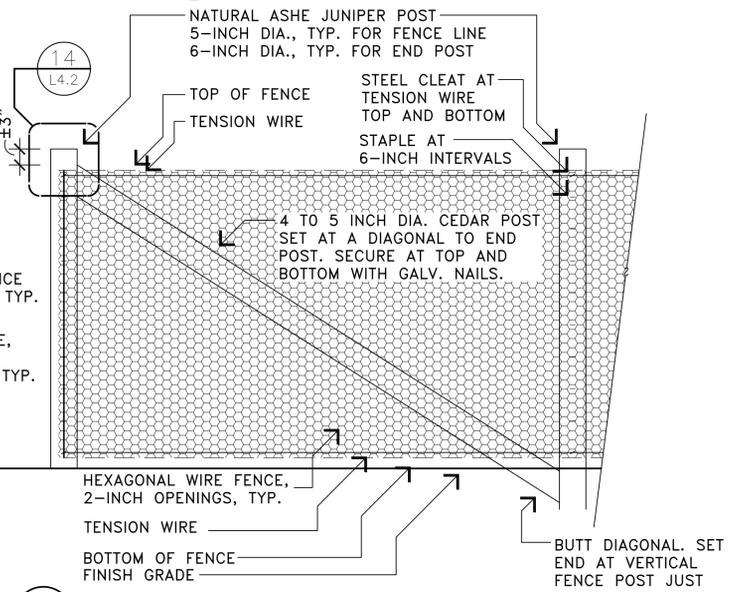


7 FENCE END POST ELEVATION TYP.
L4.2 SCALE - 3/4"=1'-0"

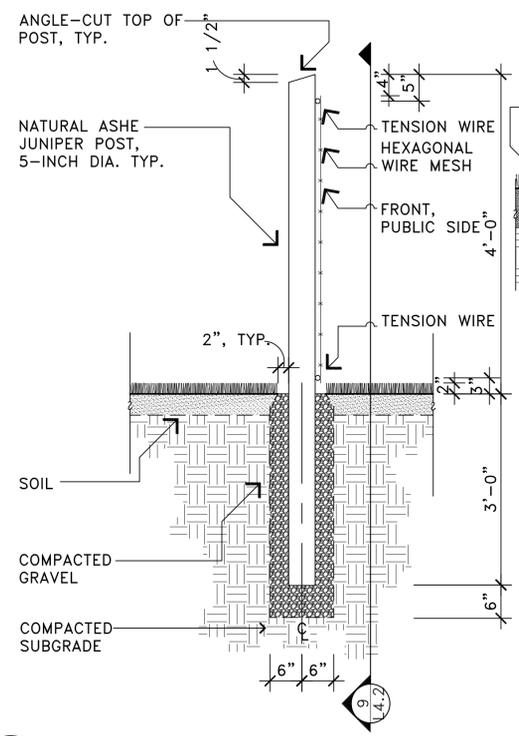


5 FENCE POST SECTION
L4.2 SCALE - 3/4"=1'-0"

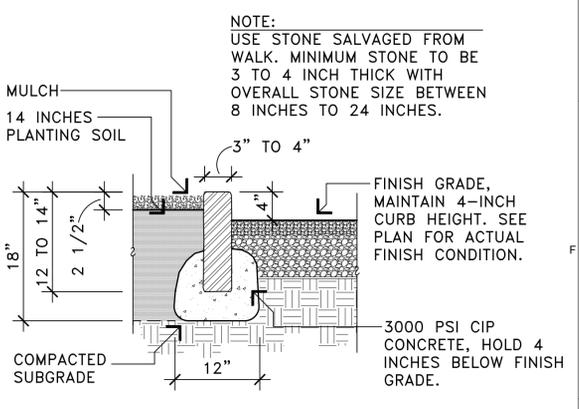


4 GARDEN EDGE CURB SECTION
L4.2 SCALE - 1"=1'-0"

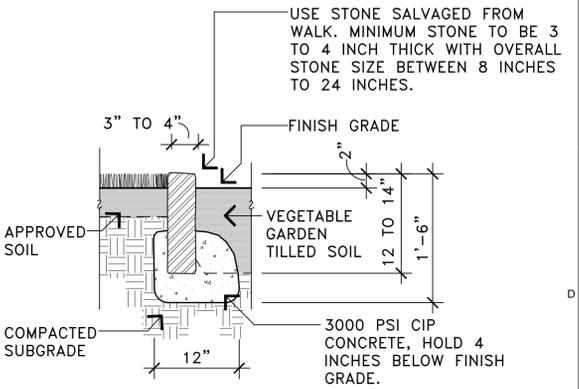

3 VEGETABLE GARDEN STONE EDGE SECTION
L4.2 SCALE - 1"=1'-0"

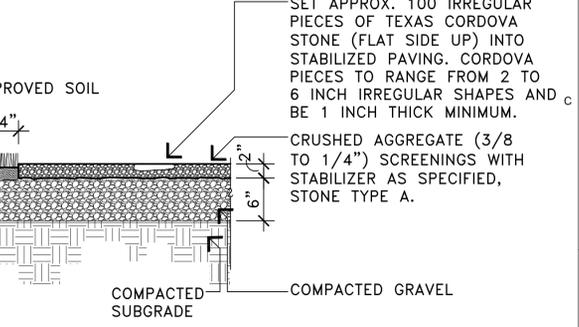

2 ADA STABILIZED PATH SECTION A
L4.2 SCALE - 1"=1'-0"

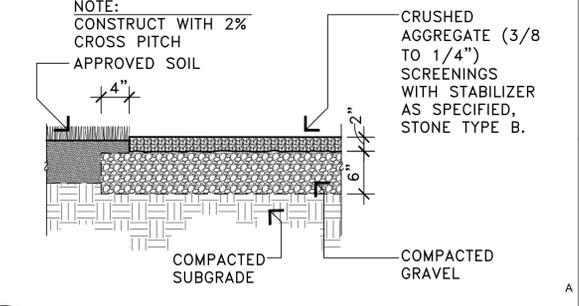

1 ADA STABILIZED PATH SECTION B
L4.2 SCALE - 1"=1'-0"

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